95% REVIEW SET

NORTHFIELD CITY HALL SAFETY/SECURITY ALTERATIONS

CITY OF NORTHFIELD 801 WASHINGTON ST. NORTHFIELD, MN 55057 OIVO

PRELIMINARY

CTION

PRELIMINARY

CONSTRUCTION

NOT FOR CONSTRUCTION

MATERIAL SYMBOLS **GENERAL NOTES LOCATION MAP** SHEET INDEX CAST IN PLACE METAL FLASHING (FLG) ALL MASONRY IS MODULAR. REFER TO DETAILS FOR BRICK AND CONCRETE MASONRY CONCRETE UNITS (CMU) COURSING TABLE. (CONC) SHEET METAL ARCHITECTURAL **ELEVATION VIEW** CROSS-REFERENCE ARCHITECTURAL DRAWINGS WITH, STRUCTURAL, MECHANICAL, A0.0 TITLE SHEET AND ELECTRICAL DRAWINGS TO ASSURE COORDINATION OF LOCATIONS, SIZES AND CONCRETE MASONRY METAL (MET) A0.1 SITE DEMOLITION, LAYOUT AND GRADING PLANS; SITE DETAILS Greenvale Ave W STEEL (STL) UNITS A1.1 REFERENCE, CODE ANALYSIS PLANS Carleton B. CONTRACTORS SHALL VERIFY ALL DIMENSIONS AND CONDITIONS AT THE SITE AND (CMU) A1.2 CONSTRUCTION SEQUENCING PLANS REPORT ANY DISCREPANCY TO THE ARCHITECT BEFORE COMMENCING ANY WORK A2.1 FIRST FLOOR DEMOLITION PLAN A2.2 SECOND FLOOR DEMOLITION PLAN 4. DO NOT SCALE DRAWINGS FOR DIMENSIONS. A3.1 FIRST FLOOR PLAN AND SCHEDULES ROUGH WOOD PRECAST A3.2 SECOND FLOOR PLAN AND SCHEDULES CONCRETE (WD) VERIFY LOCATION, SIZE AND WALL THICKNESS REQUIRED TO RECESS MECHANICAL A8.1 MISCELLANEOUS DETAILS (PCC) AND ELECTRICAL ITEMS AND MAINTAIN FIRE RATING REQUIREMENTS OF THE WALL A9.1 DOOR AND FRAME ELEVATIONS AND DETAILS (IF REQ) AT THESE BUILT-INS: UNIT HEATERS, CONVECTORS, ELECTRICAL PANELS, A11.1 INTERIOR ELEVATIONS FIRE EXTINGUISHER CABINETS, DUCTS, PIPING, AND ALL OTHER SUCH A11.2 INTERIOR ELEVATIONS AND DETAILS RECESSES (VERIFY). FINISHED FACE BRICK A13.1 FIRST FLOOR REFLECTED CEILING PLAN AND DETAILS (FB) HARDWOOD . MECHANICAL & ELECTRICAL CONTRACTORS SHALL FURNISH EQUIPMENT REQUIRED A13.2 SECOND FLOOR REFLECTED CEILING PLAN (HDWD) FOR ANY CEILING OR WALL ACCESS PANELS. OTHERS SHALL INSTALL OR BUILD IN ALL SUCH ACCESS PANELS (UNLESS OTHERWISE NOTED). . VERIFY ELEVATION OF ALL FLOOR SLAB DEPRESSIONS REQUIRED TO RECEIVE FLOOR STONE PLYWOOD MATERIAL PER FINISH SCHEDULE AND DETAILS. (PWD) MECHANICAL 5th St.W. M1.1 MECHANICAL DEMOLITION PLANS 8. EXTEND ALL NONBEARING CMU PARTITIONS TO UNDERSIDE OF STRUCTURE OR METAL M2.1 MECHANICAL PLANS DECK AND SEAL WITH SOFT JOINT PER DETAIL (UNLESS OTHERWISE NOTED). ACOUSTICAL TILE (ACT) 9. ALL INTERIOR MASONRY PARTITIONS SHALL BE 8" THICK (UNLESS OTHERWISE NOTED) BITUMINOUS Northfield Golf Club CERAMIC TILE (CT) (BIT) Riverside Lions Park 10. ALL WOOD FRAMING AND BLOCKING CONCEALED IN CEILINGS AND PARTITIONS SHALL QUARRY TILE (QT) BE FIRE RETARDANT TREATED (UNLESS OTHERWISE NOTED). E0.0 ELECTRICAL TITLE SHEET & SYMBOLS SCHEDULE SIGNATURE / SEAL ED1.1 ELECTRICAL DEMOLITION PLANS EARTH PLASTER (PLAS) E1.1 FIRST & SECOND FLOOR LIGHTING PLANS STUCCO E2.1 FIRST & SECOND FLOOR POWER PLANS 28 GYPSUM BOARD (GBD) Woodley St W E4.1 FIRST & SECOND FLOOR SYSTEMS PLANS STEEL STUD PARTITION POROUS FILL chler Park STONE OR GRAVEL (PLAN VIEW) NOT FOR CMU PARTITION INSULATION WALL (PLAN VIEW) MODULAR EXPLANATION PROJECT INFORMATION EXG TO REMAIN INSULATION POCHE (HALF TONE) OWNER LEGEND MODULAR DIMENSION CONTACTS: CITY OF NORTHFIELD JAYSON DWELLE, 801 WASHINGTON ST. **ACTUAL DIMENSION** FACILITIES MANAGER DRAWN BY (A101) **ROOM NUMBER** NORTHFIELD, MN 55057 MB > (1/2 JOINT=3/16") NEW DOOR (NUMBER RELATES TO ROOM NO.) ARCHITECT AND ENGINEERS REFER TO DOOR SCHED A100 1 ARMSTRONG, TORSETH, SKOLD, AND RYDEEN, INC. EXISTING WALL AND DOOR ISSUED FOR 8501 GOLDEN VALLEY ROAD, SUITE 300 95% REVIEW SET GOLDEN VALLEY, MINNESOTA 55427 PHONE: 763-545-3731 FAX: 763-525-3289 $\begin{array}{c} \begin{array}{c} 1 \\ A1.1 \end{array}$ **ELEVATION OR DETAIL NUMBER SHEET** — ACTUAL D**I**M 3/16"(1/2JT) ARCHITECTURE/PROJECT MGR: NANCY LABISSONIERE, AIA MAY 26, 2021 WALL SECTION NUMBER MODULAR DIM SHEET NAME SPECIFICATIONS: JOE ANTON SHEET NUMBER MECHANICAL ENGINEER: BLAYNE PARKOS, PE SHEET NUMBER OF EXITING ELECTRICAL ENGINEER: NICK ACHINA, PE NAME OCCUPANTS PLAN GRID LINES ARE 4' - 0" OC UNLESS OTHERWISE NOTED. TECHNOLOGY ENGINEER: DAVID BRIDGES GRID / UNIT MATCHLINE ARROWS -- INDICATE DIMENSIONS TO NOMINAL FACE OF MODULAR MATERIALS, TO CENTER LINES AND TO GRID LINES. ATS&R PROJECT NO. DOTS - INDICATED DIMENSIONS TO ACTUAL SURFACE OR FACE 20031.1 PLAN NOTE OF MATERIALS. FLOOR GRID ELEVATIONS ARE GIVEN TO A POINT 3/16" (1/2 MORTAR JOINT) REVISION NO. FOOD SERVICE EQUIPMENT ITEM ABOVE ACTUAL FLOOR SLAB. REFER TO DETAILS. ALL MASONRY IS MODULAR. REFER TO DETAILS FOR BRICK AND CONCRETE MASONRY UNITS (CMU) COURSING TABLE. SHEET NUMBER

ALL CAST IN PLACE CONCRETE COLUMNS AND WALLS SHALL CONFORM

TO THE ABOVE EXPLANATION.

ATSR

8501 GOLDEN VALLEY ROAD
SUITE 300
MINNEAPOLIS, MINNESOTA 55427


TEL: 763 . 545 . 3731 FAX: 763 . 525 . 3289 WEB: www.atsr.com

C Armstrong, Torseth, Skold & Rydeen, Inc 2

REVISIONS

^ ^ ^

A0.0

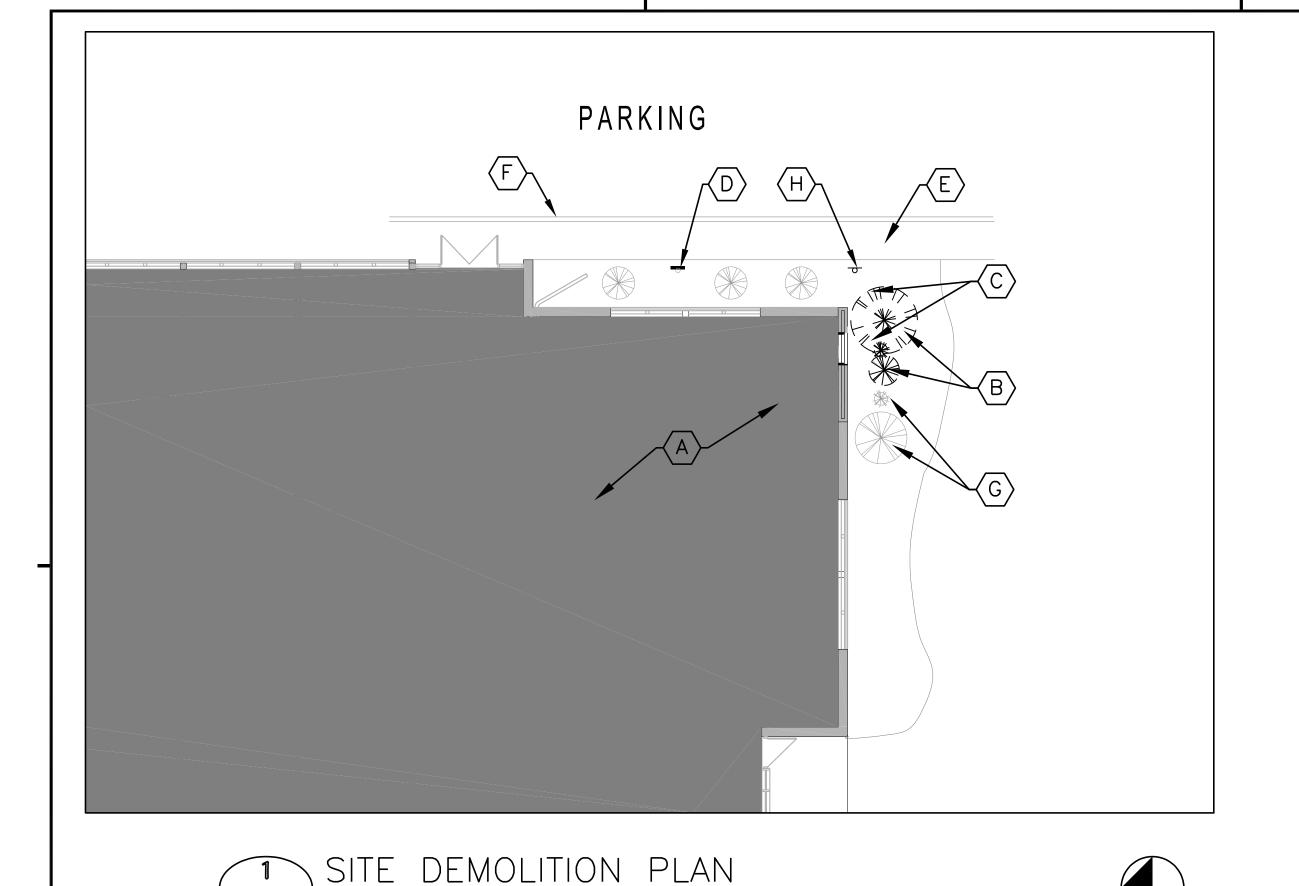

SITE DEMOLITION GENERAL NOTES

PLAN

ELEVATION

ARE COMPLETED.

A0.1 | SCALE: 1"=10'

CONTRACTOR SHALL BE RESPONSIBLE TO VISIT THE SITE AND BE COMPLETELY FAMILIAR WITH SITE FEATURES, ELEMENTS AND ACCESS. NO ADDITIONAL COMPENSATION WILL BE PROVIDED BY THE OWNER FOR THOSE SITE FEATURES, ELEMENTS AND ACCESS ISSUES WHICH ARE READILY KNOWN THROUGH A SITE VISIT. THE CONTRACTOR SHALL BE RESPONSIBLE TO DOCUMENT THE AS-BUILT SITE ELEMENTS, SITE FEATURES

AND GRADES. CONTRACTOR SHALL COORDINATE ALL WORK IN THE R.O.W. AND PARK PROPERTY WITH THE CITY OF NORTHFIELD. CONTRACTOR TO FOLLOW CITY OF NORTHFIELD STANDARD PLATES AND SPECIFICATIONS IN THE R.O.W. AND WITHIN THE CITY'S PROPERTY.

IN ACCORDANCE WITH STATE LAW, PRIOR TO EXCAVATION OR GRADING ON ANY SITE: UTILITIES MUST BE LOCATED. CALL GOPHER STATE ONE CALL AT 1-800-252-1166 OR 651-454-0002 TO SCHEDULE UTILITY LOCATIONS FOR THIS SITE. [MS 216D.01-216D.07]

CONTRACTOR SHALL HAVE ALL UNDERGROUND PUBLIC AND PRIVATE UTILITIES LOCATED PRIOR TO THE START OF ANY CONSTRUCTION ACTIVITIES.

DO NOT BEGIN CONSTRUCTION UNTIL RELATED TEMPORARY SITE EROSION CONTROL MEASURES ARE IN PLACE. NOT ALL TEMPORARY SITE EROSION CONTROL MEASURES REQUIRED MAY, OR HAVE BEEN, SHOWN ON THE CONSTRUCTION DOCUMENTS. WHETHER SHOWN OR NOT, DOES NOT RELIEVE THE CONTRACTOR OF BEING RESPONSIBLE FOR THE EROSION CONTROL MEASURES BEING INSTALLED AND/OR MAINTAINED.

CONTRACTOR SHALL PROTECT EXISTING VEGETATION AND SITE FEATURES WHICH ARE TO REMAIN. ALL SITE FEATURES DAMAGED BY CONTRACTOR (INCLUDING TURF AREAS), NOT SCHEDULED TO BE REMOVED, SHALL BE REPAIRED/REPLACED BY CONTRACTOR TO OWNERS SATISFACTION AT NO ADDITIONAL COST TO THE OWNER.

PROTECT EXISTING TREES TO REMAIN AT DRIPLINE, AND AS NECESSARY OR AS SHOWN ON THE DEMOLITION PLAN. NO CONSTRUCTION MATERIAL SHALL BE STORED OR PLACED BENEATH OR WITHIN THE TREE(S)

ALL OVERHEAD/UNDERGROUND UTILITIES NOT INDICATED TO BE REMOVED SHALL REMAIN.

ERECT PROTECTIVE FENCE PRIOR TO ANY CONSTRUCTION ACTIVITY. DO

NOT STORE ANY EQUIPMENT OR MATERIALS WITHIN THE PROTECTED

TREE PROTECTION

AREA. REMOVE THE FENCE ONLY AFTER CONSTRUCTION OPERATIONS

REMOVAL OF PAVEMENTS AND/OR CURBS SHALL INCLUDE FULL DEPTH REMOVAL OF PAVEMENT/CURBS, AND EXISTING BASE AGGREGATE MATERIAL. EXISTING BASE AGGREGATE MATERIAL SHALL BE TESTED BY OWNERS TESTING AGENT TO BE DETERMINED IF SUITABLE FOR REUSE. SEE SECTION 01 22 00 FOR ADDITIONAL

TREE DRIPLINE

PRESERVED

TREE DRIPLINE

| FENCE OUTSIDE OF

EXISTING TREES TO BE

NOT TO SCALE

DEMOLITION LEGEND

CURB REMOVALS

CONCRETE REMOVALS ---- BIO-ROLL TEMPORARY EROSION

CONTROL INLET PROTECTION TEMPORARY EROSION CONTROL

DEMOLITION PLAN KEYNOTES

- (A) PROTECT EXISTING BUILDING
- B REMOVE EXISTING TREE(S) AND SHRUB(S) INCLUDING ALL TRUNK(S) AND ROOTS. DISPOSE OF MATERIAL OFF SITE
- (C) REMOVE EXISTING LANDSCAPE EDGING AND MULCH. DISPOSE OF MATERIAL OFF SITE

E PROTECT EXISTING PAVEMENT TO REMAIN.

- (D) PROTECT EXISTING SIGNS
- $\langle \mathsf{F}
 angle$ protect curb & gutter to remain.
- $\langle \mathsf{G} \rangle$ protect existing tree(s) to remain
- H SALVAGE SIGN POST AND SIGN FOR REINSTALLATION INTO PROJECT

SITE LAYOUT & SOD A0.1 | SCALE: 1"=10'

PARKING

SITE LAYOUT GENERAL NOTES

CONTRACTOR SHALL BE RESPONSIBLE TO VISIT THE SITE AND BE COMPLETELY FAMILIAR WITH SITE FEATURES, ELEMENTS AND ACCESS. NO ADDITIONAL COMPENSATION WILL BE PROVIDED BY THE OWNER FOR THOSE SITE FEATURES, ELEMENTS AND ACCESS ISSUES WHICH ARE READILY KNOWN THROUGH A SITE VISIT.

CONTRACTOR TO COORDINATE ALL WORK IN THE R.O.W. AND CITY PROPERTY WITH THE CITY OF NORTHFIELD, MN. CONTRACTOR TO FOLLOW CITY OF NORTHFIELD, MN STANDARD PLATES AND SPECIFICATIONS IN THE R.O.W. AND CITY PROPERTY CONTRACTOR SHALL HAVE ALL UNDERGROUND PUBLIC AND PRIVATE UTILITIES LOCATED PRIOR TO

CONSTRUCTION. DO NOT BEGIN CONSTRUCTION UNTIL RELATED TEMPORARY SITE EROSION CONTROL MEASURES ARE IN PLACE, AND HAVE BEEN APPROVED BY GOVERNING AUTHORITY IF AND AS REQUIRED.

ALL DIMENSIONS ARE TAKEN FROM EXISTING FINISHED FACE OF BUILDING, UNLESS OTHERWISE NOTED. ALL COORDINATES ON RADII ARE TO CENTER OF RADIUS. ALIGN EDGES OF WALKS WITH BUILDING WALLS AND/OR STOOPS AS SHOWN, UNLESS OTHERWISE

CONTRACTOR SHALL MATCH REPLACEMENT PAVEMENTS GRADES BACK TO PRIOR/EXISTING CONDITIONS, AS SHOWN ON DRAWINGS, AND/OR SHALL MATCH UP WITH ADJOINING PAVEMENT OR SITE ELEMENTS, UNLESS OTHERWISE NOTED.

NO ADDITIONAL COMPENSATION WILL BE ALLOWED FOR COORDINATION AND SEQUENCING, DELAYS, INCONVENIENCE OR DAMAGE SUSTAINED BY THE CONTRACTOR DUE TO INTERFERENCE FROM THE UTILITIES AND APPURTENANCES OR THE OPERATIONS OF MOVING OR INSTALLING THEM.

PROTECT ALL EXISTING TREES TO REMAIN FROM CONSTRUCTION ACTIVITY. INSTALL TREE PROTECTION MEASURES AROUND ALL TREES IN IMMEDIATE VICINITY OF CONSTRUCTION ACTIVITY. CONTRACTOR SHALL BE RESPONSIBLE TO PROPER REPAIR ANY AFFECTED DISTURBED TURF, PLANTING BED, OR BARK MULCH AREAS BACK TO EXISTING GRADE AND CONDITIONS, AND/OR OWNER'S APPROVAL.

SITE LAYOUT PLAN KEYNOTES

- 1 EXISTING BUILDING
- (2) REINFORCED CONCRETE PAVEMENT (5)(3) RELOCATED EXG SIGN
- 4 BUILDING STOOP SEE ARCH PLANS
- (6) CONCRETE EXPANSION JOINT 7 PROVIDE NEW LANDSCAPE EDGING
- (8) PROVIDE NEW LANDSCAPE SHREDDED BARK MULCH
- $\overline{\langle 9 \rangle}$ restore grades and sod all disturbed areas

PARKING STEP DOWN FROM STOOP RESTORE ALL DISTURBED LANDSCAPE AND TURF FFE 100'-0' GRADES = 100.0ASSUMED DATUM

SITE GRADING PLAN A0.1 SCALE: 1"=10'

SITE GRADING PLAN GENERAL NOTES

CONTRACTOR SHALL BE RESPONSIBLE TO VISIT THE SITE AND BE COMPLETELY FAMILIAR WITH SITE FEATURES, ELEMENTS AND ACCESS. NO ADDITIONAL COMPENSATION WILL BE PROVIDED BY THE OWNER FOR THOSE SITE FEATURES, ELEMENTS AND ACCESS ISSUES WHICH ARE READILY KNOWN THROUGH A SITE VISIT.

NO SURVEY DATUM WAS ACQUIRED FOR THIS PROJECT. THE CONTRACTOR SHALL BE REQUIRED TO VERIFY AND GENERATE A EXISTING VERIFICATION PLAN FOR THE PURPOSES OF PROPERLY GRADING THE SITE AND FOR ASSURANCE THAT SITE FEATURES WILL FUNCTION PROPERLY. THE CONTRACTOR SHALL ACQUIRE OWNER'S AND ARCHITECTS APPROVAL PRIOR TO PROCEEDING WITH FINAL GRADING AND ESTABLISHMENT OF PAVEMENT GRADES. CONTRACTOR SHALL SUBMIT AS-BUILT VERIFICATION PLAN PRIOR TO THE START OF ANY CONSTRUCTION ACTIVITIES.

CONTRACTOR SHALL HAVE ALL UNDERGROUND PUBLIC AND PRIVATE UTILITIES LOCATED PRIOR TO CONSTRUCTION.

FLOOR ELEVATIONS AND/OR TO MATCH ADJOINING CONCRETE PAVEMENT AND CURBS, WHERE NECESSARY

CONTRACTOR SHALL MATCH REPLACEMENT PAVEMENTS GRADES BACK TO PRIOR/EXISTING CONDITIONS, AS SHOWN ON DRAWINGS, AND/OR SHALL MATCH UP WITH ADJOINING PAVEMENT OR SITE ELEMENTS, UNLESS OTHERWISE NOTED. CONTRACTOR SHALL BE RESPONSIBLE TO PROPERLY MATCH NEW SITE PAVEMENT ELEMENTS TO ADJOINING INTERIOR FINISHED

PROTECT ALL EXISTING TREES TO REMAIN FROM CONSTRUCTION ACTIVITY. INSTALL TREE PROTECTION MEASURES AROUND ALL TREES IN IMMEDIATE VICINITY OF CONSTRUCTION ACTIVITY.

CONTRACTOR SHALL BE RESPONSIBLE TO PROPER REPAIR ANY AFFECTED DISTURBED TURF, PLANTING BED, OR BARK MULCH AREAS BACK TO EXISTING GRADE AND CONDITIONS, AND/OR OWNER'S APPROVAL.

GRADING PLAN LEGEND

FFE - FINISH FLOOR ELEVATION

HP - HIGH POINT

LP - LOW POINT

G.B. – GRADE BREAK ME - MATCH EXISTING

出 NOR

ARCHITECTURE ENGINEERING PLANNING TECHNOLOGY

8501 GOLDEN VALLEY ROAD

TEL: 763.545.3731 FAX: 763.525.3289 WEB: www.atsr.com

CONSULTANTS

REVISIONS

SUITE 300

INTERIOR DESIGN LANDSCAPE ARCHITECTURE

MINNEAPOLIS, MINNESOTA 55427

Armstrong, Torseth, Skold & Rydeen, Inc 2021

SIGNATURE / SEAL FOR REFERENCE ONLY

NOT FOR CONSTRUCTION

KEYPLAN

DRAWN BY RJS

ISSUED FOR 95% REVIEW SET


CHECKED BY

MAY 26, 2021 SHEET NAME


SITE DEMOLITION, LAYOUT AND GRADING PLANS; SITE DETAILS

ATS&R PROJECT NO. 20031.1


REVISION NO.

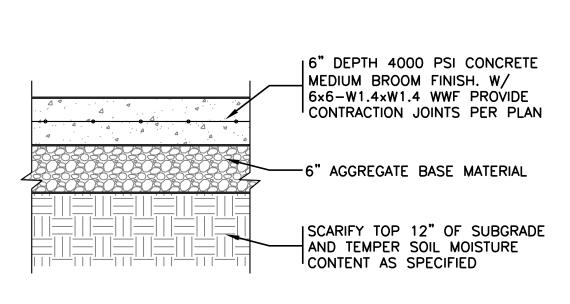




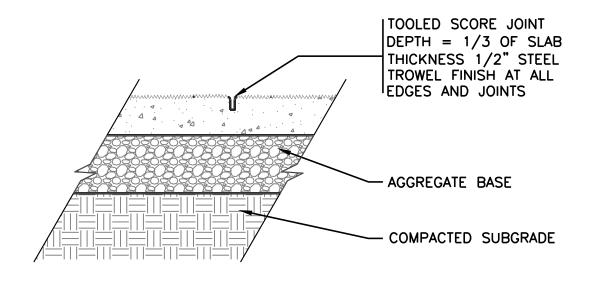



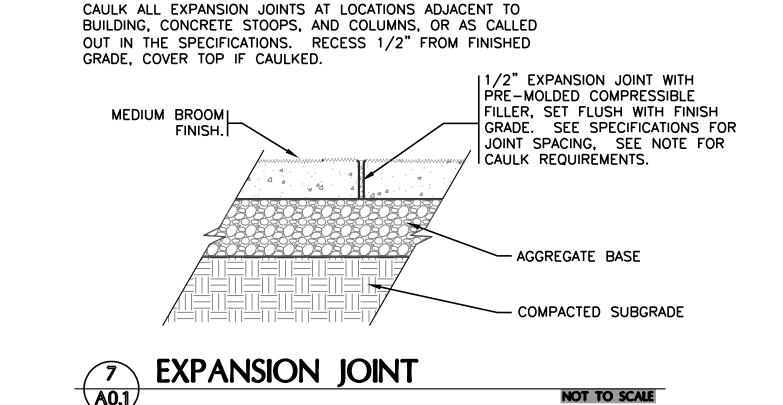

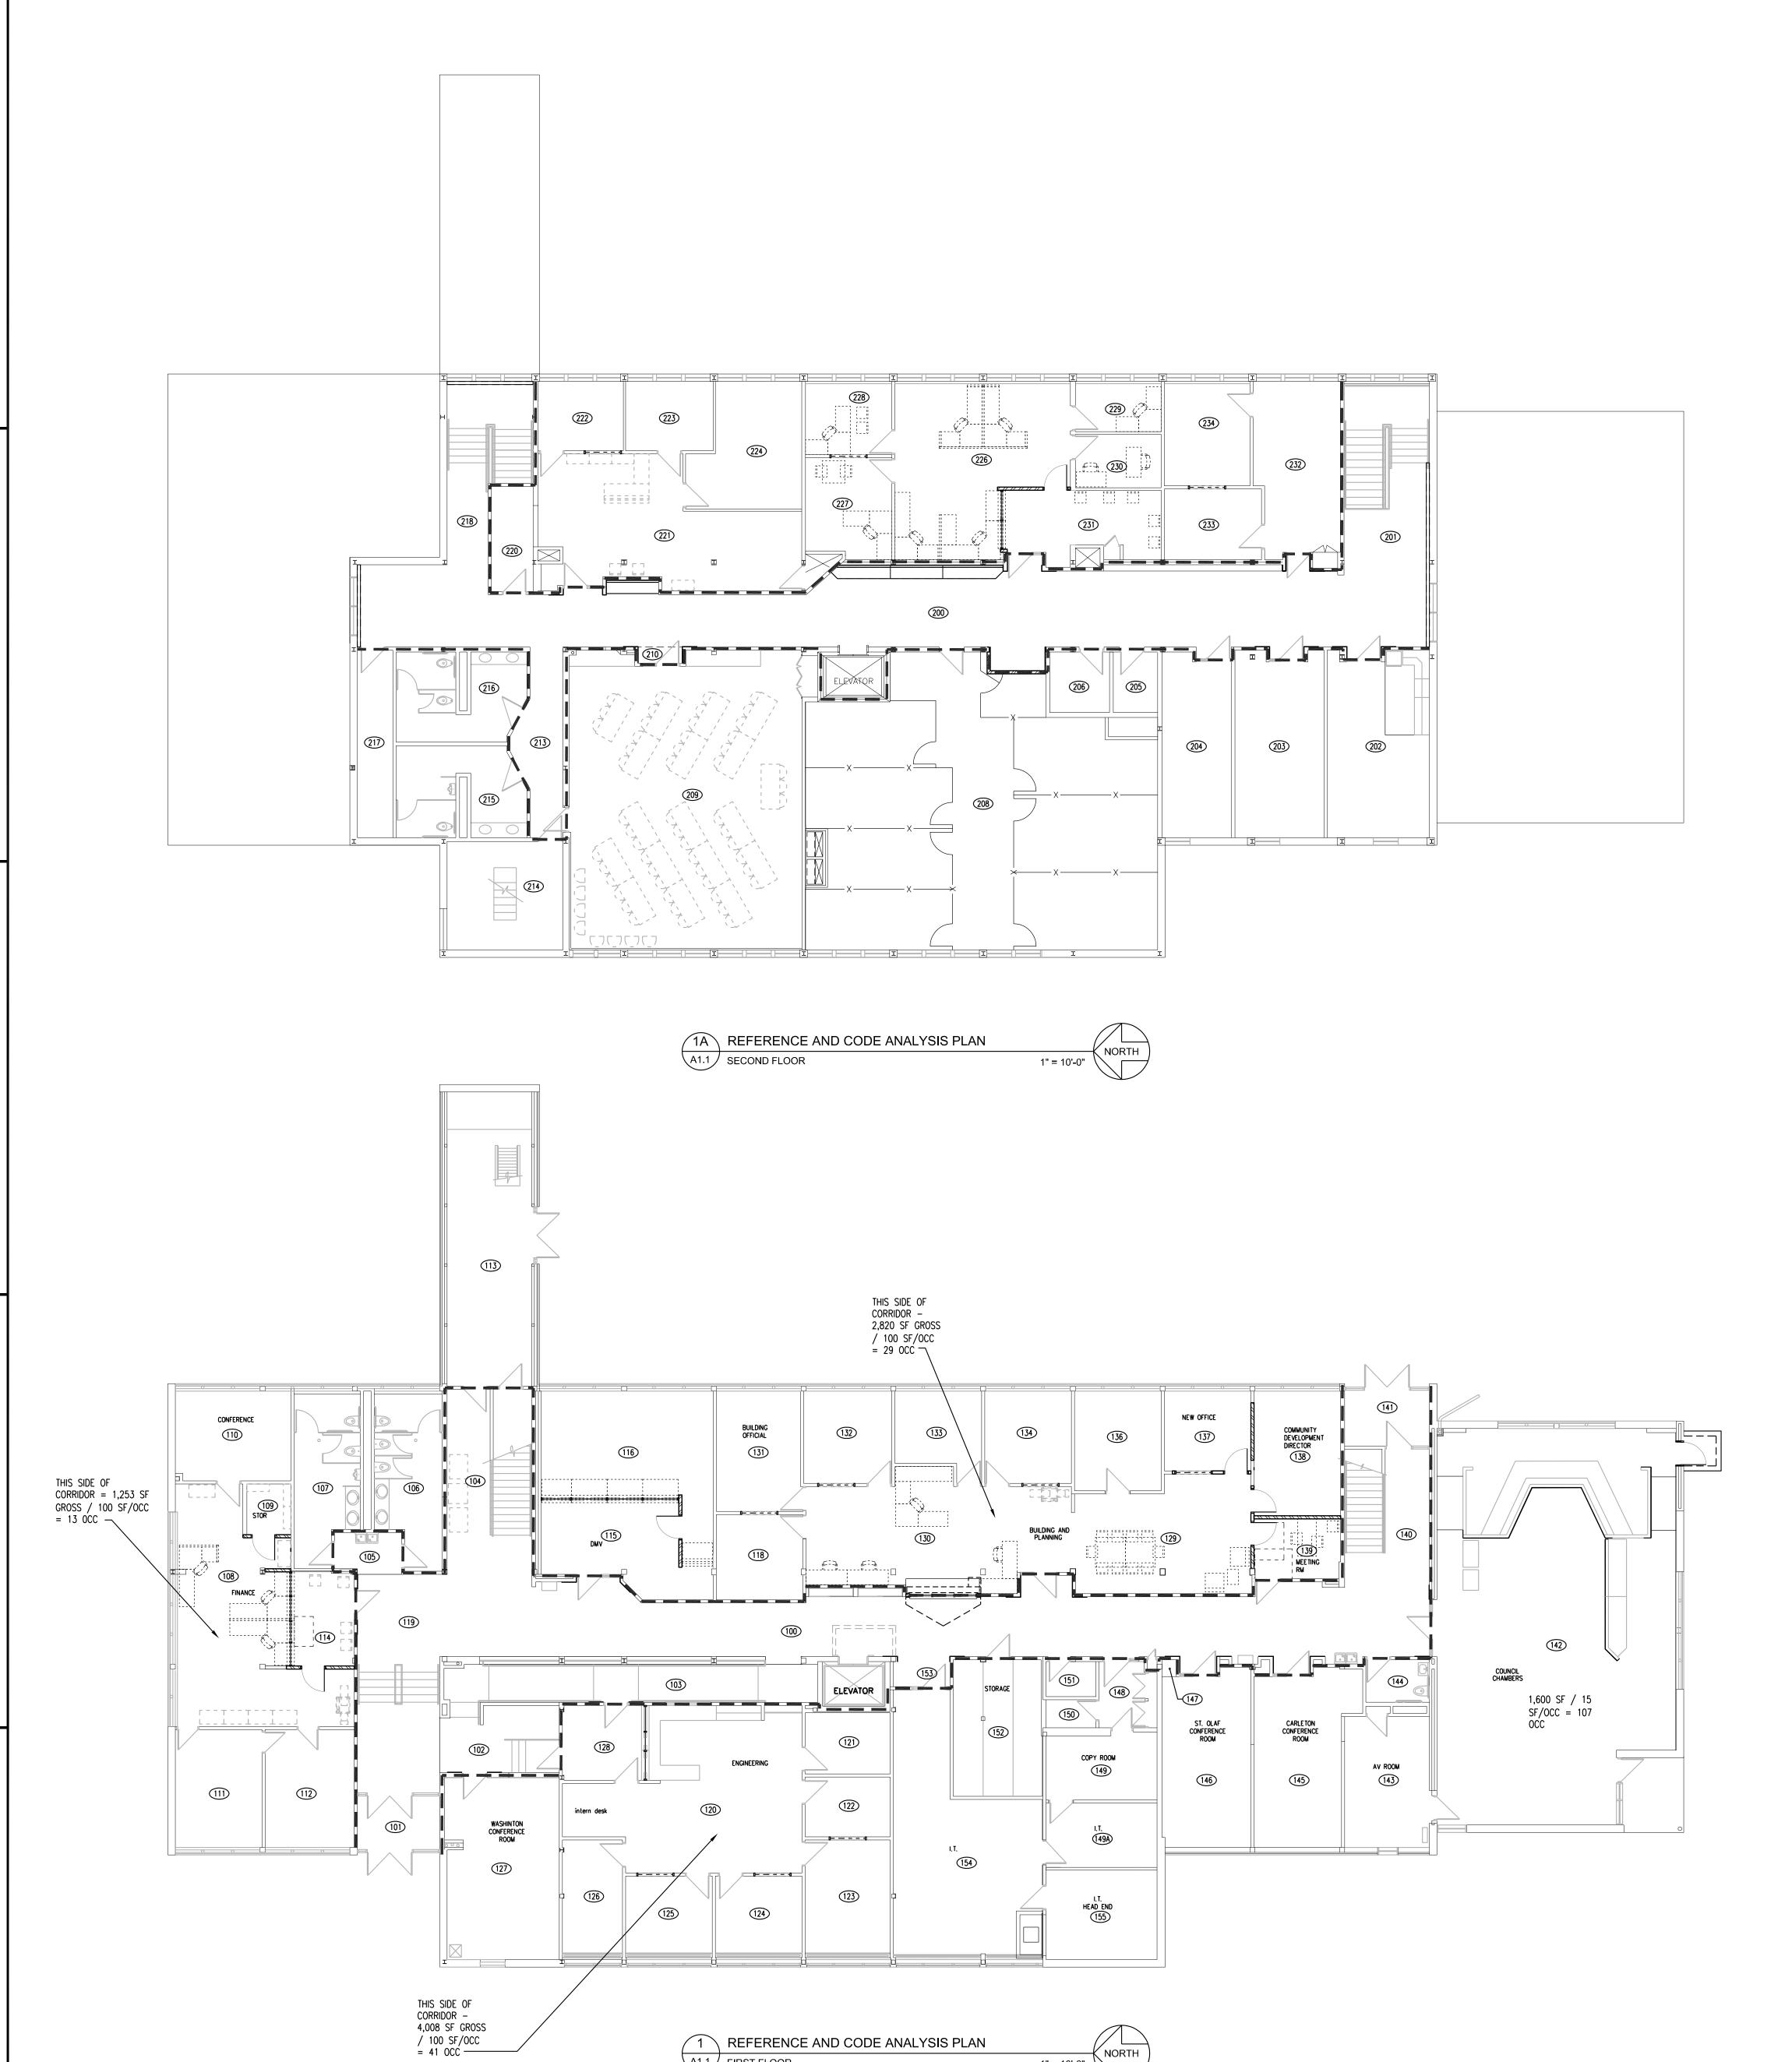

1" = 10'-0" NORTH

A1.1 FIRST FLOOR

ROOM NUMBER	ROOM NAME
100	CORRIDOR
101	VESTIBULE
102	CORRIDOR
103	RAMP
104	CORRIDOR
105	ALCOVE
106	WOMEN
107	MEN
108	FINANCE
109	STORAGE
110	CONFERENCE
111	OFFICE
112	OFFICE
113	MECHANICAL
114	WAITING
115	WAITING
116	DMV
118	OFFICE
119	CORRIDOR
120	ENGINEERING
121	PRINT ROOM
122	OFFICE
123	OFFICE
124	OFFICE
125	OFFICE
126	OFFICE
127	
128	OFFICE
129	ADMINISTRATION
130	BUILDING & PLANN'G
131	BUILDING OFFICIAL
132	OFFICE
133	OFFICE
134	OFFICE
136	OFFICE
137	OFFICE
138	COMM DEV DIR
139	MEETING
140	CORRIDOR
141	VESTIBULE
142	COUNCIL CHAMBERS
143	AUDIO - VISUAL
144	UNISEX
145	CONFERENCE
146	CONFERENCE
147	CLOSET
148	ENTRY
149	COPY
149A	I.T.
150	STORAGE
151	JANITOR
152	STORAGE
153	ALCOVE
15/	I.T.

ROOM NUMBER	ROOM NAME
200	CORRIDOR
201	CORRIDOR
202	BREAK
203	CONFERENCE
204	OFFICE
205	JANITOR
206	ELEV EQUIP
208	STORAGE
209	TRAINING
210	ENTRY
213	HALLWAY
214	MECHANICAL
215	MENS
216	WOMENS
217	STORAGE
218	CORRIDOR
220	STORAGE
221	OFFICE
222	OFFICE
223	OFFICE
224	OFFICE
226	HUMAN RESOURC
227	OFFICE
228	OFFICE
229	OFFICE
230	T.V.
231	MEETING
232	OFFICE
233	OFFICE
234	OFFICE

GOVERNING CODES

I.T. HEAD END

2020 MINNESOTA BUILDING CODE 2020 MINNESOTA ENERGY CODE (ASHRAE 90.1-2016) 2020 MINNESOTA FIRE CODE 2020 MINNESOTA ACCESSIBILITY CODE 2015 MINNESOTA PLUMBING CODE 2020 MINNESOTA MECHANICAL AND FUEL GAS CODE 2020 NATIONAL ELECTRICAL CODE

CODE PLAN GENERAL NOTES

- . BUILDING IS TYPE IIB, NON-SPRINKLED, B OCCUPANCY.
- 2. EXISTING 1-HOUR CORRIDORS ARE BEING MAINTAINED WHERE THEY ARE AFFECTED BY CONSTRUCTION.
- 3. NO CHANGE TO EXISTING BUILDING EXITING. 4. BUILDING IS FULLY ACCESSIBLE: PARKING, TOILETS, ACCESSIBLE ROUTE, SO 20% RULE DOES

NOT APPLY AS ACCESSIBILITY HAS BEEN FULLY

LEGEND:

- - EXISTING FIRE PARTITION (NEW AT NEW CONSTRUCTION ON CORRIDOR WALLS): 1 HR WITH 20 MINUTE DOORS, 45 MINUTE WINDOWS, 1.5 HOUR FIRE/SMOKE DAMPER, WIRE GLAZING - 100 SQ IN MAX (IBC TABLES 715.4, 715.5 & 715.5.3). FIRE DAMPERS (ONLY) MAY BE ELIMINATED PER 716.5.2

INTERIOR DESIGN LANDSCAPE ARCHITECTURE 8501 GOLDEN VALLEY ROAD SUITE 300

ARCHITECTURE ENGINEERING

MINNEAPOLIS, MINNESOTA 55427 TEL: 763.545.3731 FAX: 763.525.3289 WEB: www.atsr.com

Armstrong, Torseth, Skold & Rydeen, Inc 2021 CONSULTANTS

REVISIONS

SIGNATURE / SEAL

FOR ONLY

NOT FOR CONSTRUCTION

KEYPLAN

DRAWN BY MB

CHECKED BY NAL


ISSUED FOR 95% REVIEW SET

MAY 26, 2021 SHEET NAME

REFERENCE, CODE ANALYSIS PLANS

ATS&R PROJECT NO. 20031.1

REVISION NO.

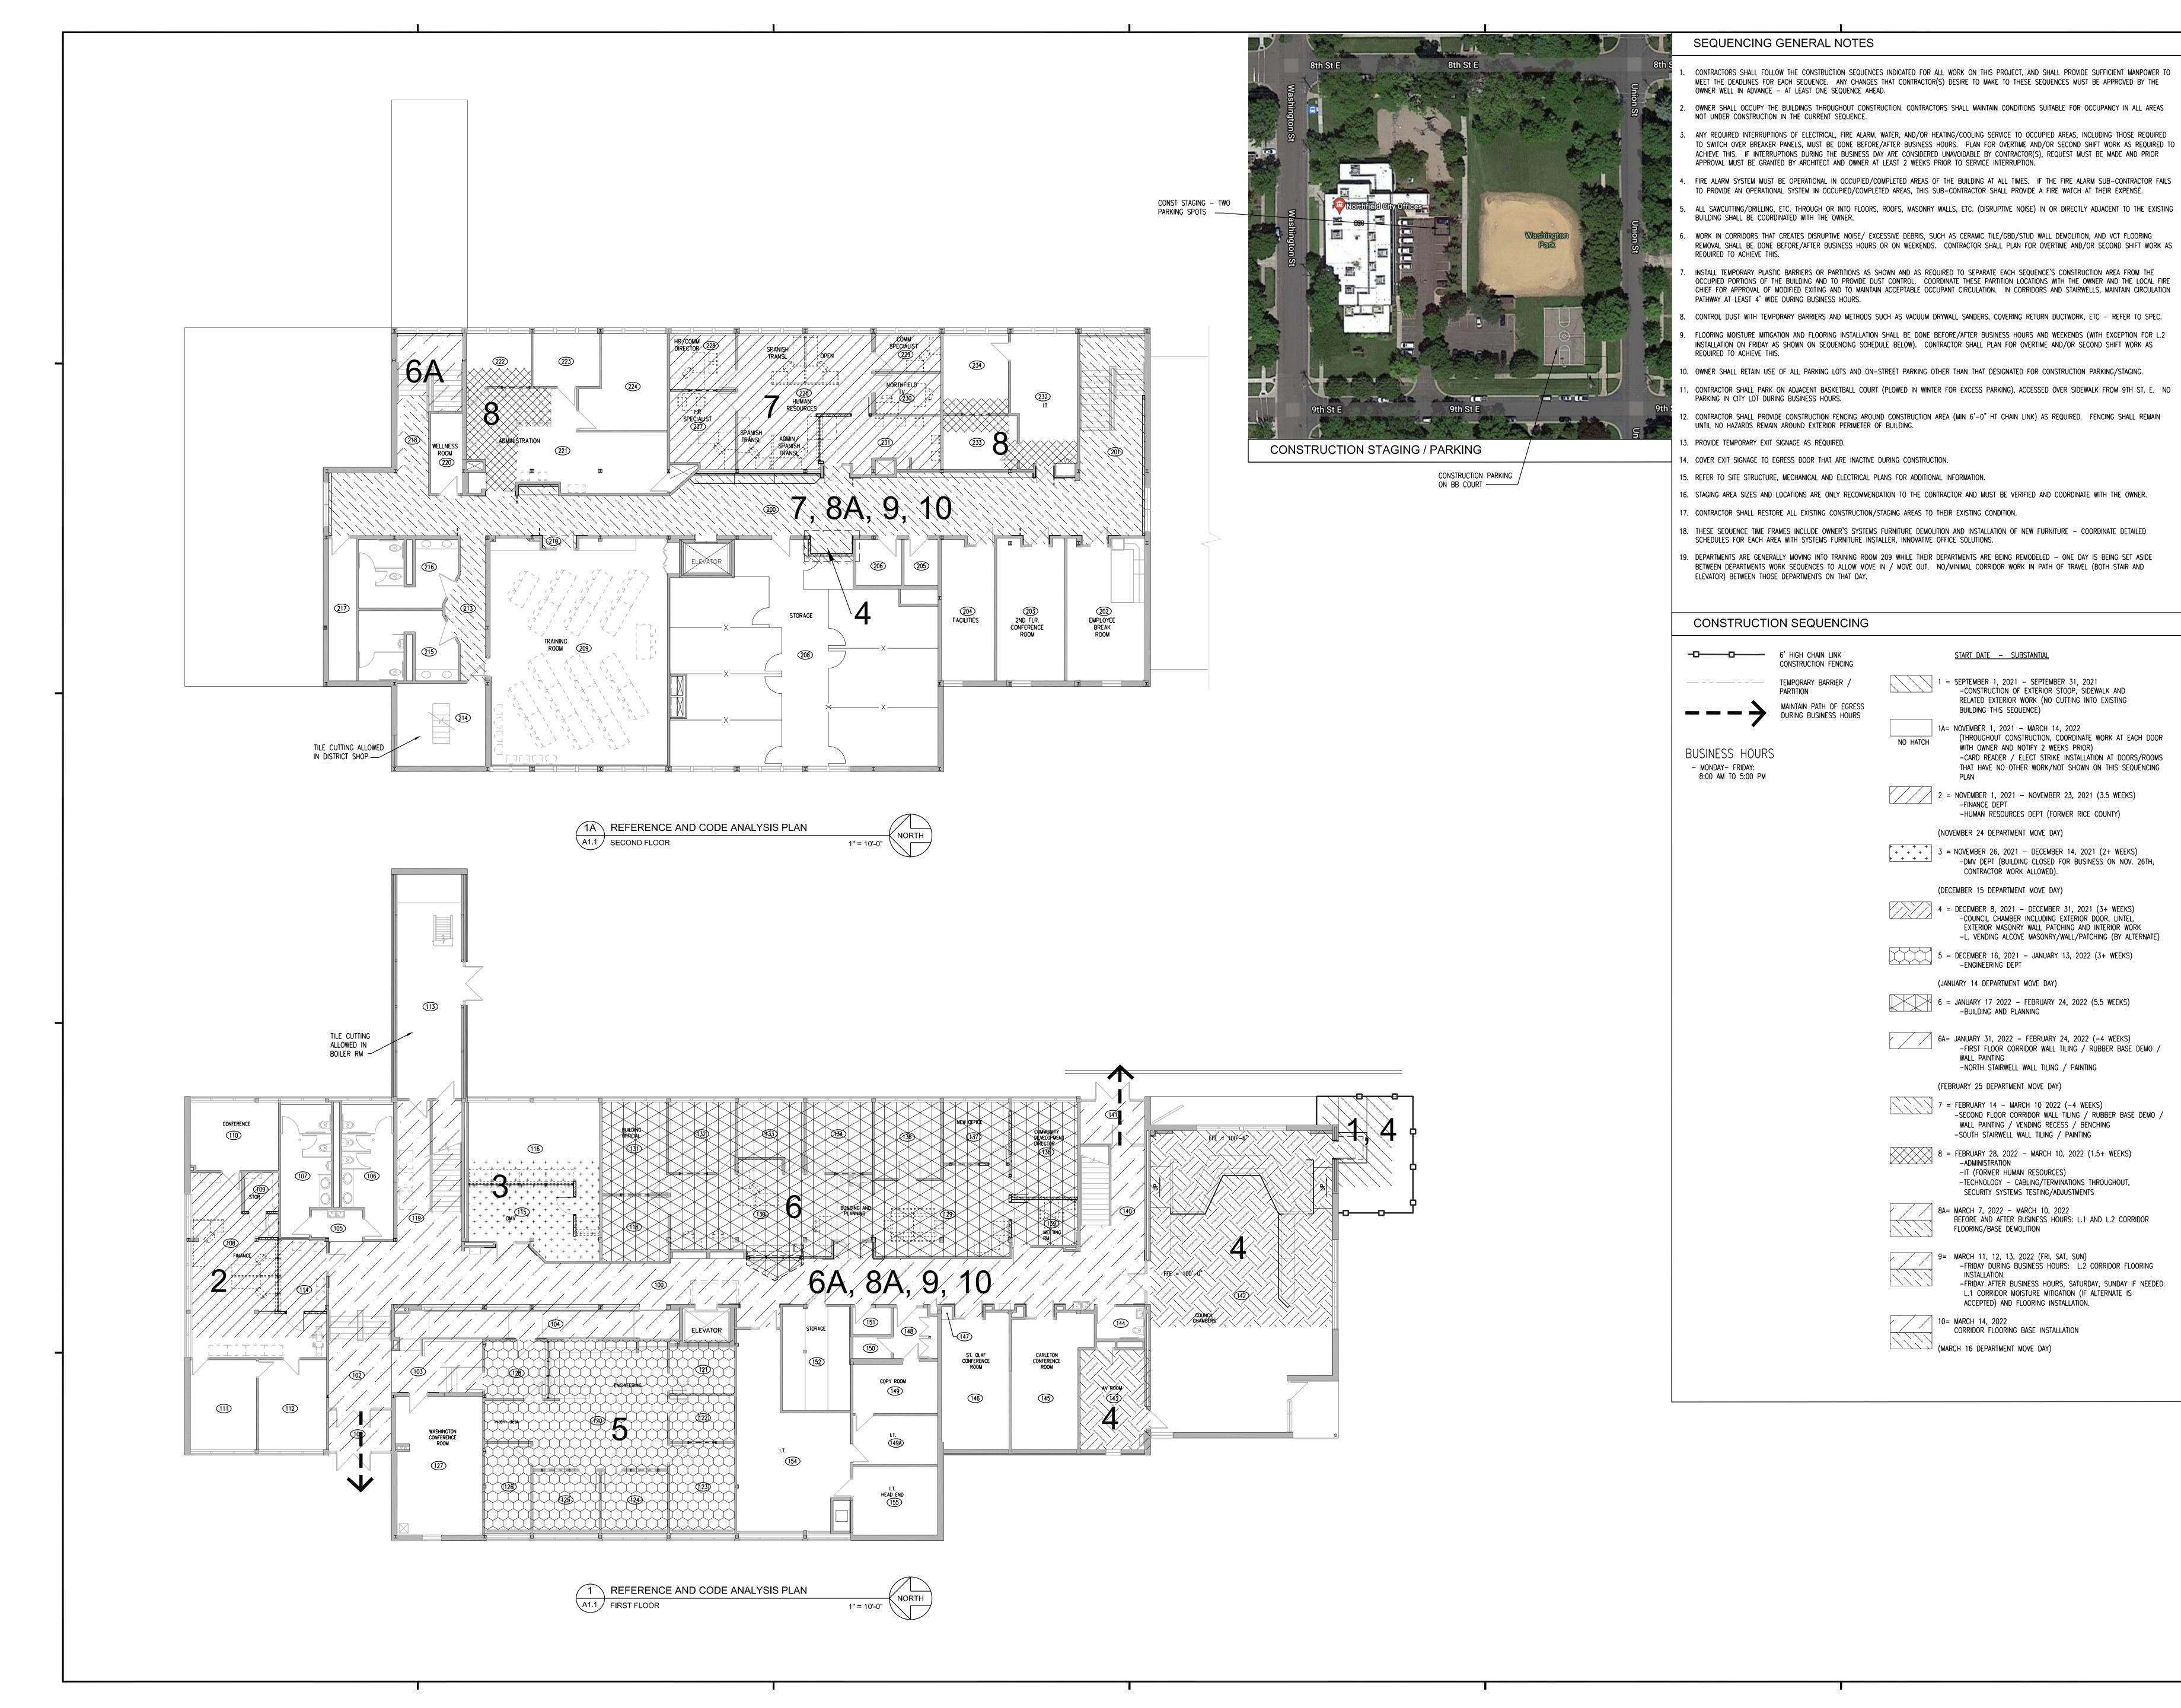

ARCHITECTURE ENGINEERING PLANNING TECHNOLOGY INTERIOR DESIGN LANDSCAPE ARCHITECTURE

8501 GOLDEN VALLEY ROAD

SUITE 300

MINNEAPOLIS, MINNESOTA 55427

TEL: 763.545.3731 FAX: 763.525.3289 WEB: www.atsr.com

Armstrong, Torseth, Skold & Rydeen, Inc 2021

CONSULTANTS

REVISIONS

NON

SIGNATURE / SEAL FOR

> REFERENCE ONLY

NOT FOR CONSTRUCTION

KEYPLAN

DRAWN BY

ISSUED FOR

CHECKED BY

95% REVIEW SET

ISSUE DATE MAY 26, 2021 SHEET NAME

CONSTRUCTION SEQUENCING PLANS

ATS&R PROJECT NO 20031.1

SHEET NUMBER

REVISION NO.



1/8" = 1'-0"

GENERAL DEMOLITON NOTES

- ALL OPENINGS CUT INTO EXISTING MASONRY WALLS SHALL BE LARGE ENOUGH TO RECEIVE LINTEL ABOVE AND MASONRY AT JAMBS AND SILL TO MATCH EXISTING ADJACENT MATERIALS. REFER TO FLOOR PLANS FOR FINISHED OPENING DIMENSIONS.
 INFORMATION FROM EXISTING DRAWINGS HAS BEEN USED IN THE PREPARATION OF THESE DOCUMENTS. CONTRACTORS SHALL VERIFY ALL INFORMATION RELATING TO THE WORK, INCLUDING BUT NOT LIMITED TO THE LOCATION OF EXISTING BUILDING UTILITIES.
- 3. REFER TO OTHER ARCHITECTURAL DRAWINGS AND TO STRUCTURAL, MECHANICAL AND ELECTRICAL DRAWINGS FOR ADDITIONAL DEMOLITION AND ALTERATION
- INFORMATION.

 4. REMOVE & SALVAGE ALL DESIRED EQUIPMENT AND FIXTURES PRIOR TO COMMENCEMENT OF DEMOLITION. PROVIDE TEMPORARY LIGHTING AND POWER BY
- ELECTRICAL CONTRACTOR.

 5. NOTIFY THE OWNER OF THE PRESENCE OF HAZARDOUS MATERIAL(S) IN WORK AREAS.

1 FIRST FLOOR

A2.1 DEMOLITION PLAN

- 6. EACH CONTRACTOR DISCIPLINE SHALL SAWCUT & REMOVE PORTIONS OF EXISTING FLOORS, WALLS, CEILINGS & ROOF AS REQUIRED TO ACCOMMODATE THEIR WORK (COORDINATE WORK W/OTHER RELATED CONTRACTOR DISCIPLINES). GENERAL CONTRACTOR SHALL PATCH ADJACENT SURFACES TO MATCH.
- 7. WHEN EXISTING WALLS, CASEWORK, AND OTHER ELEMENTS ARE REMOVED, PATCH ALL EXG-TO-REMAIN ADJACENT SURFACES TO MATCH EXISTING, TO ACHIEVE CLEAN, MATCHING ADJACENT SURFACE TEXTURES. THIS INCLUDES GRINDING AND PATCHING OF FLOORS AND WALLS THAT MAY BE REQUIRED AT REMOVED MASONRY WALLS.
- 8. COORDINATE DEMOLITION OF WALLS WHICH INCLUDE EXISTING ELECTRICAL PANELS WITH ELECTRICAL CONTRACTOR.
- 9. CONTRACTOR SHALL COORDINATE DEMOLITION WORK WITH NOT-IN-CONTRACT SYSTEMS FURNITURE SUPPLIER, WHO WILL BE DEMOLISHING EXISTING SYSTEMS FURNITURE IN WORK AREAS.
- 10. SEE ROOM FINISH SCHEDULES ON FLOOR PLAN SHEETS FOR EXISTING WALL, FLOOR, & CEILING MATERIALS
- 11. AT WALLS TO BE TILED, REMOVE ALL EXISTING EQUIPMENT & DEVICES (DOOR STOPS, HOLD OPENS, SIGNAGE, ETC), AS REQUIRED FOR TILING WORK. REINSTALL AT SAME LOCATION UNLESS CALLED TO BE DEMOLISHED. REPLACE ANY ITEMS DAMAGED BY REMOVAL WITH EQUAL. ELECT SHALL REMOVE & REINSTALL ALL EXIST—TO—REMAIN ELECT DEVICES & PROVIDE EXTENSION RINGS AS REQUIRED.

DEMOLITION PLAN NOTES

- A1) REMOVE PORTION OF EXG MAS WALL AS REQ FOR NEW DOOR FRAME, LINTEL AND JAMBS SEE FLOOR PLAN AND DETAILS.
- REMOVE EXG GBD AND STL STUD PARTITION FROM FLOOR TO UNDERSIDE OF DECK. PATCH ALL ADJACENT SURFACES TO MATCH EXG.
- REMOVE PORTION OF EXC GBD AND STL STUD PARTITION AS REQ FOR NEW WINDOW, AND REQUIRED STUD FRAMING AROUND NEW OPENING, INCLUDING LOW WALL SUPPORT BELOW WINDOW SEE FLOOR PLAN AND WINDOW DETAILS. PATCH GBD, STUDS, AND BATT INS TO MATCH EXISTING.
- REMOVE PORTION OF EXG GBD AND STL STUD PARTITION AS REQ FOR NEW WINDOW AND REQUIRED STUD FRAMING AROUND NEW OPENING. REFER TO
- WINDOW DETAILS. PATCH GBD, STUDS, AND BATT INS TO MATCH EXISTING.

 WITH REMOVAL OF CERAMIC TILE, VERIFY CONDITION OF REMAINING GBD. IF PAPER FACE HAS COME OFF, REMOVE GBD OUT TO NEXT STUD. PATCH WITH GBD WHERE IT WILL BE EXPOSED (NO NEW PCT), WHERE IT WILL BE COVERED WITH NEW PCT (SEE ELEVATIONS), PATCH WITH 5/8" TILE BACKER BOARD. REMOVE AND REINSTALL EXG CEILING AS REQUIRED FOR THIS, MINIMIZE CEILING REMOVAL AS MUCH AS POSSIBLE. IF REMOVAL OF EXG

CERAMIC TILE CAUSES ONLY VERY MINOR DAMAGE TO PAPER FACE, AND CONTRACTOR FEELS THAT NEW TILE CAN BE INSTALLED SUCCESSFULLY OVER IT,

B1 REMOVE EXG DOOR & HM FRAME.

ARCHITECT WILL REVIEW CONDITION - IF ARCHITECT AGREES, EXISITNG GBD CAN REMAIN.

- B2 REMOVE EXG WD DOOR & HM FRAME AND SALVAGE DOOR, FRAME AND HARDWARE FOR REINSTALLATION IN SAME ROOM. SEE FLOOR PLAN.
- C1 REMOVE EXG VINEER PLYWOOD AND WOOD TRIM REFER TO DEMOLITION DETAILS
- REMOVE EXG CARPETING AND PORTION OF PLYWD/WD FRAMING UNDERNEATH TO REVISE BENCHING REFER TO FLOOR PLAN AND DETAIL
- EXISTING FIN TUBE RADIATION COVER REMOVED AND REINSTALLED BY MC FOR NEW TILE WORK REFER TO MECHANICAL DRAWINGS.
- F1 REMOVE VCT FLOORING & BASE PREP FOR NEW FLOOR FINISH
- F2 REMOVE AND REINSTALL EXG MODULAR CPT AS REQUIRED FOR NEW WALL. CUT/REMOVE/REINSTALL PORTION OF EXG RUBBER BASE AS REQ.
- F3 REMOVE EXT MODULAR CPT AND RUBBER BASE AND PREP FOR NEW FLOOR FINISH
- $\overline{\left\langle \mathsf{F4} \right\rangle}$ REMOVE EXT MODULAR CPT AND RUBBER BASE. SALVAGE CARPET FOR REINSTALLATION IN ADJACENT SPACE. PREP FLOOR FOR NEW FLOOR FINISH
- $\langle {\sf F5}
 angle$ by alternate, remove ext broadloom CPT and Rubber base and PREP for New Floor Finish
- F6 REMOVE EXG CT BASE (EXG CT FLOOR TO REMAIN).
- REMOVE EXG ACT CLG & GRID IN ITS ENTIRETY. SALVAGE CEILING TILES FOR PATCHING AT OTHER LOCATIONS.
- (H2) REMOVE AND REINSTALL EXG ACT CEILING AS REQ FOR WORK
- (H3) REMOVE PORTION OF EXG GBD CEILING AND PREP FOR PATCHING INTO NEW WALL LOCATION.
- $\overline{\left\langle \text{H4} \right\rangle}$ REMOVE EXG ACT CLG & GRID AS REQIURED FOR NEW GBD SOFFIT. SALVAGE CEILING TILES FOR PATCHING.
- L1) PREP EXG CT WAINSCOT TO RECEIVE NEW PCT OVER EXG REFER TO ELEVATIONS.
- \(\sum_{L2}\) REMOVE EXG FULL HT CT
- $\overline{\langle L3 \rangle}$ REMOVE EXG CT ON EAST SIDE AND TOP OF LOW WALL/CURB (±6" H. AT MAIN CORRIDOR SIDE). EXG RAILING TO REMAIN.
- M1) REMOVE EXG PROJECTING 'BLADE' SIGNAGE, PATCH WALL, PREP FOR NEW SIGNAGE AS SHOWN ON ELEVATIONS.
- SYSTEMS FURNITURE CONTRACTOR (OWNER'S SEPARATE CONTRACT) WILL REMOVE EXISTING SYSTEMS FURNITURE. ELECTRICAL CONTRACTOR SHALL DISCONNECT EXISTING POWER AND DATA AS REQUIRED.

ATSR

ARCHITECTURE ENGINEERING
PLANNING TECHNOLOGY
INTERIOR DESIGN LANDSCAPE ARCHITECTURE

8501 GOLDEN VALLEY ROAD SUITE 300 MINNEAPOLIS, MINNESOTA 55427

TEL: 763 . 545 . 3731 FAX: 763 . 525 . 3289 WEB: www.atsr.com

CONSULTANTS

Armstrong, Torseth, Skold & Rydeen, Inc 2021

REVISIONS

NORTHFIELD CITY HALI
SAFETY / SECURITY
ALTERATIONS
CITY OF NORTHFIELD
S01 WASHINGTON STREET

SIGNATURE / SEAL

ONLY NOT FOR

REFERENCE

KEYPLAN

DRAWN BY A B C

CHECKED BY
DEF

ISSUED FOR
95% REVIEW SET

ISSUE DATE
MAY 26, 2021
SHEET NAME


FIRST
FLOOR DEMOLITION
PLAN

ATS&R PROJECT NO. 2 0 0 3 1 . 1

REVISION NO.

SHEET NUMBER

A2.1

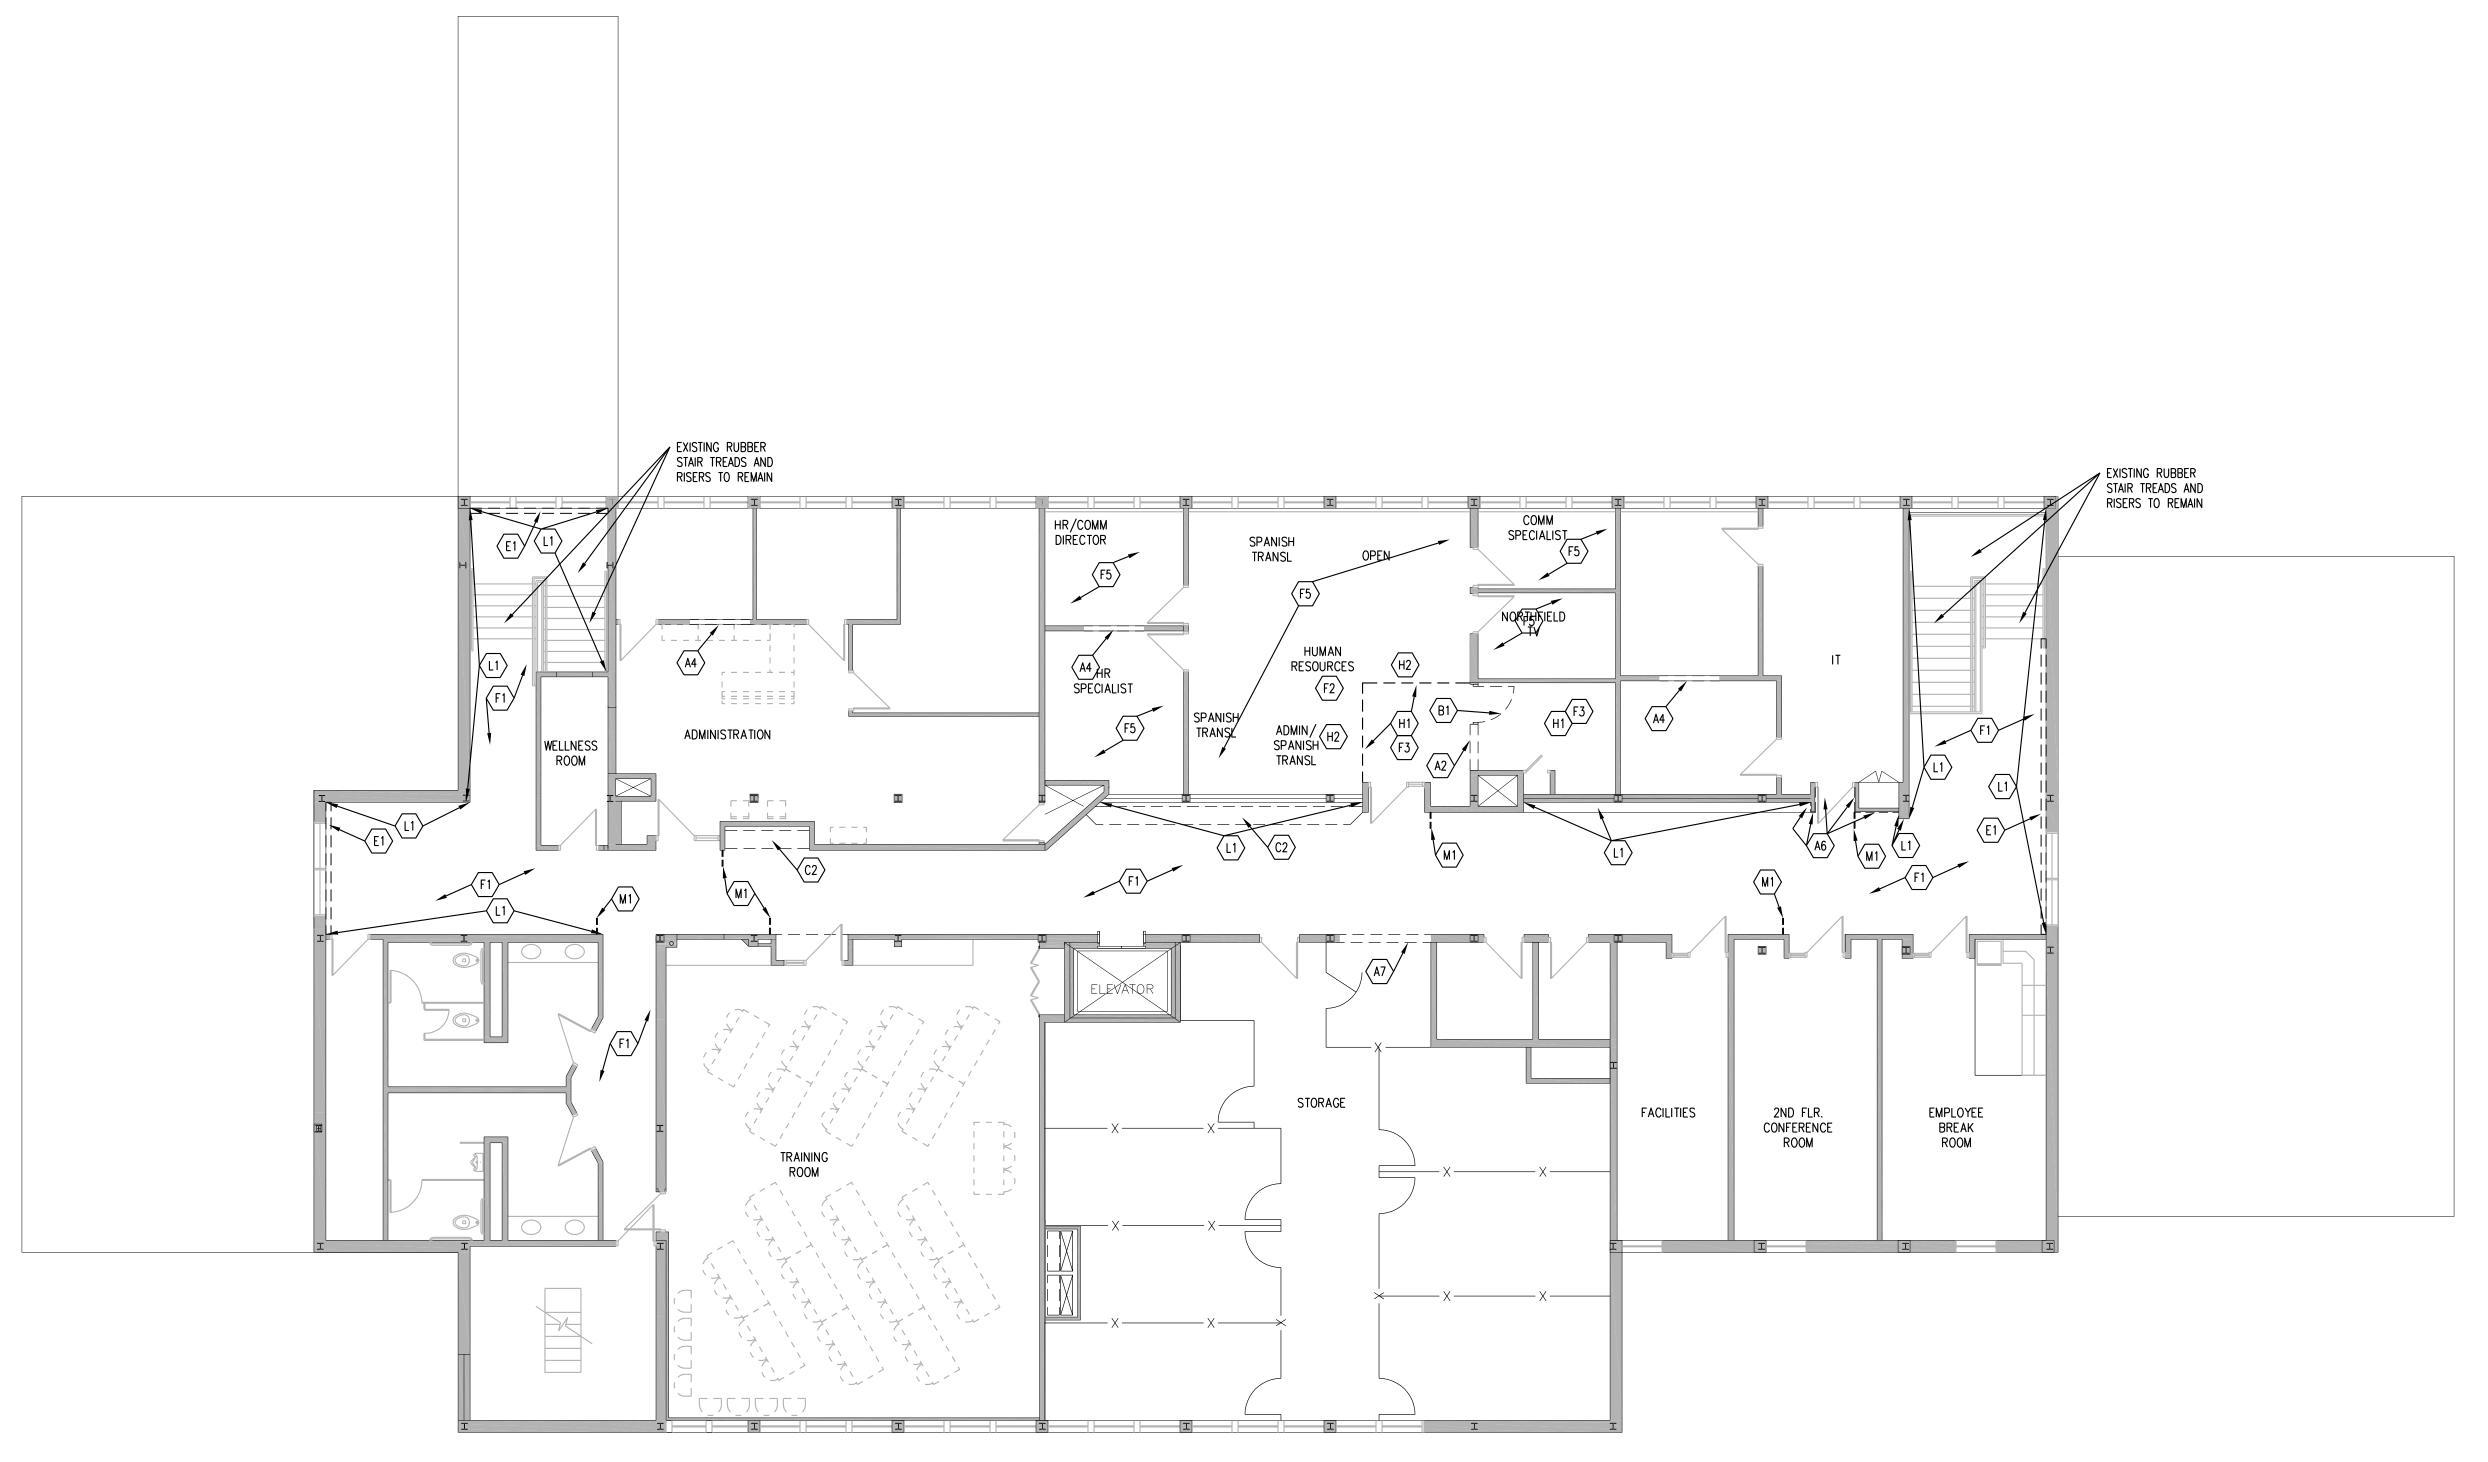

1 SECOND FLOOR A2.2 DEMOLITION PLAN 1/8" = 1'-0"

GENERAL DEMOLITON NOTES

- 1. ALL OPENINGS CUT INTO EXISTING MASONRY WALLS SHALL BE LARGE ENOUGH TO RECEIVE LINTEL ABOVE AND MASONRY AT JAMBS AND SILL TO MATCH
- EXISTING ADJACENT MATERIALS. REFER TO FLOOR PLANS FOR FINISHED OPENING DIMENSIONS.

 2. INFORMATION FROM EXISTING DRAWINGS HAS BEEN USED IN THE PREPARATION OF THESE DOCUMENTS. CONTRACTORS SHALL VERIFY ALL INFORMATION RELATING TO THE WORK, INCLUDING BUT NOT LIMITED TO THE LOCATION OF EXISTING BUILDING UTILITIES.
- 3. REFER TO OTHER ARCHITECTURAL DRAWINGS AND TO STRUCTURAL, MECHANICAL AND ELECTRICAL DRAWINGS FOR ADDITIONAL DEMOLITION AND ALTERATION
- 4. REMOVE & SALVAGE ALL DESIRED EQUIPMENT AND FIXTURES PRIOR TO COMMENCEMENT OF DEMOLITION. PROVIDE TEMPORARY LIGHTING AND POWER BY FLECTRICAL CONTRACTOR.
- ELECTRICAL CONTRACTOR.

 5. NOTIFY THE OWNER OF THE PRESENCE OF HAZARDOUS MATERIAL(S) IN WORK AREAS.
- 5. NOTIFY THE OWNER OF THE PRESENCE OF HAZARDOUS MATERIAL(S) IN WORK AREAS.

 6. EACH CONTRACTOR DISCIPLINE SHALL SAWCUT & REMOVE PORTIONS OF EXISTING FLOORS, WALLS, CEILINGS & ROOF AS REQUIRED TO ACCOMMODATE
- 7. WHEN EXISTING WALLS, CASEWORK, AND OTHER ELEMENTS ARE REMOVED, PATCH ALL EXG-TO-REMAIN ADJACENT SURFACES TO MATCH EXISTING, TO ACHIEVE CLEAN, MATCHING ADJACENT SURFACE TEXTURES. THIS INCLUDES GRINDING AND PATCHING OF FLOORS AND WALLS THAT MAY BE REQUIRED AT REMOVED MASONRY WALLS.

THEIR WORK (COORDINATE WORK W/OTHER RELATED CONTRACTOR DISCIPLINES). GENERAL CONTRACTOR SHALL PATCH ADJACENT SURFACES TO MATCH.

- 8. COORDINATE DEMOLITION OF WALLS WHICH INCLUDE EXISTING ELECTRICAL PANELS WITH ELECTRICAL CONTRACTOR.
- 9. CONTRACTOR SHALL COORDINATE DEMOLITION WORK WITH NOT-IN-CONTRACT SYSTEMS FURNITURE SUPPLIER, WHO WILL BE DEMOLISHING EXISTING SYSTEMS FURNITURE IN WORK AREAS.
- 10. SEE ROOM FINISH SCHEDULES ON FLOOR PLAN SHEETS FOR EXISTING WALL, FLOOR, & CEILING MATERIALS
- AT WALLS TO BE TILED, REMOVE ALL EXISTING EQUIPMENT & DEVICES (DOOR STOPS, HOLD OPENS, SIGNAGE, ETC), AS REQUIRED FOR TILING WORK. REINSTALL AT SAME LOCATION UNLESS CALLED TO BE DEMOLISHED. REPLACE ANY ITEMS DAMAGED BY REMOVAL WITH EQUAL. ELECT SHALL REMOVE & REINSTALL ALL EXIST—TO—REMAIN ELECT DEVICES & PROVIDE EXTENSION RINGS AS REQUIRED.

DEMOLITION PLAN NOTES

- A1) REMOVE PORTION OF EXG MAS WALL AS REQ FOR NEW DOOR FRAME, LINTEL AND JAMBS SEE FLOOR PLAN AND DETAILS.
- A2 REMOVE EXG GBD AND STL STUD PARTITION FROM FLOOR TO UNDERSIDE OF DECK. PATCH ALL ADJACENT SURFACES TO MATCH EXG.
- REMOVE PORTION OF EXG GBD AND STL STUD PARTITION AS REQ FOR NEW WINDOW, AND REQUIRED STUD FRAMING AROUND NEW OPENING, INCLUDING LOW WALL SUPPORT BELOW WINDOW SEE FLOOR PLAN AND WINDOW DETAILS. PATCH GBD, STUDS, AND BATT INS TO MATCH EXISTING.
- REMOVE PORTION OF EXG GBD AND STL STUD PARTITION AS REQ FOR NEW WINDOW AND REQUIRED STUD FRAMING AROUND NEW OPENING. REFER TO
- WITH REMOVAL OF CERAMIC TILE, VERIFY CONDITION OF REMAINING GBD. IF PAPER FACE HAS COME OFF, REMOVE GBD OUT TO NEXT STUD. PATCH WITH GBD WHERE IT WILL BE EXPOSED (NO NEW PCT), WHERE IT WILL BE COVERED WITH NEW PCT (SEE ELEVATIONS), PATCH WITH 5/8" TILE BACKER BOARD. REMOVE AND REINSTALL EXG CEILING AS REQUIRED FOR THIS, MINIMIZE CEILING REMOVAL AS MUCH AS POSSIBLE. IF REMOVAL OF EXG CERAMIC TILE CAUSES ONLY VERY MINOR DAMAGE TO PAPER FACE, AND CONTRACTOR FEELS THAT NEW TILE CAN BE INSTALLED SUCCESSFULLY OVER IT, ARCHITECT WILL REVIEW CONDITION IF ARCHITECT AGREES, EXISITNG GBD CAN REMAIN.
- $\langle A6 \rangle$ REMOVE EXG $\pm 3/4$ " WD PANELING FULL HEIGHT (AND MAIL SLOT) AND PREP FOR NEW GBD INSTALLATION
- SAWCUT AND REMOVE EXG LOAD BEARING CMU AND PLASTER WALL AS REQUIRED FOR LINTEL AND JAMBS. SAWCUT AND GRIND AT FLOOR AS REQ AND INFILL FLOOR AT WALL WITH CONC AND PREP FOR FLOORING
- (B1) REMOVE EXG DOOR & HM FRAME.
- B2 REMOVE EXG WD DOOR & HM FRAME AND SALVAGE DOOR, FRAME AND HARDWARE FOR REINSTALLATION IN SAME ROOM. SEE FLOOR PLAN.
- C1 REMOVE EXG VINEER PLYWOOD AND WOOD TRIM REFER TO DEMOLITION DETAILS

WINDOW DETAILS. PATCH GBD, STUDS, AND BATT INS TO MATCH EXISTING.

- AT BENCHING, REMOVE EXG CARPETING COVERING AND PORTION OF PLYWD/WD FRAMING UNDERNEATH TO REVISE BENCHING REFER TO FLOOR PLAN AND DETAIL
- E1) EXISTING FIN TUBE RADIATION COVER REMOVED AND REINSTALLED BY MC FOR NEW TILE WORK REFER TO MECHANICAL DRAWINGS.
- F1 REMOVE VCT FLOORING & BASE PREP FOR NEW FLOOR FINISH

F3 REMOVE EXT CPT AND RUBBER BASE AND PREP FOR NEW FLOOR FINISH

- F2 REMOVE AND REINSTALL EXG MODULAR CPT AS REQUIRED FOR NEW WALL. CUT/REMOVE/REINSTALL PORTION OF EXG RUBBER BASE AS REQ.
- F4 REMOVE EXT MODULAR CPT AND RUBBER BASE. SALVAGE CARPET FOR REINSTALLATION IN ADJACENT SPACE. PREP FLOOR FOR NEW FLOOR FINISH
- $\langle F5 \rangle$ BY ALTERNATE, REMOVE EXT BROADLOOM CPT AND RUBBER BASE AND PREP FOR NEW FLOOR FINISH
- F6 REMOVE EXG CT BASE (EXG CT FLOOR TO REMAIN).

 (H1) REMOVE EXG ACT CLG & GRID IN ITS ENTIRETY. SALVAGE CEILING TILES FOR PATCHING AT OTHER LOCATIONS.
- H2 REMOVE AND REINSTALL EXG ACT CEILING AS REQ FOR WORK
- (H3) REMOVE PORTION OF EXG GBD CEILING AND PREP FOR PATCHING INTO NEW WALL LOCATION.
- H4 REMOVE EXG ACT CLG & GRID AS REQIURED FOR NEW GBD SOFFIT. SALVAGE CEILING TILES FOR PATCHING.
- $\langle L1 \rangle$ PREP EXG CT WAINSCOT (±6'-1") TO RECEIVE NEW PCT OVER EXG REFER TO ELEVATIONS.
- L2 REMOVE EXG FULL HT CT
- $\overline{\langle L3 \rangle}$ REMOVE EXG CT ON EAST SIDE AND TOP OF LOW WALL/CURB (±6" H. AT MAIN CORRIDOR SIDE). EXG RAILING TO REMAIN.
- (M1) REMOVE EXG PROJECTING 'BLADE' SIGNAGE, PATCH WALL, PREP FOR NEW SIGNAGE AS SHOWN ON ELEVATIONS.
- S1 SYSTEMS FURNITURE CONTRACTOR (OWNER'S SEPARATE CONTRACT) WILL REMOVE EXISTING SYSTEMS FURNITURE. ELECTRICAL CONTRACTOR SHALL DISCONNECT EXISTING POWER AND DATA AS REQUIRED.

ATSR

ARCHITECTURE ENGINEERING
PLANNING TECHNOLOGY
INTERIOR DESIGN LANDSCAPE ARCHITECTURE

8501 GOLDEN VALLEY ROAD SUITE 300 MINNEAPOLIS, MINNESOTA 55427

TEL: 763.545.3731 FAX: 763.525.3289

WEB: www.atsr.com

C Armstrong, Torseth, Skold & Rydeen, Inc 2021
CONSULTANTS

REVISIONS

NORTHFIELD CITY HALL
SAFETY / SECURITY
ALTERATIONS
CITY OF NORTHFIELD
801 WASHINGTON STREET
NORTHFIELD, MN 55057

signature/seal FOR

ONLY Not for

REFERENCE

KEYPLAN

DRAWN BY A B C

DEF

CHECKED BY

ISSUED FOR
95% REVIEW SET

ISSUE DATE
MAY 26, 2021
SHEET NAME


SECOND FLOOR DEMOLITION PLAN

ATS&R PROJECT NO. 2 0 0 3 1 . 1

REVISION NO.

SHEET NUMBER

A2.2

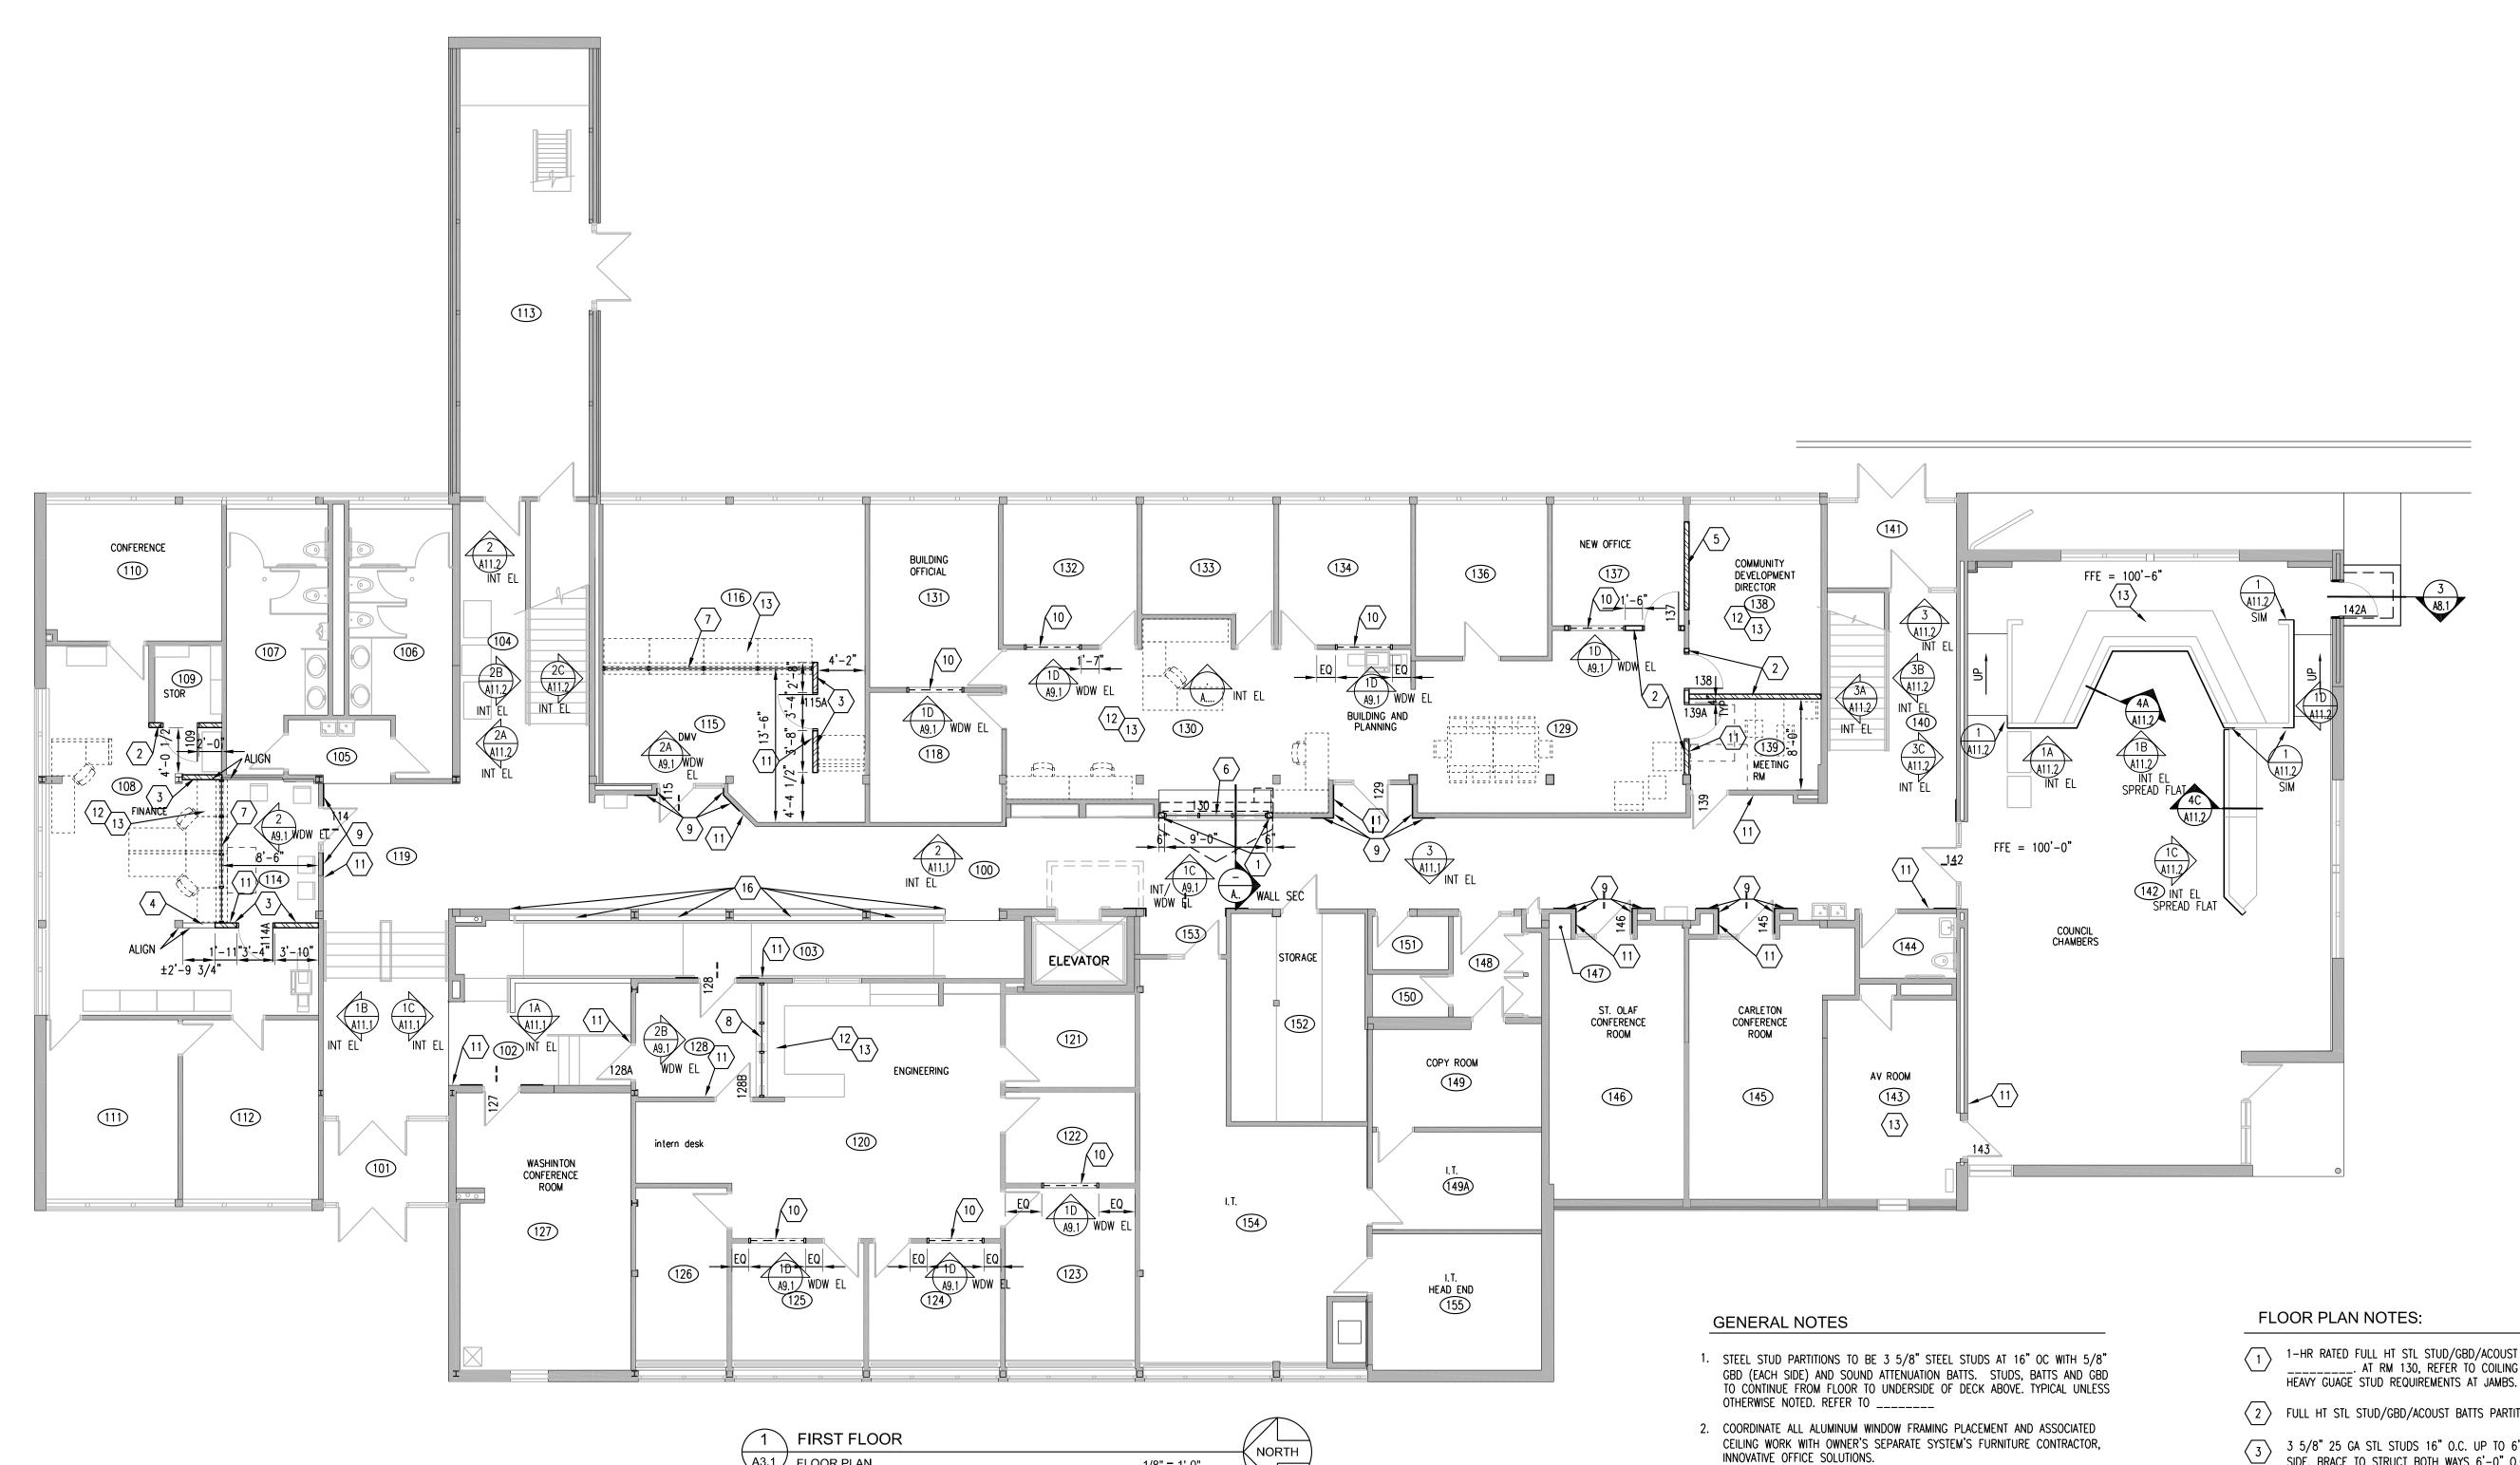

										FIR:	ST FLOOF	ROOM	FINIS	H SC	HEDULE													
NO.	ROOM NAME	FLOOR	BASE	WALL		EILING		NOTE	NO.	ROOM NAME	FLOOR	BASE		/ALL		ILING		NOTE	NO.	ROOM NAME	FLOOR	BASE		ALL	CEIL			NOTE
110.	1100101 1011012	MTL	MTL	MTL FIN		IN HT	DTL	11012	110.	TOOM TWINE	MTL	MTL	MT	L FIN	MTL FI	1 HT	DTL	11012	110.	TOOM TO MILE	MTL	MTL	MTL	FIN MT	L FIN	HT	DTL '	
	EXG	VCT	VB	GBD PT PCT	ACT						CPT	VB	GBD		ACT					EXG	СРТ	VB	GBD	PT ACT	ſ_ _			
100	CORRIDOR	LVT	VB	EXG GBD PT	EXG	_			118	OFFICE	EXG CPT	EXG VB	EXG GB		EXG			2	131	BUILDING OFFICIAL	EXG CPT	EXG VB	EXG GBD	EXC	G		2	
	CORRIDOR				GBD P1	Г		4		EXG	VCT	VB	GBD PCT	PT 	ACT					EXG	СРТ	VB	GBD	PT ACT	Г			
	EXG	VCT	VB	GBD PT PCT	ACI				119	CORRIDOR	LVT	VB	EXG GB PCT	D PT	EXG ACT			4	132	OFFICE	EXG CPT	EXG VB	EXG GBD	EXC			2	
102	CORRIDOR	LVT	VB	EXG GBD PT PCT	EXG			4		EXG	СРТ	VB	GBD	PT	ACT					EXG	СРТ	VB	GBD	PT ACT	r			
	EXG	CPT	VB	GBD PT	ACT -				120	ENGINEERING	EXG CPT	EXG VB	EXG GB	D	EXG ACT			2	134	OFFICE	EXG CPT	EXG VB	EXG GBD	EXC			2	
103	RAMP	СРТ	VB	EXG GBD PT	ACT	-				EXG	СРТ	VB	GBD	PT	ACT					EXG	СРТ	VB	GBD	PT ACT	r			
	EXG	VCT	VB	GBD PT PCT					122	OFFICE	EXG CPT	EXG VB	EXG GB	D	EXG			2	137	OFFICE	EXG CPT	EXG VB	EXG GBD	EXC	G		2	
104	CORRIDOR	LVT	VB	EXG GBD PT PCT		-		4		EXG	CPT	VB	GBD	PT	ACT					EXG	СРТ	VB	GBD	PT ACT	ſ			
	EXG	VCT	VB	GBD PT PCT	ACT				123	OFFICE	EXG CPT	EXG VB	EXG GB	D	EXG			2	138	OFFICE	EXG CPT	VB	EXG GBD GBD	PT ACT	Г		1	,2,5,6
105	ALCOVE	LVT	VB	EXG GBD PT PCT		-				EXG	СРТ	VB	GBD	PT	ACT					EXG	СРТ	VB	GBD	PT ACT	I			
	EXG	CPT	VB	GBD PT	ACT				124	OFFICE	EXG CPT	EXG VB	EXG GB	D	EXG			2	139	MEETING	EXG CPT	VB	EXG GBD GBD	PT ACT	г		1	,2,5,6
108	FINANCE	EXG CPT	VB	EXG GBD PT GBD PT	EXG			1,2,5,6		EXG	СРТ	VB	GBD	PT	ACT					EXG	VCT	VB	GBD PCT	PT ACT	r			
	EXG	VCT	VB	GBD PT	GBD				125	OFFICE	EXG CPT	EXG VB	EXG GB	D	EXG			2	140	CORRIDOR	LVT	VB	EXG GBD PCT	PT EXC	G		4	
109	STORAGE									EXG	СРТ	VB	GBD	PT	ACT					EXG	СРТ	VB	GBD FB	PT ACT	ſ			
		СРТ	VB						128	OFFICE	EXG CPT	EXG VB	EXG GB	D	EXG ACT			5,6	142	COUNCIL CHAMBERS	EXG CPT	EXG VB	EXG GBD EXG FB	EXC	G			
114	WAITING	EXG CPT	VB	EXG GBD PT GBD PT	EXG			1,2,5,6		EXG	СРТ	VB	GBD		ACT													
		CPT	VB	GBD PT	ACT				129	ADMIN	EXG CPT	VB	EXG GB GBD	D PT PT	EXG			1,2,3,5,6										
I					FYC																							

130 BUILDING & PLANNING EXG CPT EXG VB EXG GBD -- EXG -- -- -- 2,3,6

115 WAITING

116 DMV

ROOM FINISH SCHEDULE NOTES:

EXISTING ADJACENT MATERIALS & FINISH.

SEE PLAN FOR ACCENT WALL PAINT LOCATIONS 4. SEE INTERIOR ELEVATIONS FOR TILING / PAINTING

PAINT CORNER TO CORNER WHERE AFFECTED BY CONSTRUCTION.

6. REMOVE AND REINSTALL PORTION OF EXG ACT CLG AS REQUIRED FOR THE WORK

PAINT AND VB AT NEW CONSTRUCTION

VB GBD PT ACT -- -- --

EXG CPT VB GBD PT EXG -- - 1,5,6

SHADED LINES INDICATE EXISTING MATERIALS & FINISHES IN EXISTING ROOMS TO REMAIN. UNLESS NOTED TO BE

MATERIALS & FINISHES OF NEW CONSTRUCTION - SEE PLANS & RM FINISH SCHEDULE FOR EXTENT OF NEW FINISHES IN EXISTING ROOMS. PATCH FLOOR, BASE AND CEILING, WHERE DAMAGED BY CONSTRUCTION, TO MATCH

REMOVED ON DEMOLITION PLANS OR COVERED OVER AS NOTED IN SCHEDULE. UNSHADED LINES INDICATE

5. REMOVE AND REINSTALL EXG MODULAR CPT AND CUT PORTION OF EXG VB AS REQUIRED FOR WALL

A3.1 FLOOR PLAN

NO.	NOMINAL SIZE	DO	OR	FR/	ME	HEAD	HDW	DR & FR	NOTE	
NU.	NOMINAL SIZE	MTL	TYPE	MTL	TYPE	DETAIL	пиw	LABEL	NOI	
109	EXG 3'-0" x 7'-0" x 1 3/4"	EXG HM		EXG HM			-		7	
114	EXG 3'-0" x 7'-0" x 1 3/4"	EXG WD		EXG HM			_		3,5	
114A	3'-0" x 7'-0" x 1 3/4"	WD	В	нм	1A/A9.1	3B/A9.1			3,4,	
115	EXG 3'-0" x 7'-0" x 1 3/4"	EXG WD		EXG HM			-		3,5	
115A	3'-0" x 7'-0" x 1 3/4"	WD	В	НМ	1A/A9.1	3B/A9.1			3,4,	
127	EXG 3'-0" x 7'-0" x 1 3/4"	EXG WD		EXG HM			-		3,5	
128	EXG 3'-0" x 7'-0" x 1 3/4"	EXG WD		EXG HM			-		3,5	
128A	EXG 3'-0" x 7'-0" x 1 3/4"	EXG WD		EXG HM			-		3,5	
128B	EXG 3'-0" x 7'-0" x 1 3/4"	EXG WD		EXG HM			-		3,5	
129	EXG 3'-0" x 7'-0" x 1 3/4"	EXG WD		EXG HM			-		3,5	
138	3'-0" x 7'-0" x 1 3/4"	WD	D	НМ	1A/A9.1	3B/A9.1			3,4,	
139	EXG 3'-0" x 7'-0" x 1 3/4"	EXG WD		EXG HM			-		3,5	
139A	3'-0" x 7'-0" x 1 3/4"	WD	В	НМ	1A/A9.1	3B/A9.1			3,4,	
142	EXG 3'-0" x 7'-0" x 1 3/4"	EXG WD		EXG HM			-		3,5	
142A	3'-0" x 6'-8" x 1 3/4"	нм	D	НМ	1B/A9.1	4/A9.1			1,4,	
143	EXG 3'-0" x 7'-0" x 1 3/4"	EXG WD		EXG HM			-		3,5	
145	EXG 3'-0" x 7'-0" x 1 3/4"	EXG WD		EXG HM			-		3,5	
146	EXG 3'-0" x 7'-0" x 1 3/4"	EXG WD		EXG HM			_		3,5	

3. REFER TO SHEET A9.1 FOR DOOR TYPES.

4. WHERE TILING IS BEING DONE OVER EXISTING CERAMIC TILE, ELECT TO

PROVIDE EXTENSION RINGS AT ALL ELECT DEVICES.

DOOR SCHEDULE NOTES:

1. FACTORY PT FINISH SMOKE SEALS

- EXTERIOR DOOR PANIC HARDWARE, EXIT ONLY, NO OUTSIDE TRIM. PROVIDE ROUGH-IN FOR DOOR ALARM. REFER TO ELEC DWGS AND DETAIL_____
- PROVIDE ELECTRONIC CARD READER. REFER TO ELEC DWGS. PROVIDE CLOSER.
- 5. PROVIDE ELECTRIC STRIKE ON EXISTING DOOR/FRAME. RUN RACEWAY DOWN WALL WITHIN DEPT TO TOP OF FRAME THEN RUN WITHIN FRAME.
- 6. PROVIDE ELECTRIC STRIKE.
- 7. EXISTING RELOCATED HM DOOR AND FRAME W/ CONTINUOUS HINGE AND LEVER SET. 8. INSULATED HM DOOR

	,	SPECIA	ALTY DC	OR :	SCH	EDU	ILE					
TYPE	DOOR SIZE	OPERATION	DOOR	FIRE		FINISH	FINISH		DETAILS		NOTES	
IIFE	(W x HT)	UPERATION	CONTROL	RATING	SLAT	HOOD	JAMB	HEAD	JAMB SILL		NOTES	
CHINTED COILLE	0'_0" × 5'_6"	EL ECTRIC	νεν	20 MIN	CTI	CTI	CTI	4A /AQ 1	4P/A0 1	4C /AQ 1	1.2	

DOOR DOOR T 130 | COILING COUNTER GRILLE | 9'-0" x 5'-6" | ELECTRIC | KEY | 20 MIN | STL | STL | 4A/A9.1 | 4B/A9.1 | 4C/A9.1 | 1,2 SPECIALTY DOOR NOTES:

- 1-HR RATED FULL HT STL STUD/GBD/ACOUST BATTS PARTITION REFER TO __. AT RM 130, REFER TO COILING DOOR JAMB DETAIL FOR SPECIAL
- 2 FULL HT STL STUD/GBD/ACOUST BATTS PARTITION REFER TO ______.
- 3 5/8" 25 GA STL STUDS 16" O.C. UP TO 6" ABOVE CEILING, WITH 5/8" GBD EACH SIDE, BRACE TO STRUCT BOTH WAYS 6'-0" O.C MAX. REMOVE AND REINSTALL EXG MODULAR CARPET TILES AROUND WALL (CUT OUT BROADLOOM AT WALL AT RM 226, BASE BID - SEE RM FIN SCHED).
- 3'-0' H. PARTIAL HEIGHT STL STUD/GBD PARTITION REFER TO DTL ____ FOR SOLID SURFACE CAP.
- 5 STL STUD/GBD/ACOUST BATTS PARTITION TO INFILL FORMER CASED OPENING BETWEEN ROOMS FOR CLEAN WALL PLANE REFER TO ______, SIM.
- 6 LOW WALL STEEL CHANNEL COLUMN SUPPORT AT CENTER OF 9'-0" OPENING REFER TO DTL _____
- ALUM STOREFRONT WDW FRAMING ON N.I.C. SYSTEMS FURNITURE COORDINATE SIZE
- ALUM STOREFRONT WDW FRAMING ON N.I.C. SYSTEMS FURNITURE COORDINATE SIZE AND INSTALLATION WITH SYSTEMS FURNITURE SUPPLIER. REFER TO REFL CLG PLAN FOR DETAIL AT CEILING.
- 8 ALUM STOREFRONI WDW FRAMING ON EAG GOODING. ALUM STOREFRONT WDW FRAMING ON EXG CASEWORK - FIELD VERIFY SIZE TO FIT WHERE EXG TILE AND GBD WAS REMOVED, PATCH EXG 1-HR RATED WALL WITH TYPE 29 'X' 5/8" GBD (USE 5/8" TYPE 'X' TILE BACKER BOARD AS POSSIBLE WITHIN TILE
- FIELD AND STUD SPACING). REFER TO INTERIOR ELEVATIONS FOR TILE LOCATIONS. REMOVE/REINSTALL ACT CLG AS REQ FOR CLEAN INSTALLATION (MINIMIZE CEILING IMPACT IF POSSIBLE).
- HIGH WINDOW IN EXT STL STUD/GBD PARTITION FRAME AND PATCH GBD AS REQ SEE WDW ELEVATION AND DETAILS PEEED TO ELECT FOR FLECT (TEXT) SEE WDW ELEVATION AND DETAILS. REFER TO ELECT FOR ELECT/TECH OUTLET
- CARD READER MOUNT TOP AT 36" A.F.F. SEE ELECT. PULL WIRING THRU STUD WALL, TYP. DO NOT PLACE ON TILE FLANKING DEPARTMENT DOORS ON

UNLOCKS DOOR BETWEEN DEPARTMENT'S PUBLIC SIDE AND STAFF SIDE.

MAIN CORRIDOR FACE (PLACE NEXT TO IT) UNLESS THERE IS NO OTHER OPTION. MOMENTARY DOOR UNLOCK BUTTON ON SYSTEMS FURNITURE (ON CSWK AT RM 120) (COORDINATE EXACT LOCATION WITH OWNER) – SEE ELECT. MOMENTARILY

RELOCATIONS AS REQ WHERE THEY OCCUR.

LOCK DOWN BUTTON ON SYSTEMS FURNITURE (UNDER COUNTER - COORD EXACT LOC WITH OWNER) (ON CSWK AT RM 120 AND 142), BUTTON SHALL LOCK ALL ELECTRIFIED STRIKES AND PUT ALL CARD READERS IN BUILDING ON HIGH SECURITY MODE - SEE ELECT/TECH.

SYSTEM MASTER STATION ON CASEWORK/SYSTEMS FURNITURE

- VIDEO DOOR INTERCOM SYSTEM SURFACE MOUNTED ON EXISTING WALL RUN CONDUIT THRU EXG STUD WALL — SEE ELECT. CONNECTED TO INTERCOM
- INTERCOM SYSTEM MASTER STATION ON SYSTEMS FURNITURE SEE ELECT. ELECT TO CONNECT SYSTEM TO DOOR 221, WITH PUSH BUTTON TO MOMENTARILY UNLOCK DOOR 221.
- APPLY PCT____ TO EXG MASONRY CURB, AROUND EXG MTL RAILING POSTS, EAST AND SOUTH SIDES AND TOP. PROVIDE METAL EDGE TRIM AND SEALANT AT ALL OPEN
- (17) ACCENT PAINT THIS WALL PLANE
- MECH TO REMOVE AND REINSTALL EXG FIN TUBE COVER TO ALLOW NEW TILE (OVER EXG TILE) TO FIT BEHIND COVER- REFER TO MECH.
- 5/8" TYPE 'X' GBD FULL HT ON EXG FRAMING PROVIDE 1/2" SEALANT JT AT TOP (PAINTABLE SEALANT OVER FIRE SEALANT)

FIRST FLOOR PLAN AND SCHEDULES

20031.1

ARCHITECTURE ENGINEERING PLANNING TECHNOLOGY

8501 GOLDEN VALLEY ROAD

TEL: 763.545.3731 FAX: 763.525.3289 WEB: www.atsr.com

SUITE 300

CONSULTANTS

REVISIONS

NOR

SIGNATURE / SEAL

KEYPLAN

DRAWN BY

CHECKED BY

ISSUED FOR

ISSUE DATE

MAY 26, 2021

SHEET NAME

95% REVIEW SET

ABC

DEF

FOR

REFERENCE

ONLY

NOT FOR

CONSTRUCTION


INTERIOR DESIGN LANDSCAPE ARCHITECTURE

MINNEAPOLIS, MINNESOTA 55427

Armstrong, Torseth, Skold & Rydeen, Inc 2021

REVISION NO.

ATS&R PROJECT NO.

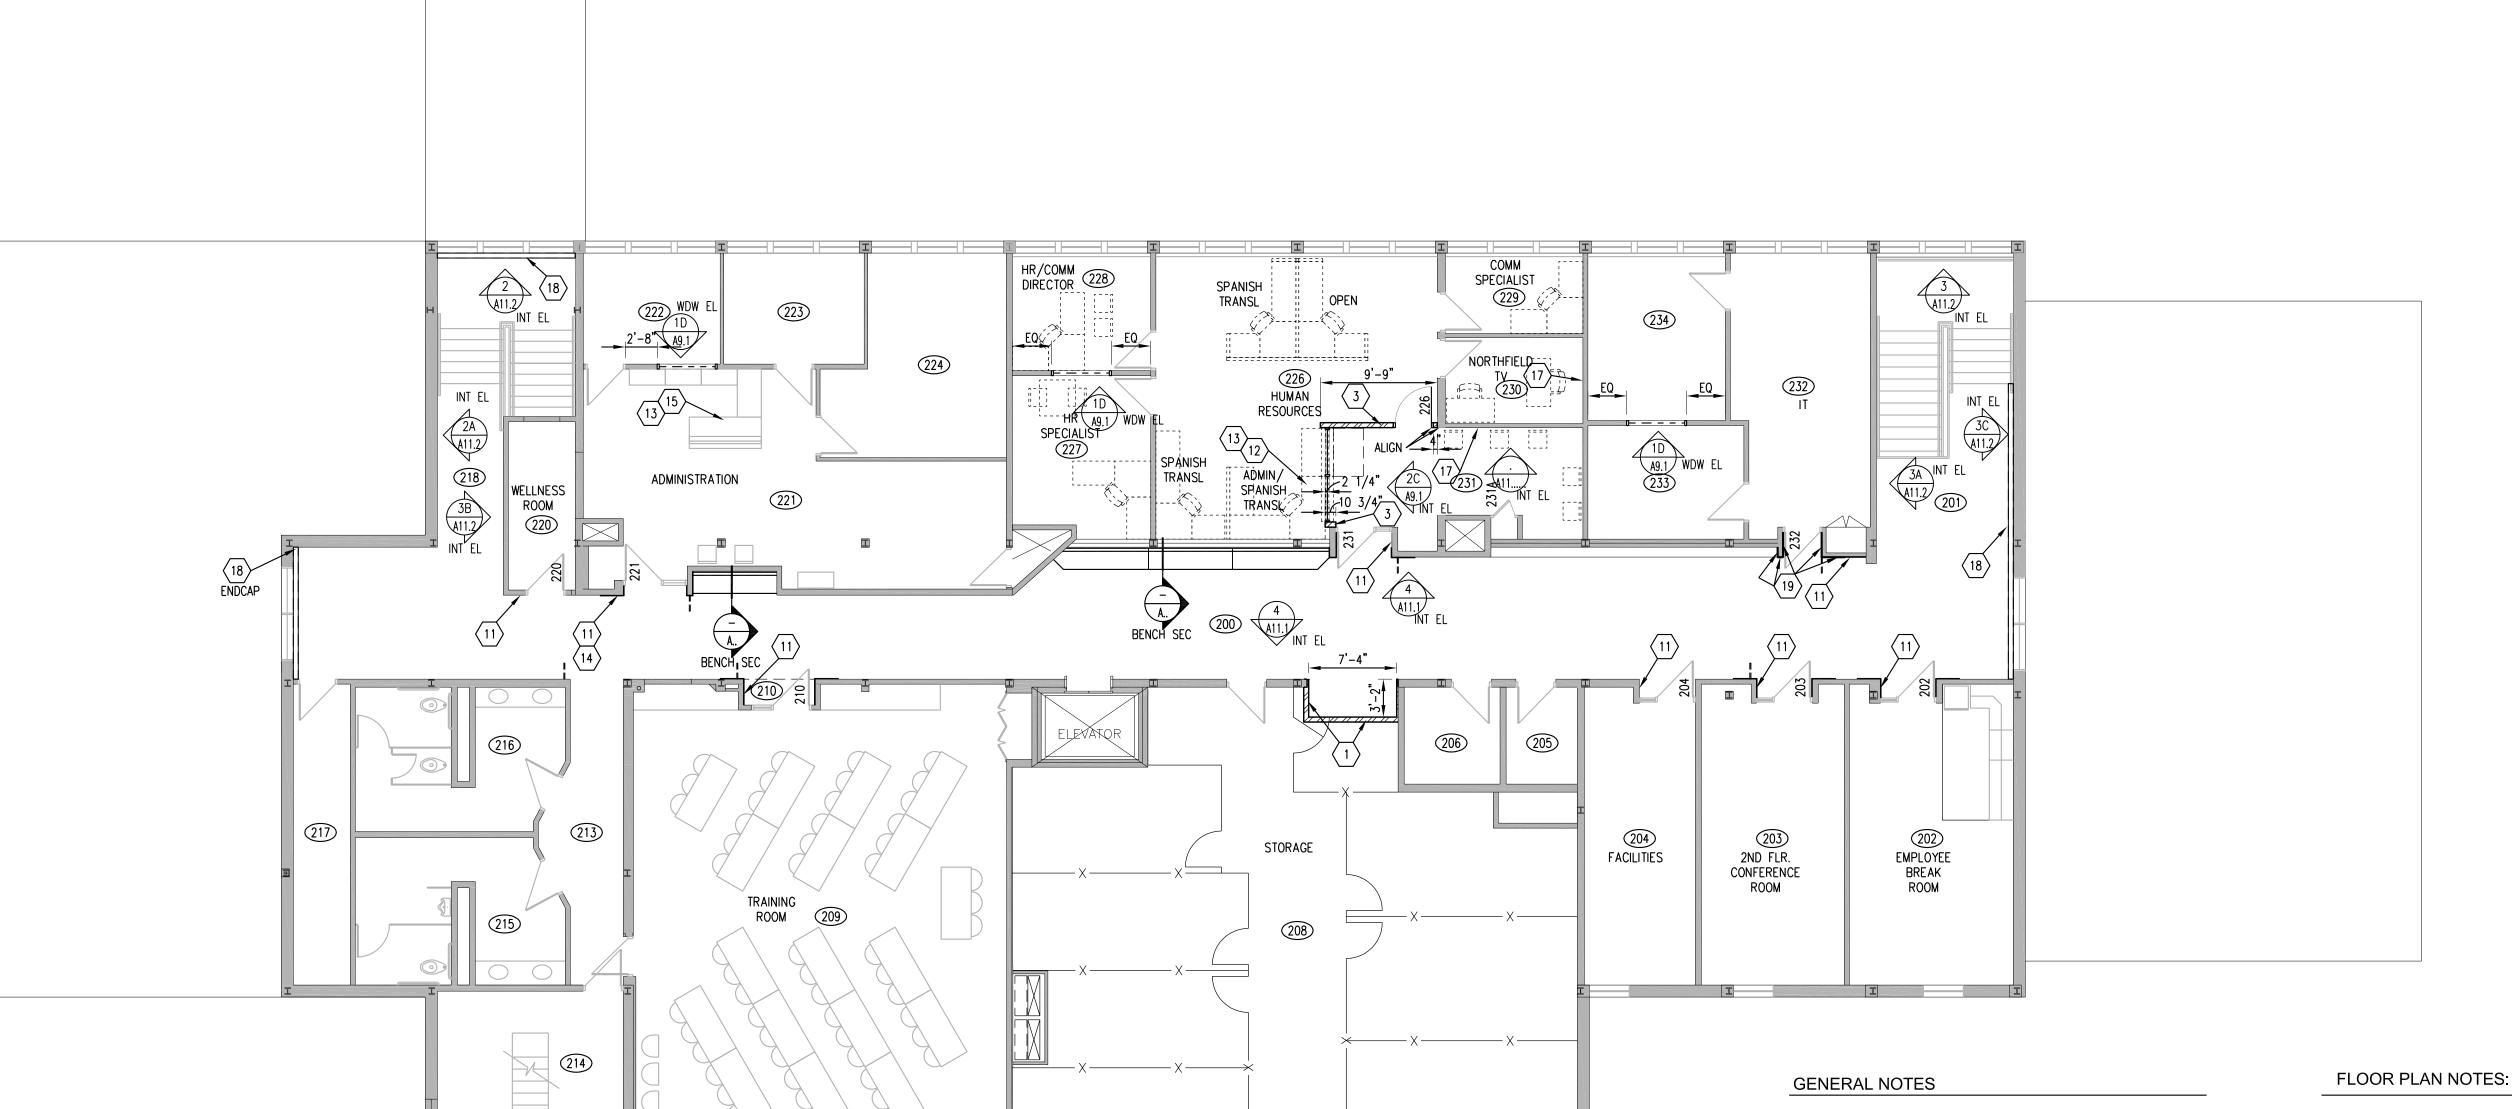

1/8" = 1'-0"

							5	SECON	ND FL	.00R R	OOM FIN
NO.	ROOM NAME	FLOOR	BASE	WA	LL		CEIL	ING		NOTE	NO.
NO.	NOOW NAWL	MTL	MTL	MTL	FIN	MTL	FIN	HT	DTL	INOTE	110.
	EXG	VCT	VB	GBD PCT	PT 	ACT	- _				
200	CORRIDOR	LVT	VB	GBD PCT	PT 	EXG ACT				4	230
	EXG	VCT	VB	GBD PCT	PT 	ACT					
201	CORRIDOR	LVT	VB	GBD PCT	PT 	EXG ACT				4	231
	EXG	VCT	VB	GBD	PT	ACT					
213	CORRIDOR	LVT	VB	EXG GBD	PT	EXG ACT					233
	EXG	VCT	VB	GBD PCT	PT 	ACT					
218	CORRIDOR	LVT	VB	GBD PCT	PT 	EXG ACT				4	234
	EXG	CPT	VB	GBD	PT	ACT					
221	OFFICE	EXG CPT	VB	EXG GBD		EXG ACT				2	
	EXG	CPT	VB	GBD	PT	ACT					ROOM
222	OFFICE	EXG CPT	VB	EXG GBD	-	EXG ACT				2	
	EXG	VCT	VB	GBD	PT	GBD					
226	HUMAN RESOURCES	EXG CPT	VB	EXG GBD GBD	 PT	EXG ACT				1,5,6	
	EXG	CPT	VB	GBD	PT	ACT					1.
227	OFFICE	EXG CPT	VB	EXG GBD		EXG ACT				2	2. 3.
	EXG	CPT	VB	GBD	PT	ACT					4. 5.
228	OFFICE	EXG CPT	VB	EXG GBD		EXG ACT				2	6.
		CPT	VB	GBD	PT	ACT					
229	OFFICE	EXG CPT	VB	EXG GBD		EXG ACT					

)(OM FIN	ISH SCHEDULE										
	NO	ROOM NAME	FLOOR	BASE	WA	\LL		CEIL	ING		NOTE	
	NO.	ROOM NAME	MTL	MTL	MTL	FIN	MTL	FIN	HT	DTL	NOTE	
			CPT	VB	GBD	PT	ACT					
	230	TV	EXG CPT	VB	EXG GBD	1	EXG ACT				3	
			VCT	VB	GBD	PT	ACT		-			
	231	MEETING	EXG CPT	VB	EXG GBD GBD	 PT	ACT				1,2,3,5,6	
		EXG	CPT	VB	GBD	PT	ACT					
	233	OFFICE	EXG CPT	VB	EXG GBD		EXG ACT				2	
		EXG	CPT	VB	GBD	PT	ACT					
	234	OFFICE	EXG CPT	VB	EXG GBD		EXG ACT				2	

ROOM FINISH SCHEDULE NOTES:

1 SECOND FLOOR

A3.2 FLOOR PLAN

SHADED LINES INDICATE EXISTING MATERIALS & FINISHES IN EXISTING ROOMS TO REMAIN. UNLESS NOTED TO BE REMOVED ON DEMOLITION PLANS OR COVERED OVER AS NOTED IN SCHEDULE. UNSHADED LINES INDICATE MATERIALS & FINISHES OF NEW CONSTRUCTION — SEE PLANS & RM FINISH SCHEDULE FOR EXTENT OF NEW FINISHES IN EXISTING ROOMS. PATCH FLOOR, BASE AND CEILING, WHERE DAMAGED BY CONSTRUCTION, TO MATCH EXISTING ADJACENT MATERIALS & FINISH.

- PAINT AND VB AT NEW CONSTRUCTION
 PAINT CORNER TO CORNER WHERE AFFECTED BY CONSTRUCTION.
- 3. SEE PLAN FOR ACCENT WALL PAINT LOCATIONS
 4. SEE INTERIOR FLEVATIONS FOR TILING / PAINTING
- . SEE INTERIOR ELEVATIONS FOR TILING / PAINTING . REMOVE AND REINSTALL EXG MODULAR CPT AND CUT PORTION OF EXG VB AS REQUIRED FOR WALL
- INSTALLATION
 REMOVE AND REINSTALL PORTION OF EXG ACT CLG AS REQUIRED FOR THE WORK

- 1-HR RATED FULL HT STL STUD/GBD/ACOUST BATTS PARTITION REFER TO ______. AT RM 130, REFER TO COILING DOOR JAMB DETAIL FOR SPECIAL HEAVY GUAGE STUD REQUIREMENTS AT JAMBS.
- 2 FULL HT STL STUD/GBD/ACOUST BATTS PARTITION REFER TO ______.

1. STEEL STUD PARTITIONS TO BE 3 5/8" STEEL STUDS AT 16" OC WITH 5/8"

2. COORDINATE ALL ALUMINUM WINDOW FRAMING PLACEMENT AND ASSOCIATED

4. WHERE TILING IS BEING DONE OVER EXISTING CERAMIC TILE, ELECT TO

PROVIDE EXTENSION RINGS AT ALL ELECT DEVICES.

FIRST FLOOR DOOR SCHEDULE

CEILING WORK WITH OWNER'S SEPARATE SYSTEM'S FURNITURE CONTRACTOR,

 DOOR
 FRAME
 HEAD DETAIL
 HDW LABEL
 DR & FR NOTES

OTHERWISE NOTED. REFER TO _____

INNOVATIVE OFFICE SOLUTIONS.

202 | EXG 3'-0" x 7'-0" x 1 3/4" | EXG WD | -- | EXG HM |

203 | EXG 3'-0" x 7'-0" x 1 3/4" | EXG WD | -- | EXG HM |

 204
 EXG 3'-0" x 7'-0" x 1 3/4"
 EXG WD
 - EXG HM

 210
 EXG 3'-0" x 7'-0" x 1 3/4"
 EXG WD
 - EXG HM

231A

DOOR SCHEDULE NOTES:

PROVIDE CLOSER.

PROVIDE ELECTRIC STRIKE.

INSULATED HM DOOR

EXG 3'-0" x 7'-0" x 1 3/4" | EXG WD | -- | EXG HM |

EXG 3'-0" x 7'-0" x 1 3/4" | EXG WD | -- | EXG HM |

EXG 3'-0" x 7'-0" x 1 3/4" | EXG WD | -- | EXG HM |

3'-0" x 7'-0" x 1 3/4" | WD | B | HM | 1A/A9.1 | 3B/A9.1 |

????" x ????" x 1 3/4" | WD | D | HM | 1A/A9.1 | 3B/A9.1 |

EXTERIOR DOOR - PANIC HARDWARE, EXIT ONLY, NO OUTSIDE TRIM.

PROVIDE ELECTRONIC CARD READER. REFER TO ELEC DWGS.

TOP OF FRAME THEN RUN WITHIN FRAME.

PROVIDE ROUGH-IN FOR DOOR ALARM. REFER TO ELEC DWGS AND DETAIL_____

EXISTING RELOCATED HM DOOR AND FRAME W/ CONTINUOUS HINGE AND LEVER SET.

PROVIDE ELECTRIC STRIKE ON EXISTING DOOR/FRAME. RUN RACEWAY DOWN WALL WITHIN DEPT TO

3. REFER TO SHEET A9.1 FOR DOOR TYPES.

GBD (EACH SIDE) AND SOUND ATTENUATION BATTS. STUDS, BATTS AND GBD

TO CONTINUE FROM FLOOR TO UNDERSIDE OF DECK ABOVE. TYPICAL UNLESS

- 3 5/8" 25 GA STL STUDS 16" O.C. UP TO 6" ABOVE CEILING, WITH 5/8" GBD EACH SIDE, BRACE TO STRUCT BOTH WAYS 6'-0" O.C MAX. REMOVE AND REINSTALL EXG MODULAR CARPET TILES AROUND WALL (CUT OUT BROADLOOM AT WALL AT RM 226, BASE BID SEE RM FIN SCHED).
- 3'-0' H. PARTIAL HEIGHT STL STUD/GBD PARTITION REFER TO DTL ____ FOR SOLID SURFACE CAP.
- 5 STL STUD/GBD/ACOUST BATTS PARTITION TO INFILL FORMER CASED OPENING BETWEEN ROOMS FOR CLEAN WALL PLANE REFER TO ______, SIM.
- 6 LOW WALL STEEL CHANNEL COLUMN SUPPORT AT CENTER OF 9'-0" OPENING REFER TO DTL _____
- ALUM STOREFRONT WDW FRAMING ON N.I.C. SYSTEMS FURNITURE COORDINATE SIZE AND INSTALLATION WITH SYSTEMS FURNITURE SUPPLIER. REFER TO REFL CLG PLAN FOR DETAIL AT CEILING.
- 8 ALUM STOREFRONT WDW FRAMING ON EXG CASEWORK FIELD VERIFY SIZE TO FIT EXG. REFER TO REFL CLG PLAN FOR DETAIL AT CEILING.
- WHERE EXG TILE AND GBD WAS REMOVED, PATCH EXG 1-HR RATED WALL WITH TYPE 'X' 5/8" GBD (USE 5/8" TYPE 'X' TILE BACKER BOARD AS POSSIBLE WITHIN TILE FIELD AND STUD SPACING). REFER TO INTERIOR ELEVATIONS FOR TILE LOCATIONS. REMOVE/REINSTALL ACT CLG AS REQ FOR CLEAN INSTALLATION (MINIMIZE CEILING IMPACT IF POSSIBLE).
- HIGH WINDOW IN EXT STL STUD/GBD PARTITION FRAME AND PATCH GBD AS REQ SEE WDW ELEVATION AND DETAILS. REFER TO ELECT FOR ELECT/TECH OUTLET RELOCATIONS AS REQ WHERE THEY OCCUR.
- CARD READER MOUNT TOP AT 36" A.F.F. SEE ELECT. PULL WIRING THRU STUD WALL, TYP. DO NOT PLACE ON TILE FLANKING DEPARTMENT DOORS ON MAIN CORRIDOR FACE (PLACE NEXT TO IT) UNLESS THERE IS NO OTHER OPTION.
- MOMENTARY DOOR UNLOCK BUTTON ON SYSTEMS FURNITURE (ON CSWK AT RM 120) (COORDINATE EXACT LOCATION WITH OWNER) SEE ELECT. MOMENTARILY UNLOCKS DOOR BETWEEN DEPARTMENT'S PUBLIC SIDE AND STAFF SIDE.
- LOCK DOWN BUTTON ON SYSTEMS FURNITURE (UNDER COUNTER COORD EXACT LOC WITH OWNER) (ON CSWK AT RM 120 AND 142), BUTTON SHALL LOCK ALL ELECTRIFIED STRIKES AND PUT ALL CARD READERS IN BUILDING ON HIGH SECURITY MODE SEE ELECT/TECH.
- VIDEO DOOR INTERCOM SYSTEM SURFACE MOUNTED ON EXISTING WALL RUN CONDUIT THRU EXG STUD WALL SEE ELECT. CONNECTED TO INTERCOM SYSTEM MASTER STATION ON CASEWORK/SYSTEMS FURNITURE
- INTERCOM SYSTEM MASTER STATION ON SYSTEMS FURNITURE SEE ELECT.
 ELECT TO CONNECT SYSTEM TO DOOR 221, WITH PUSH BUTTON TO MOMENTARILY
 UNLOCK DOOR 221
- APPLY PCT____ TO EXG MASONRY CURB, AROUND EXG MTL RAILING POSTS, EAST AND SOUTH SIDES AND TOP. PROVIDE METAL EDGE TRIM AND SEALANT AT ALL OPEN
- 17 ACCENT PAINT THIS WALL PLANE
- MECH TO REMOVE AND REINSTALL EXG FIN TUBE COVER TO ALLOW NEW TILE (OVER EXG TILE) TO FIT BEHIND COVER- REFER TO MECH.
- 5/8" TYPE 'X' GBD FULL HT ON EXG FRAMING PROVIDE 1/2" SEALANT JT AT TOP (PAINTABLE SEALANT OVER FIRE SEALANT)

ATSR

ARCHITECTURE ENGINEERING
PLANNING TECHNOLOGY
INTERIOR DESIGN LANDSCAPE ARCHITECTURE

8501 GOLDEN VALLEY ROAD SUITE 300 MINNEAPOLIS, MINNESOTA 55427

FAX: 763.525.3289
WEB: www.atsr.com

© Armstrong, Torseth, Skold & Rydeen, Inc 2021

CONSULTANTS

TEL: 763.545.3731

REVISIONS

NORTHFIELD CITY HAL
SAFETY / SECURITY
ALTERATIONS
CITY OF NORTHFIELD
801 WASHINGTON STREET

FOR REFERENCE ONLY

SIGNATURE / SEAL

NOT FOR

KEYPLAN

DRAWN BY

A B C

CHECKED BY

D E F

ISSUED FOR 95% REVIEW SET

ISSUE DATE MAY 26, 2021

SHEET NAME


SECOND FLOOR PLAN
AND SCHEDULES

ATS&R PROJECT NO. 2 0 0 3 1 . 1

SHEET NUMBER

REVISION NO.

Δ3 2

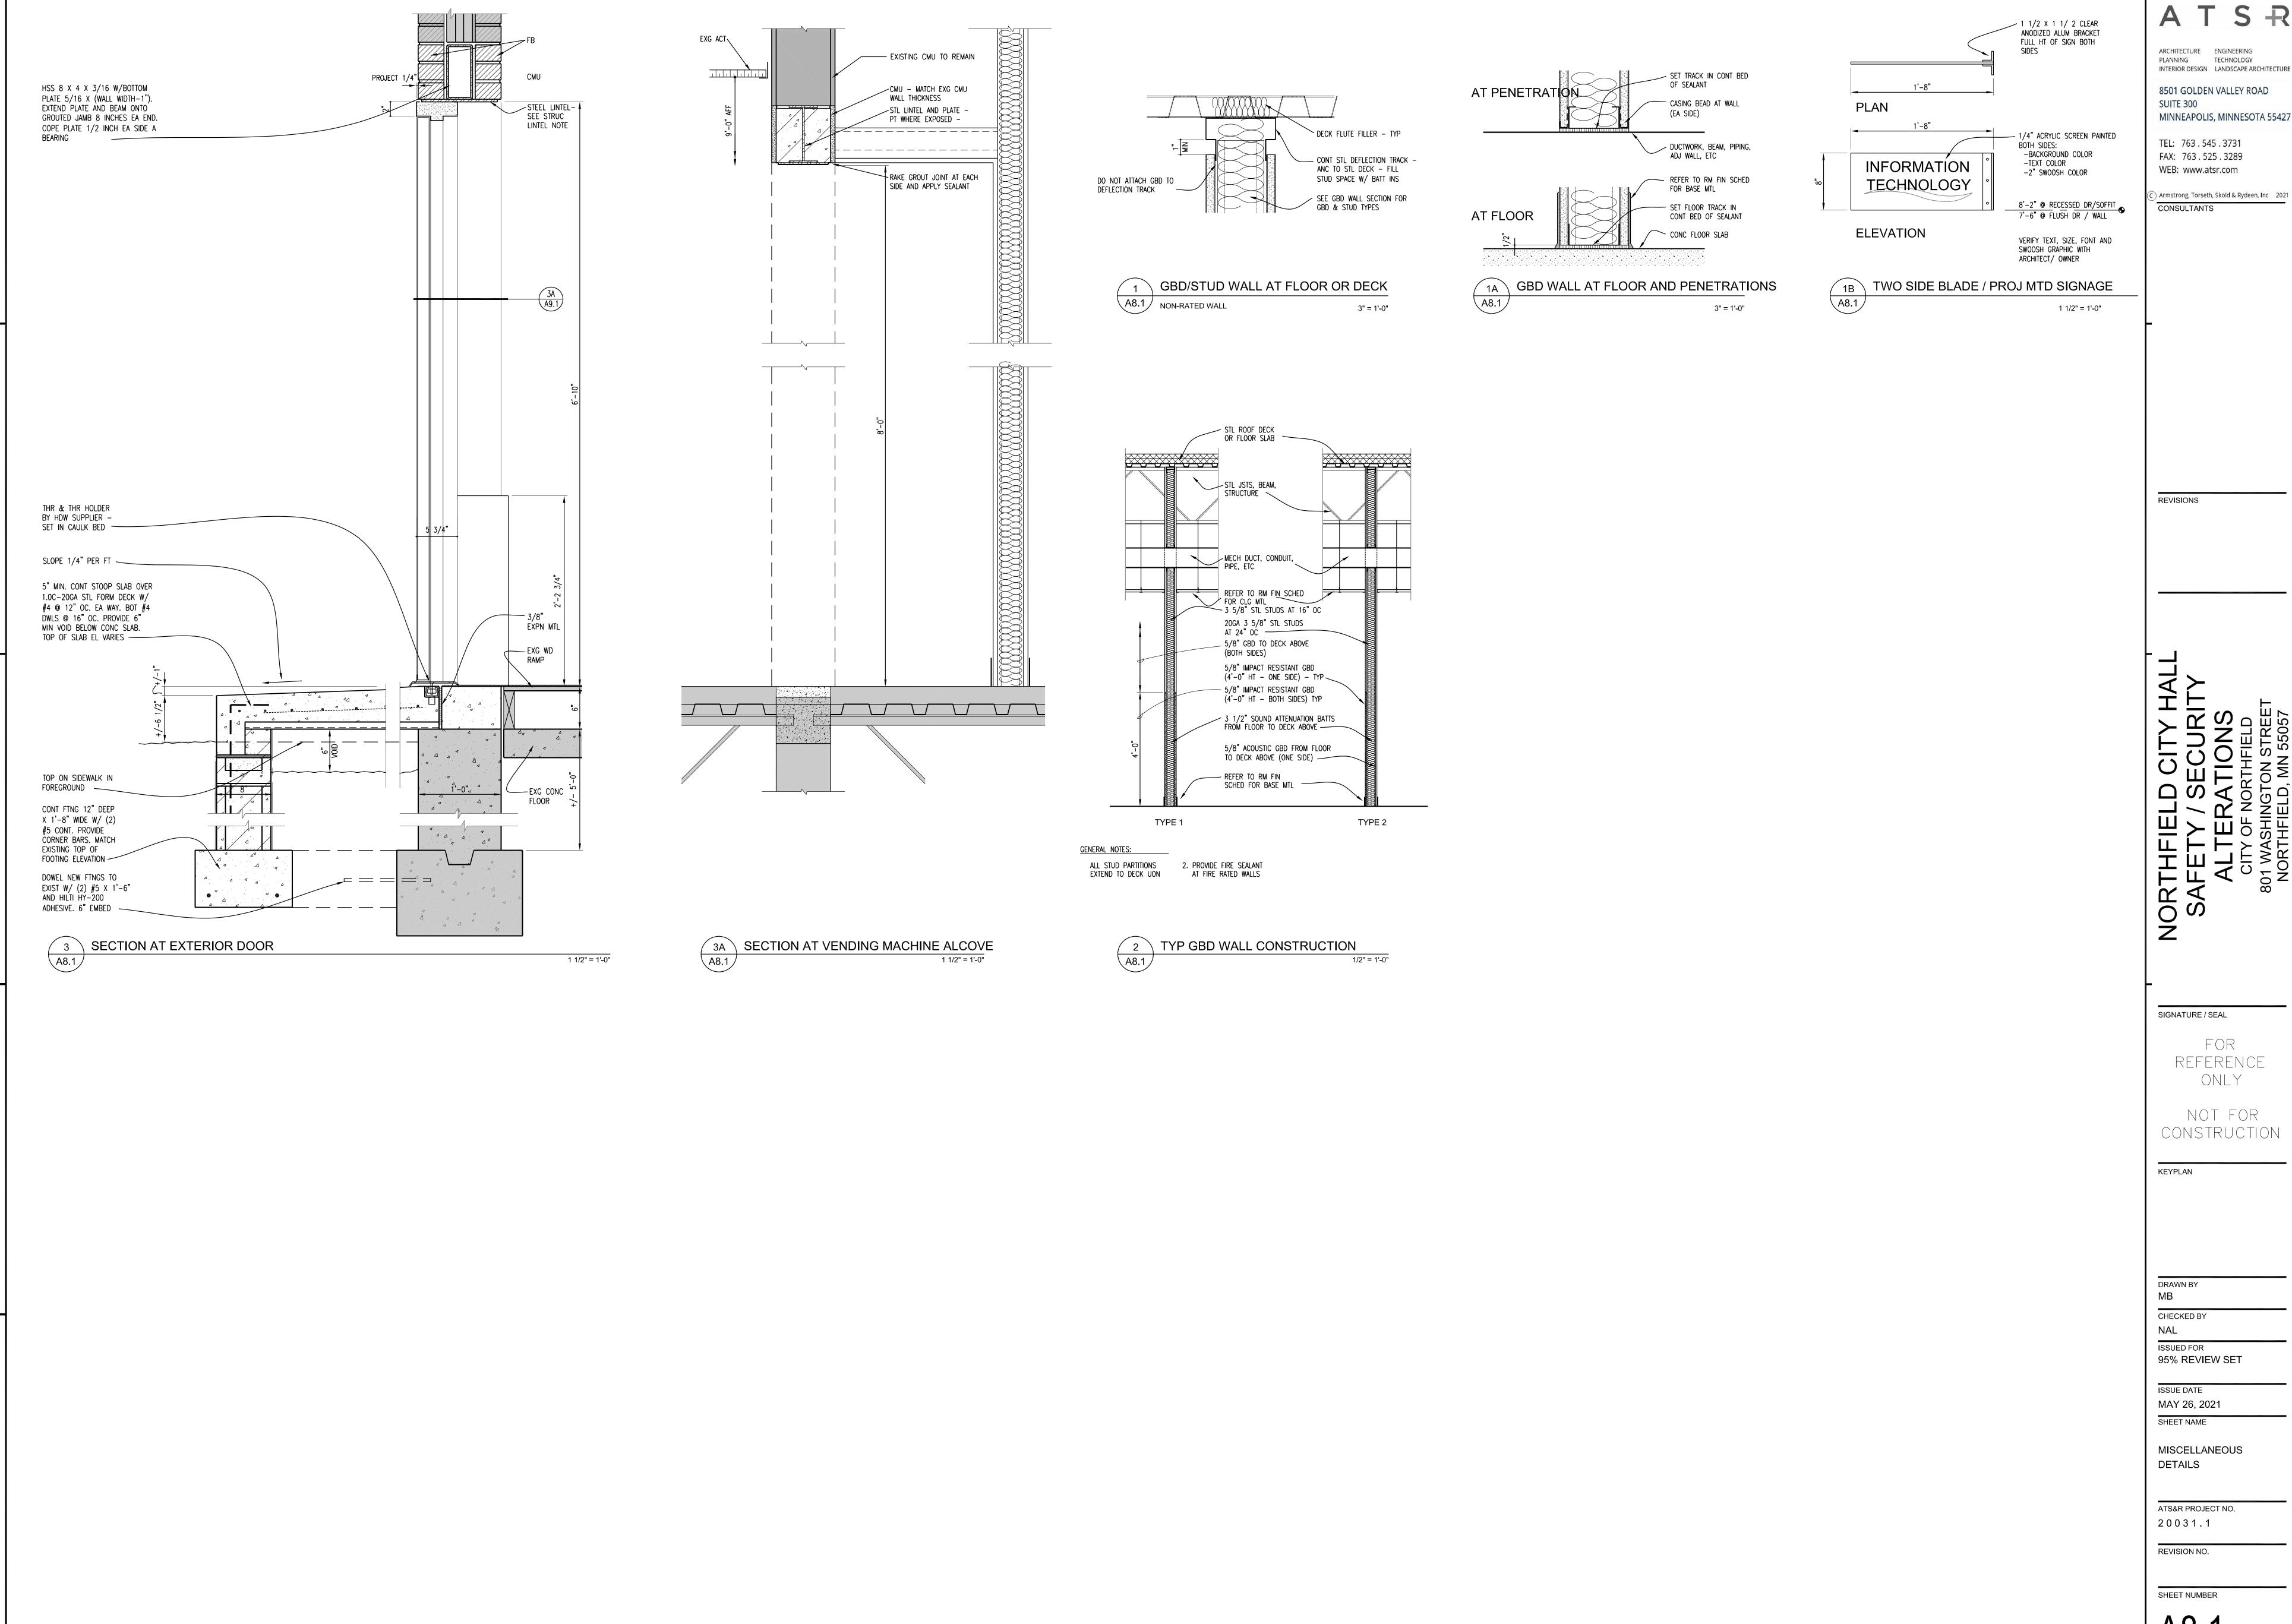

PLANNING TECHNOLOGY INTERIOR DESIGN LANDSCAPE ARCHITECTURE 8501 GOLDEN VALLEY ROAD

MINNEAPOLIS, MINNESOTA 55427 TEL: 763.545.3731

WEB: www.atsr.com

SIGNATURE / SEAL


FOR ONLY


NOT FOR CONSTRUCTION

ISSUED FOR 95% REVIEW SET

MAY 26, 2021 SHEET NAME

20031.1

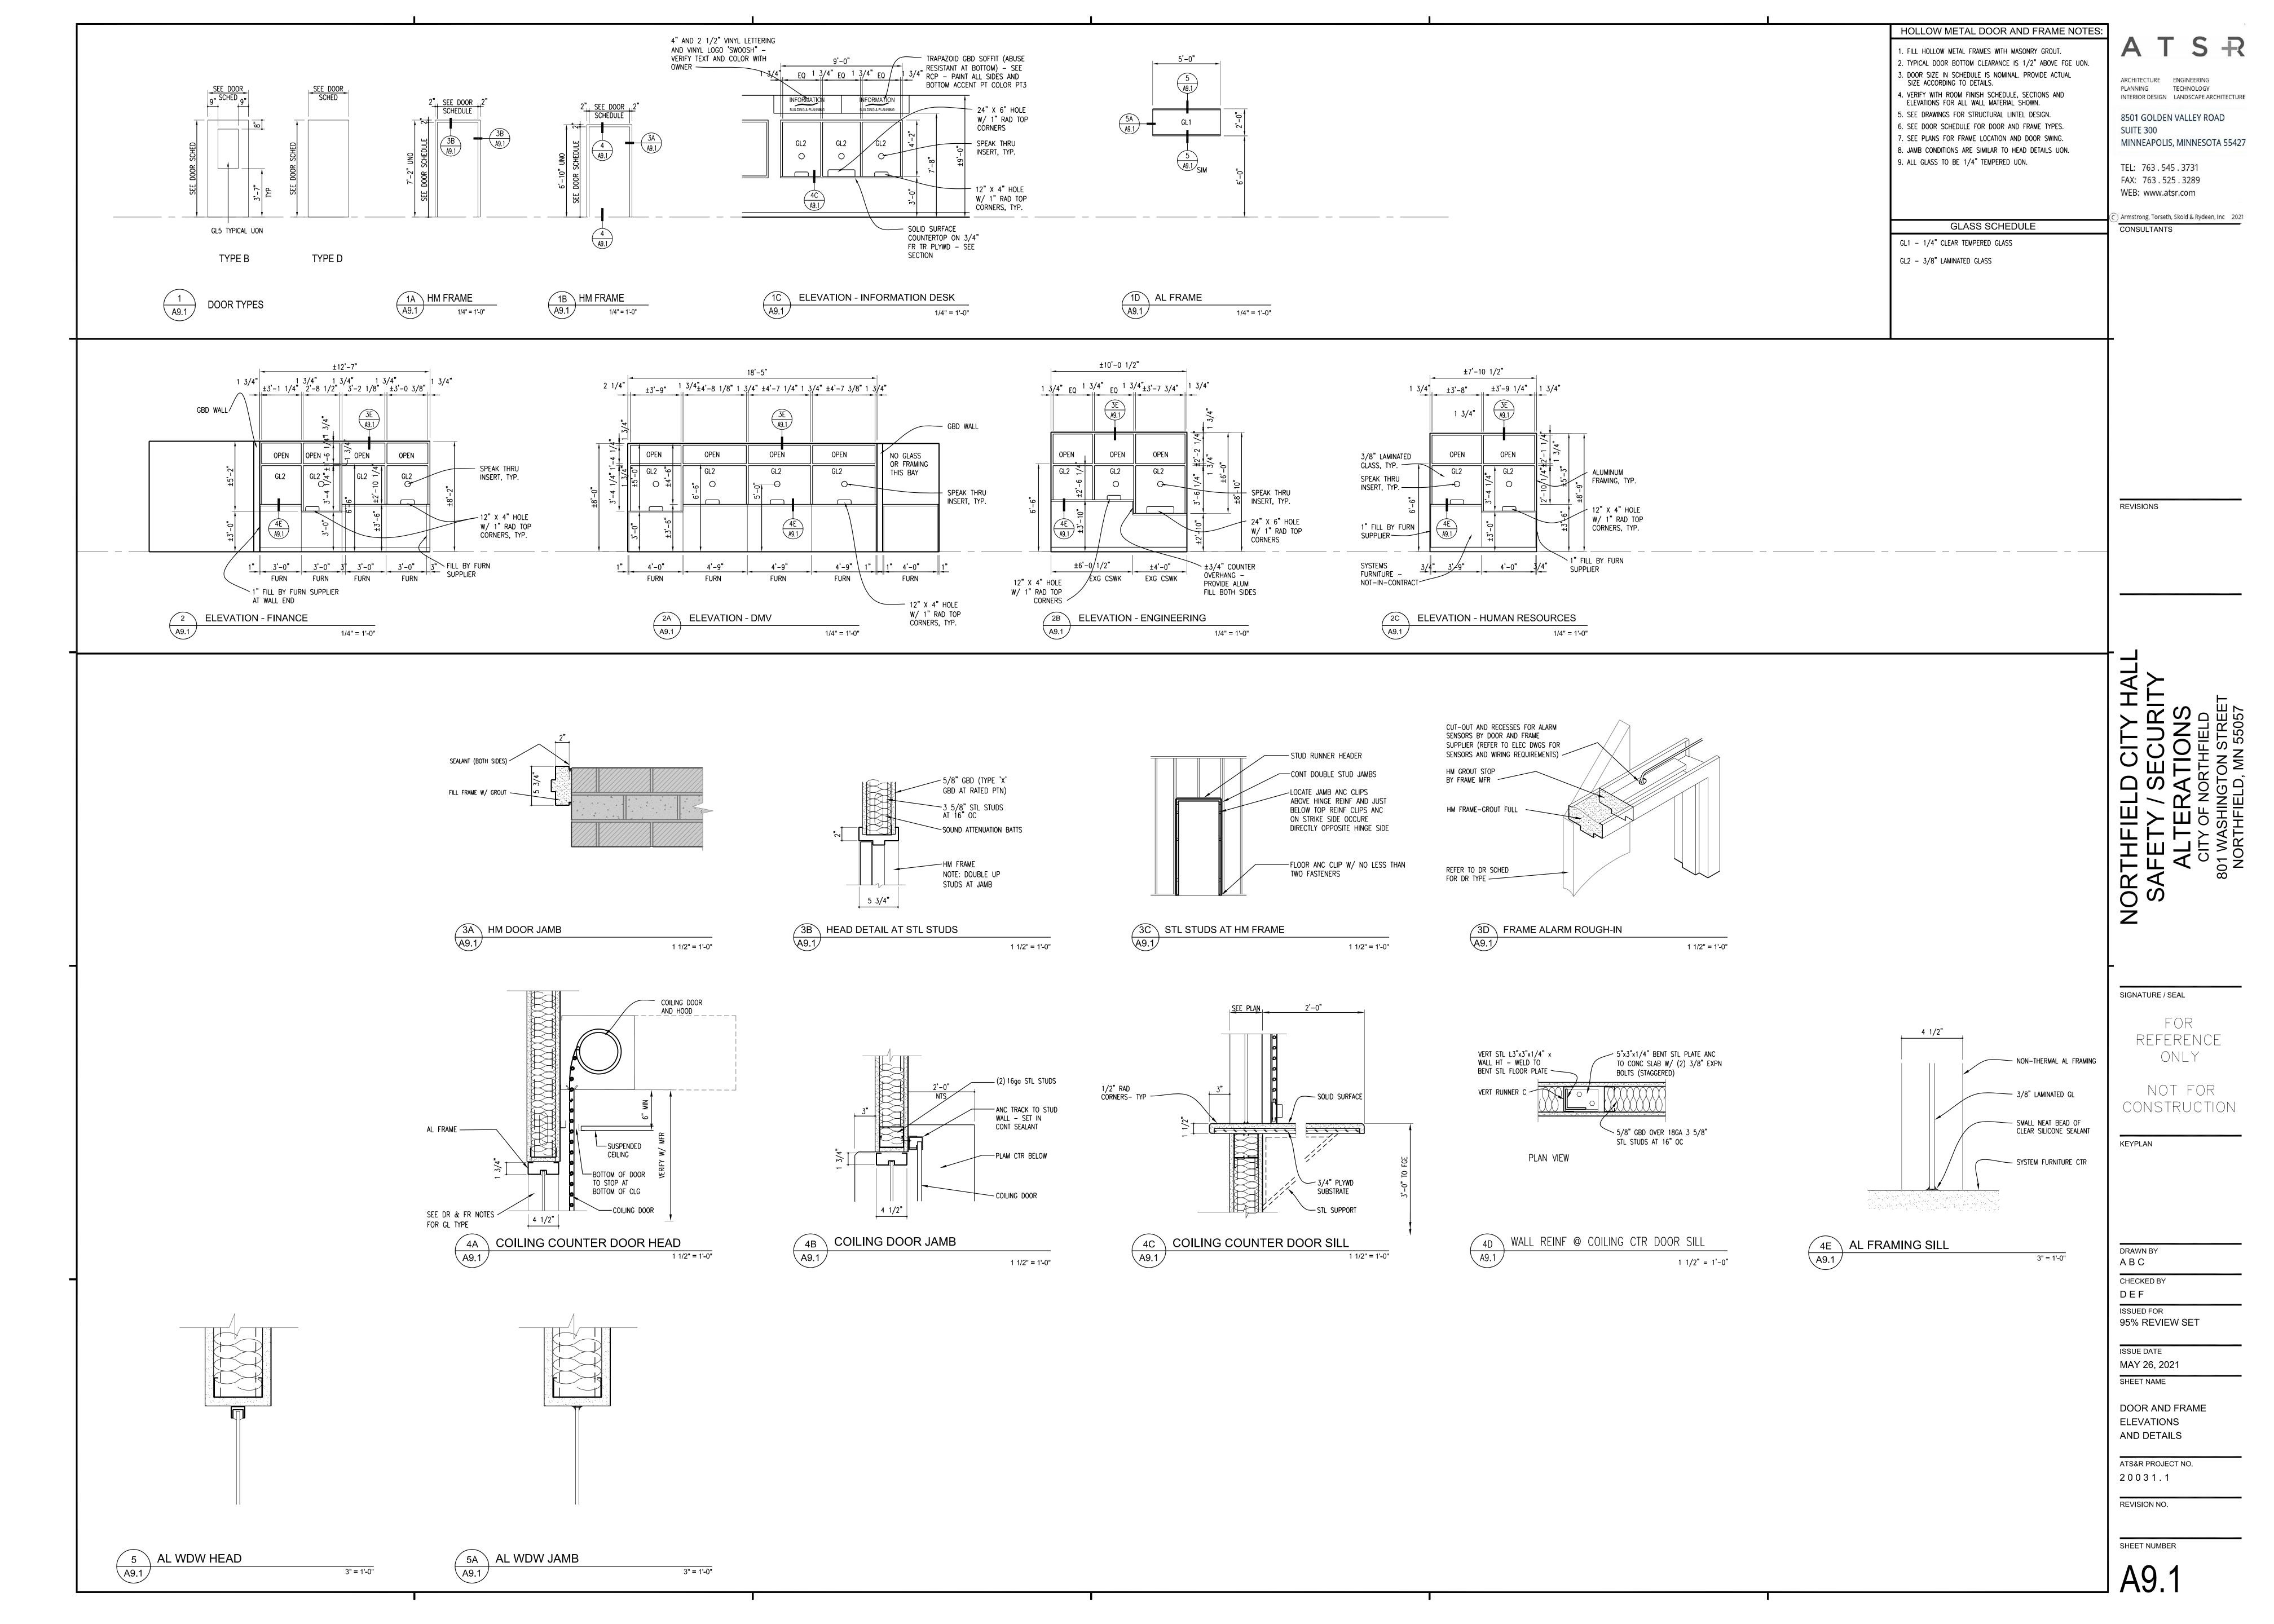

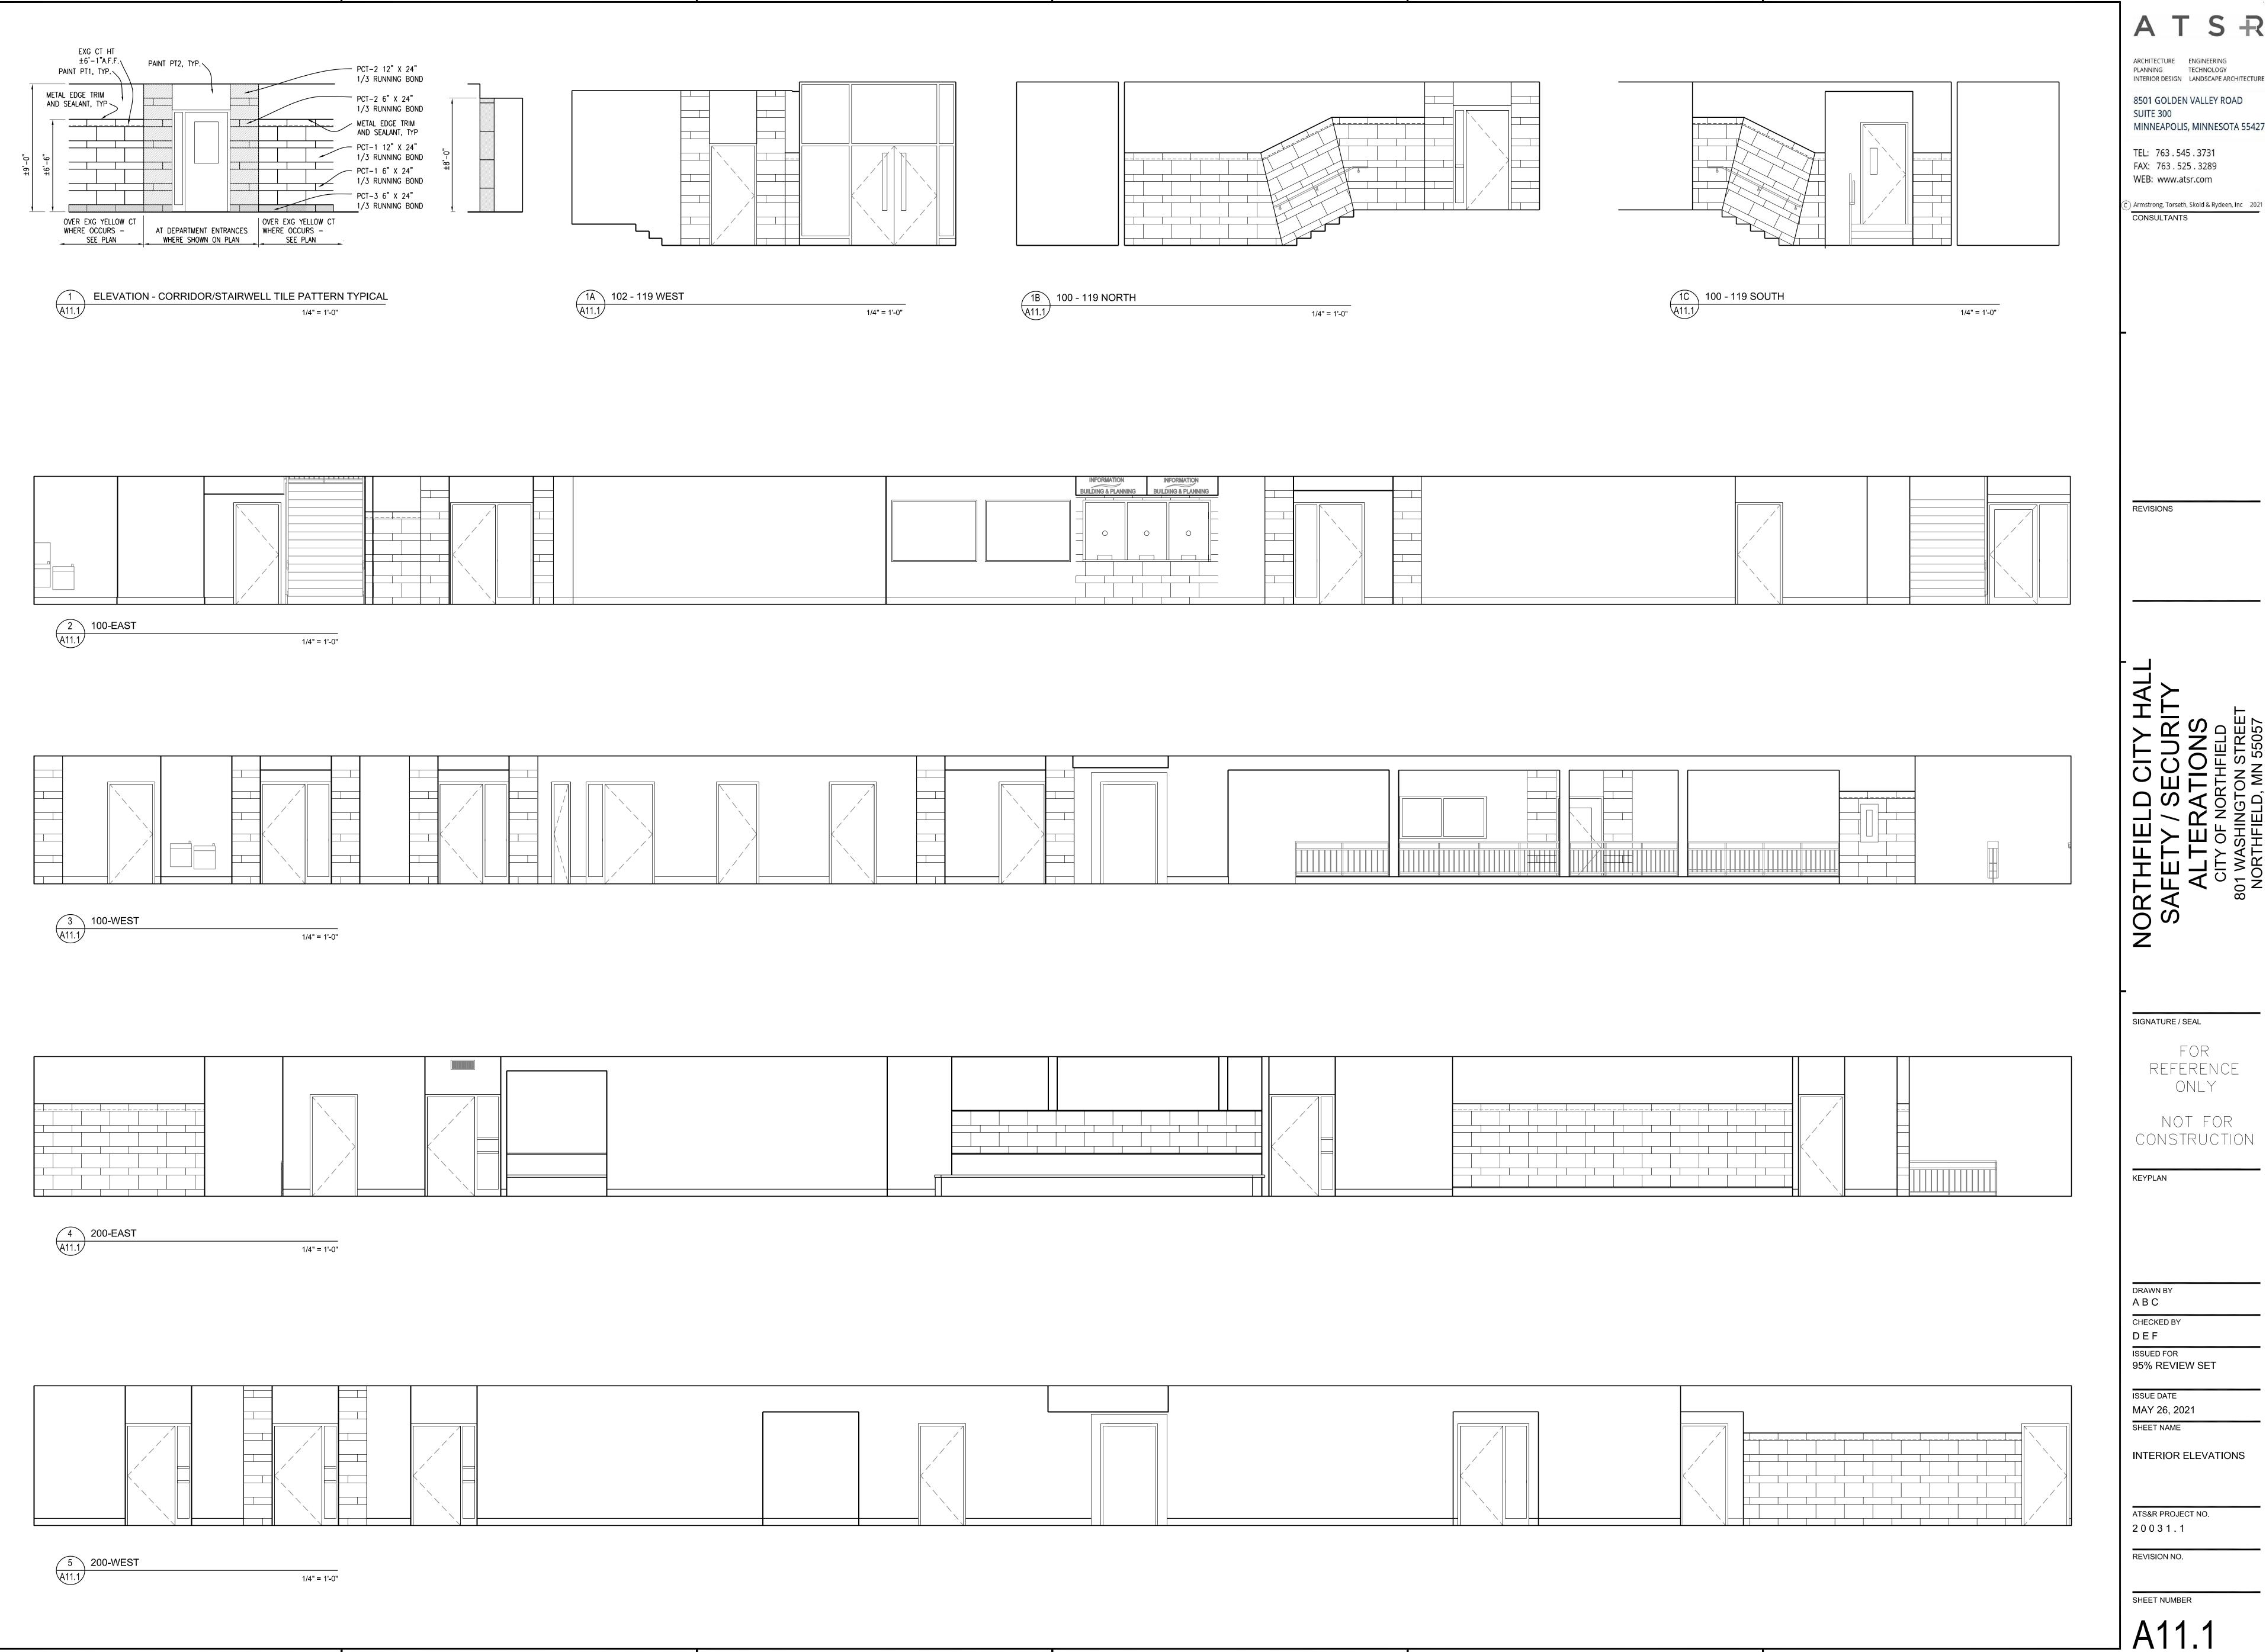

PLANNING TECHNOLOGY INTERIOR DESIGN LANDSCAPE ARCHITECTURE 8501 GOLDEN VALLEY ROAD SUITE 300

MINNEAPOLIS, MINNESOTA 55427 TEL: 763.545.3731

WEB: www.atsr.com

REVISIONS

NORTHFIELD CITY HAL
SAFETY / SECURITY
ALTERATIONS
CITY OF NORTHFIELD
801 WASHINGTON STREET
NORTHFIELD, MN 55057

SIGNATURE / SEAL

ONLY

NOT FOR CONSTRUCTION

KEYPLAN

DRAWN BY АВС

CHECKED BY DEF ISSUED FOR


95% REVIEW SET

MAY 26, 2021

SHEET NAME

ATS&R PROJECT NO. 20031.1

REVISION NO.

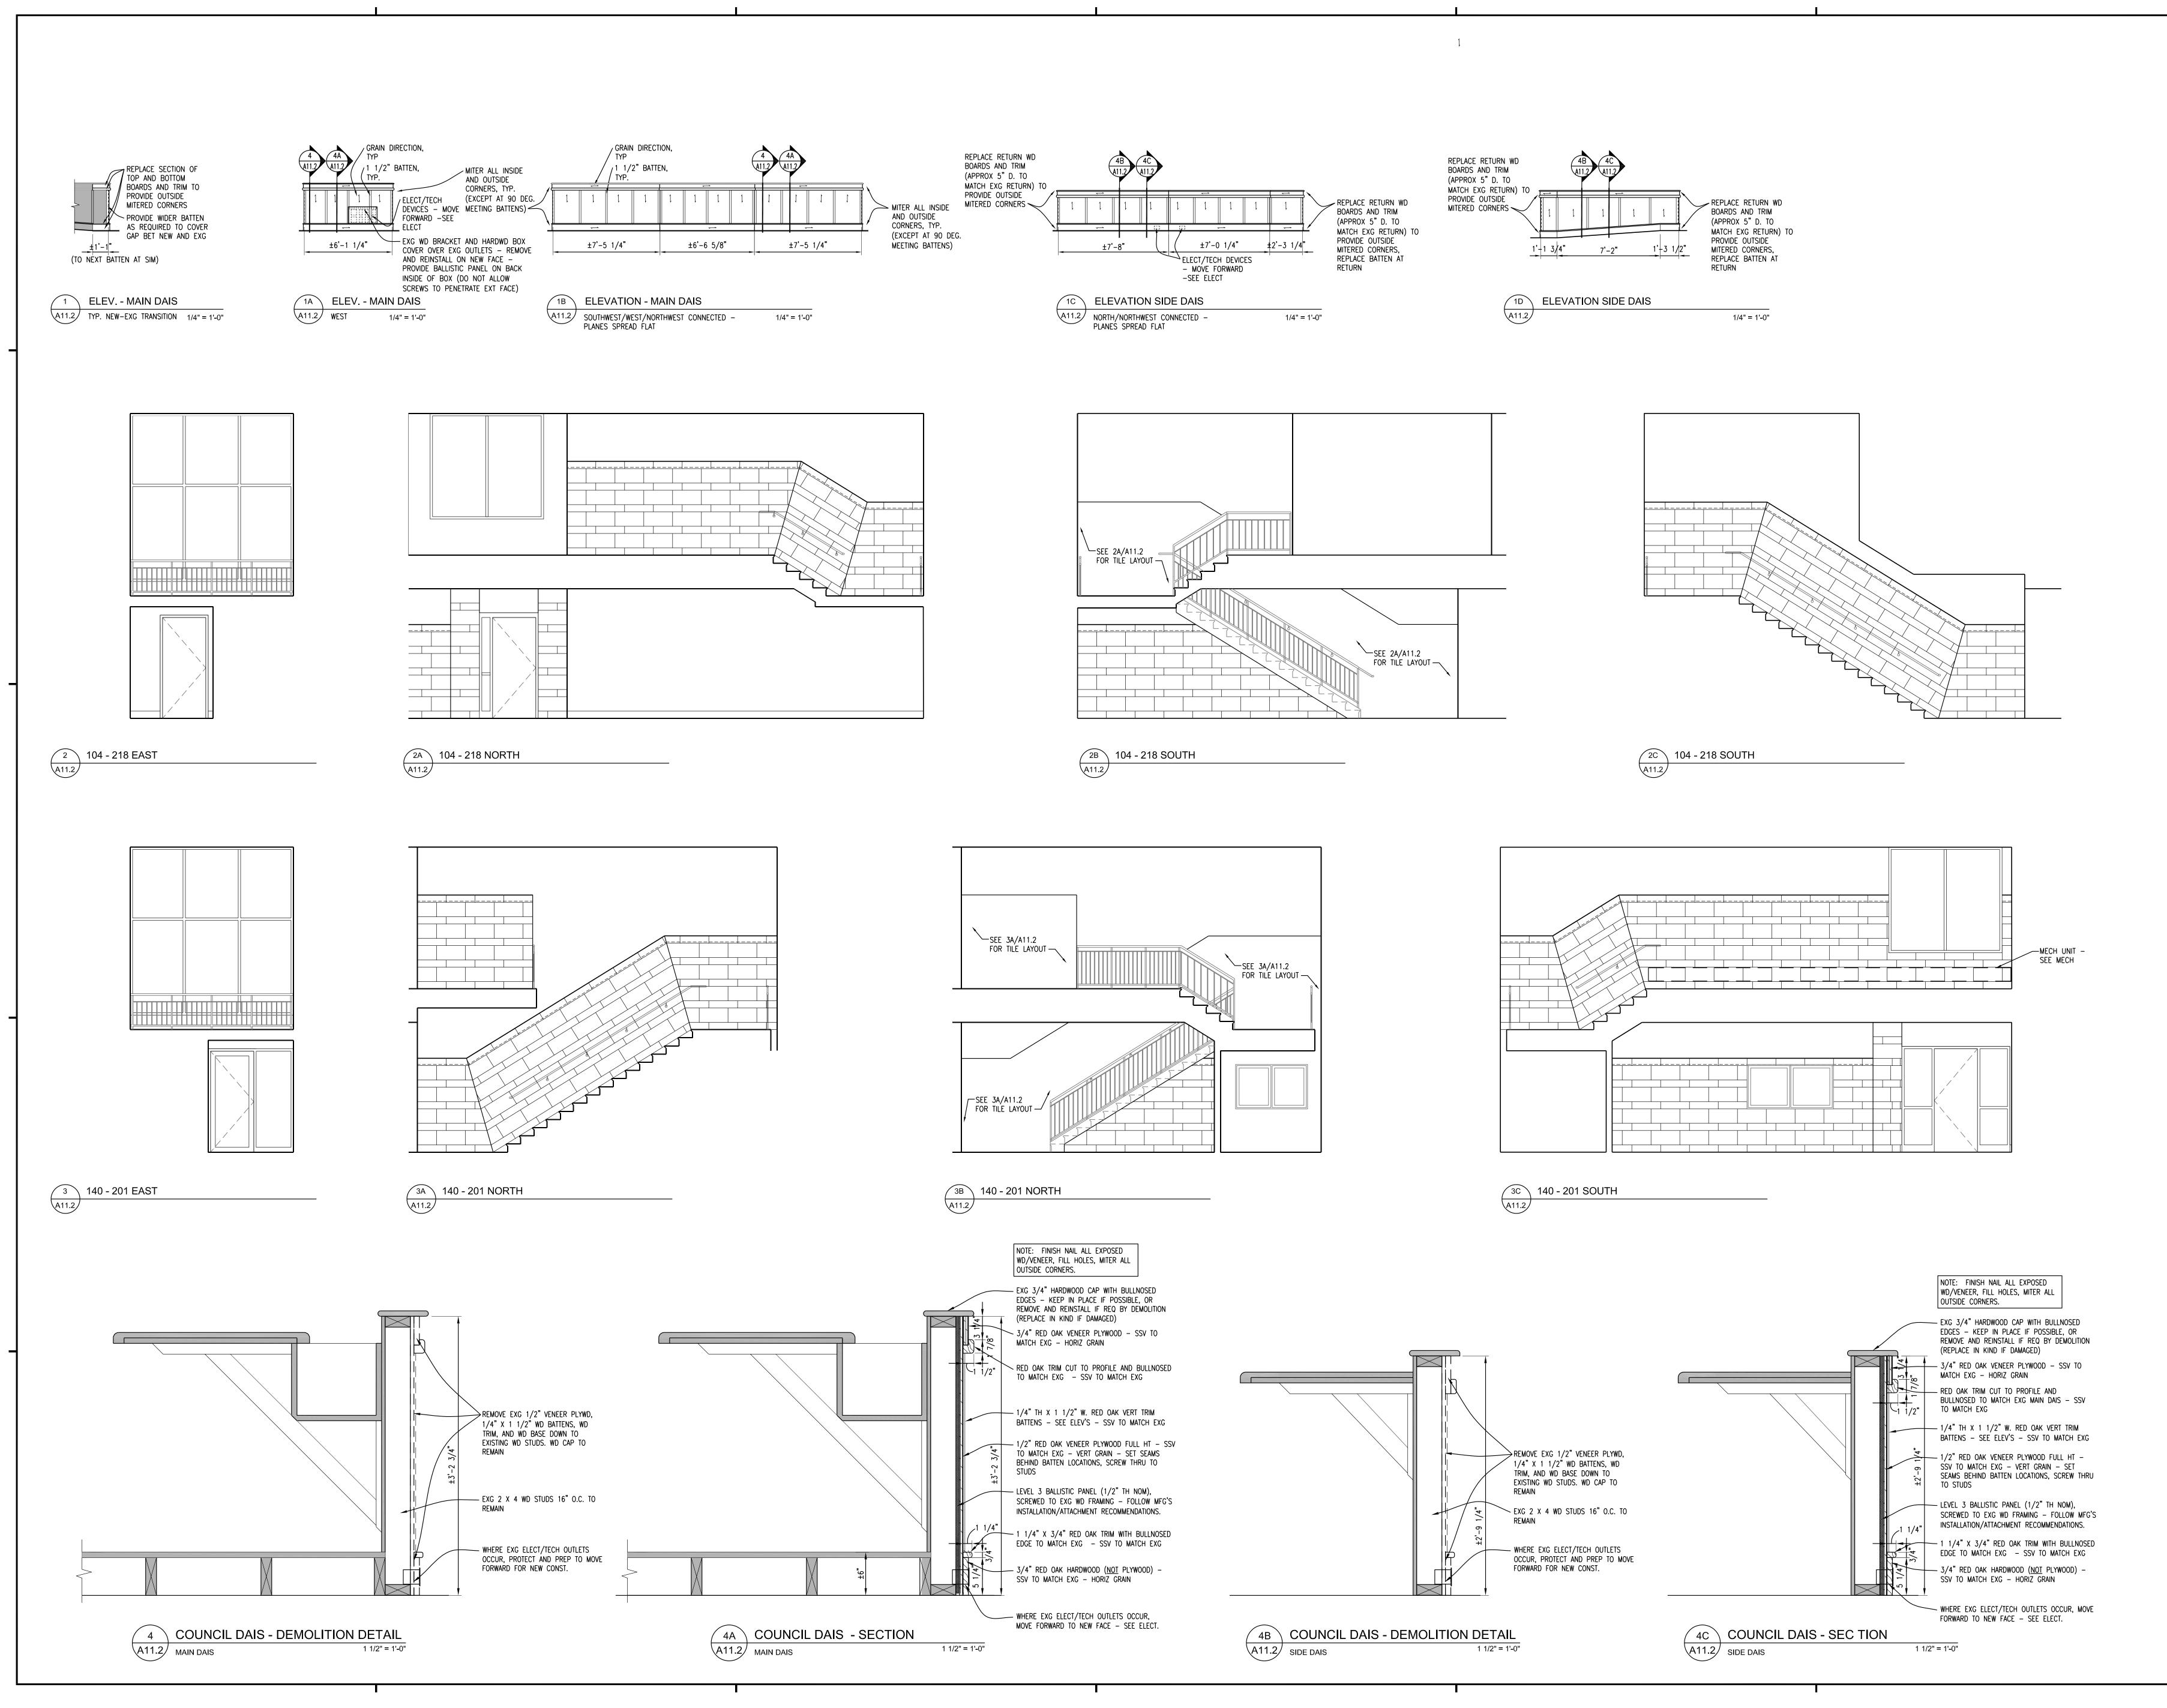

ATSR

PLANNING TECHNOLOGY
INTERIOR DESIGN LANDSCAPE ARCHITECTURE

8501 GOLDEN VALLEY ROAD
SUITE 300
MINNEAPOLIS, MINNESOTA 55427

ARCHITECTURE ENGINEERING

TEL: 763 . 545 . 3731 FAX: 763 . 525 . 3289 WEB: www.atsr.com

Armstrong, Torseth, Skold & Rydeen, Inc 2021
CONSULTANTS

REVISIONS

SAFETY / SECURITY
ALTERATIONS
CITY OF NORTHFIELD
S01 WASHINGTON STREET

SIGNATURE / SEAL

FOR REFERENCE ONLY

NOT FOR ONSTRUCTION

EYPLAN

DRAWN BY
A B C
CHECKED BY
D E F

ISSUED FOR 95% REVIEW SET

ISSUE DATE

MAY 26, 2021
SHEET NAME


INTERIOR ELEVATIONS
AND DETAILS

ATS&R PROJECT NO. 2 0 0 3 1 . 1

REVISION NO.

SHEET NUMBER

A11.2

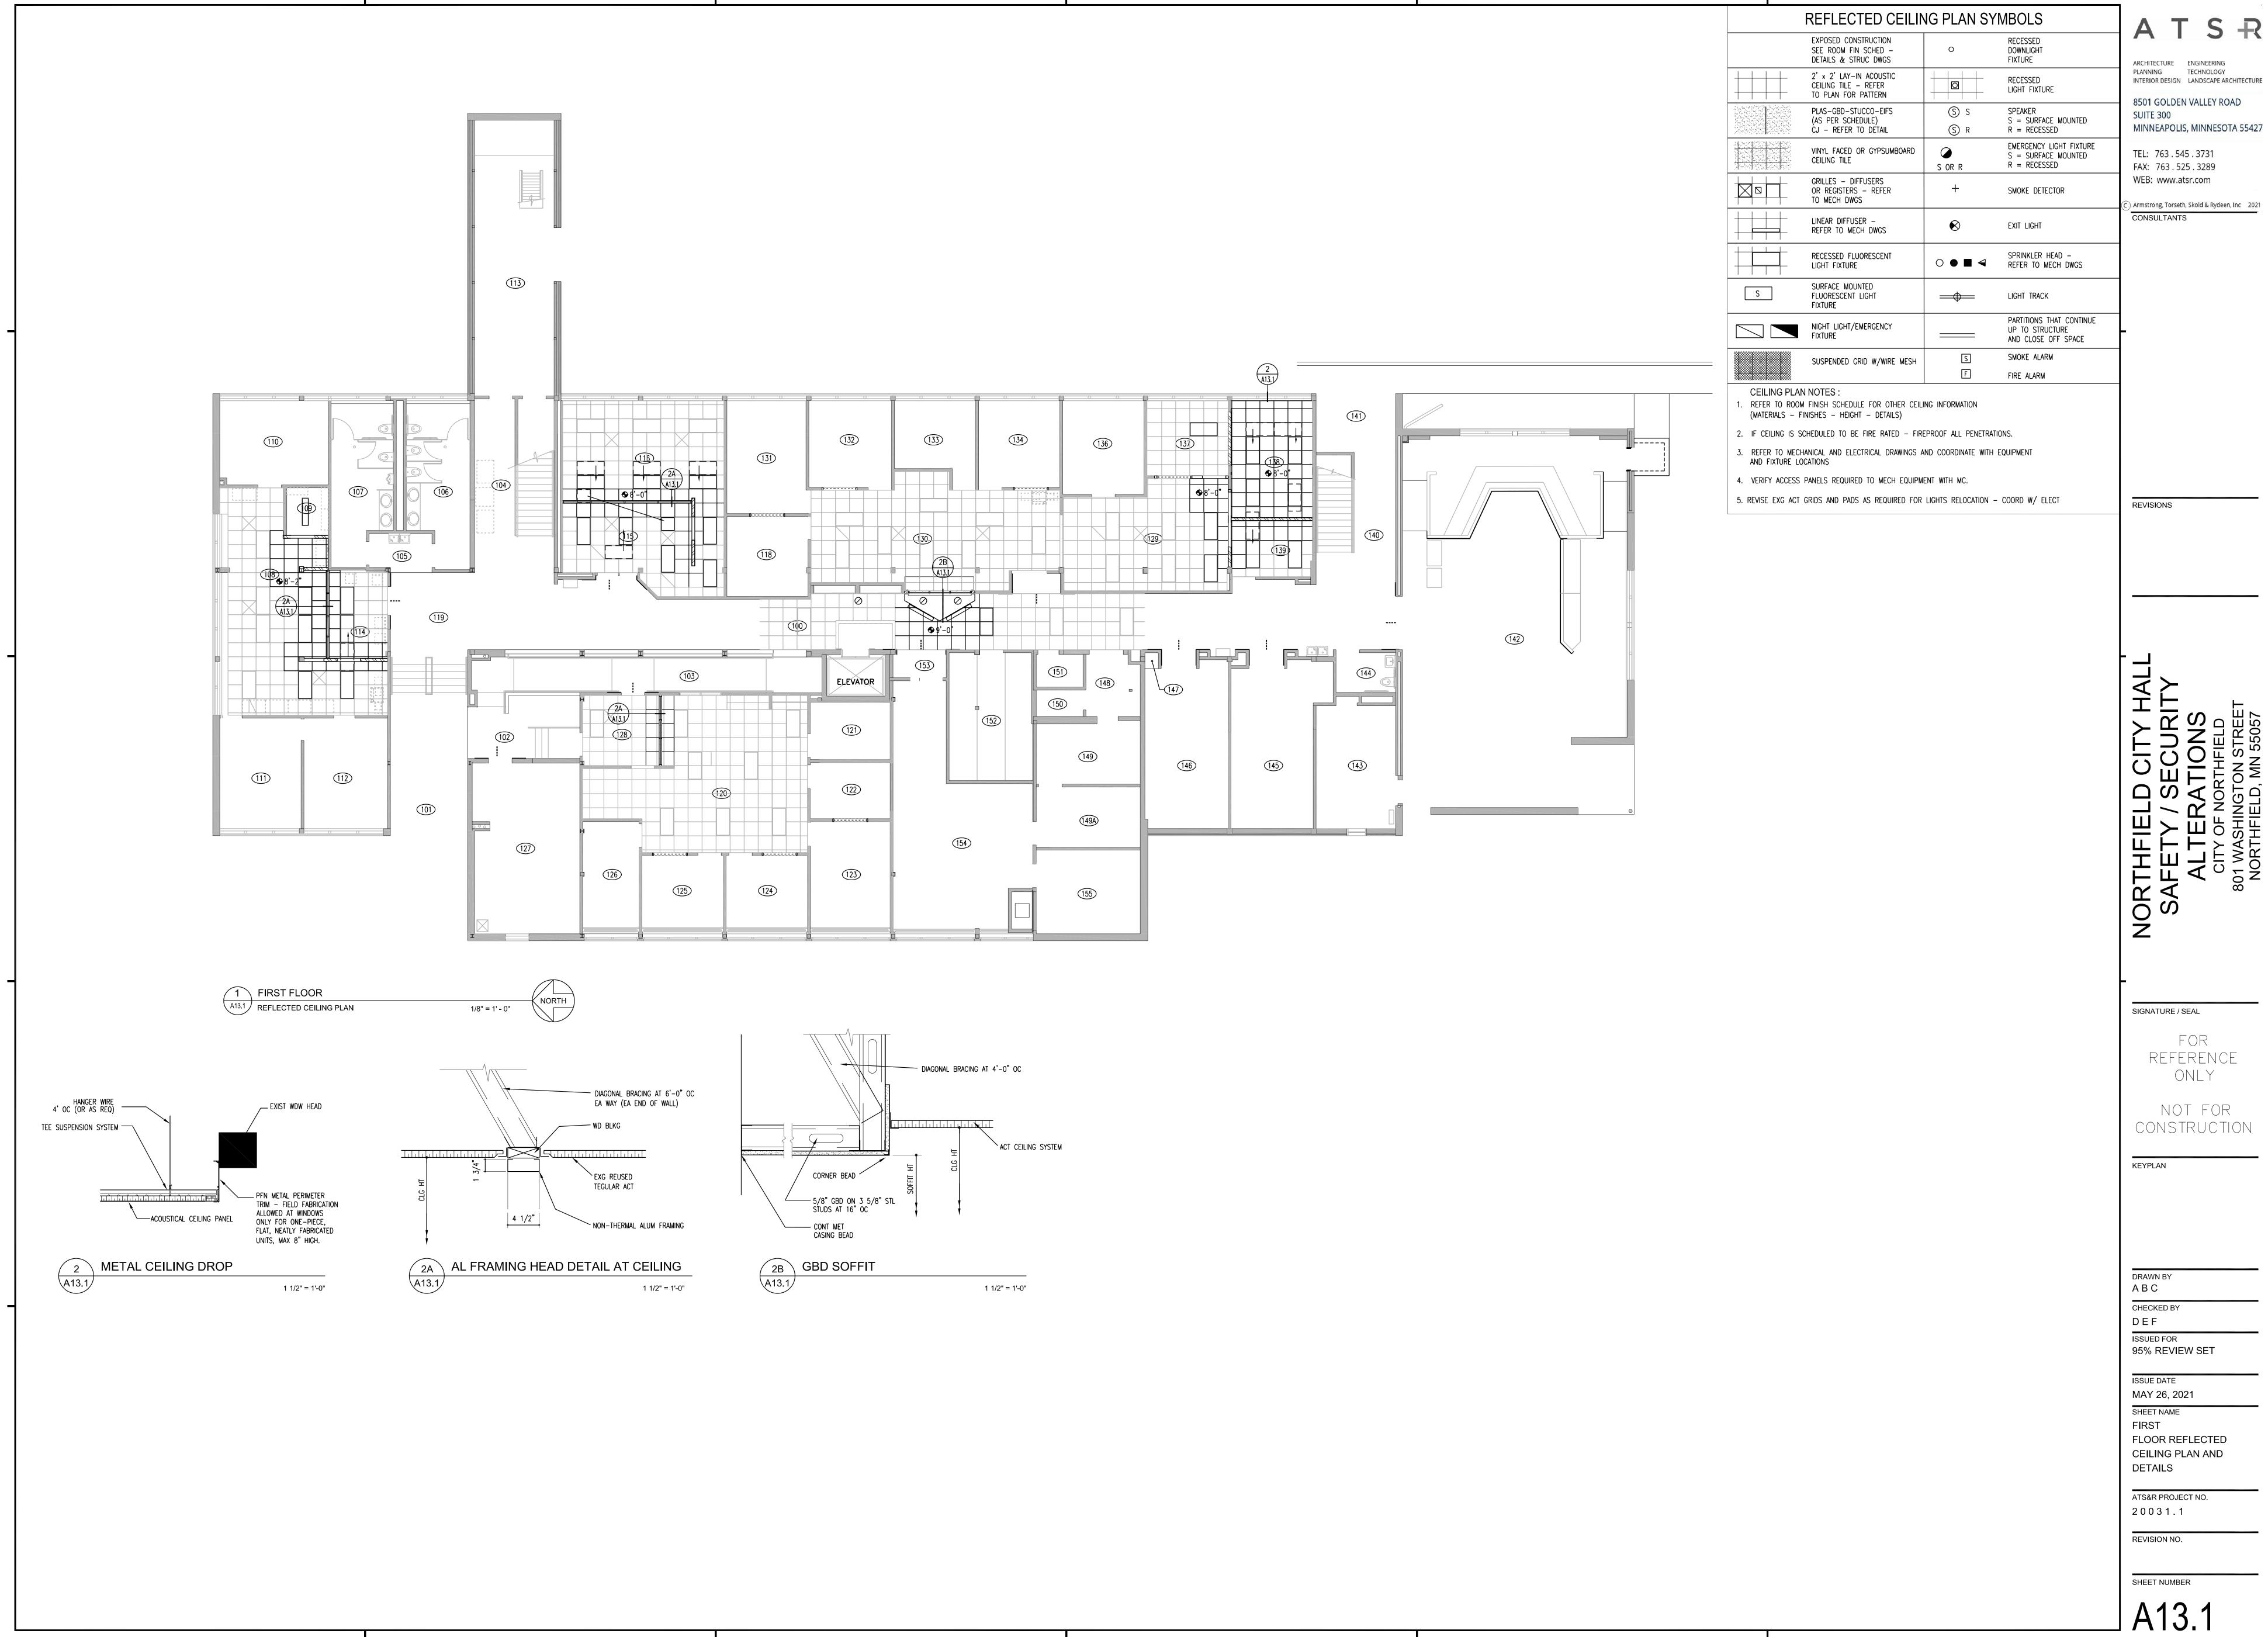


PLANNING TECHNOLOGY INTERIOR DESIGN LANDSCAPE ARCHITECTURE 8501 GOLDEN VALLEY ROAD


FAX: 763.525.3289

Armstrong, Torseth, Skold & Rydeen, Inc 2021

NOT FOR

FLOOR REFLECTED **CEILING PLAN AND**

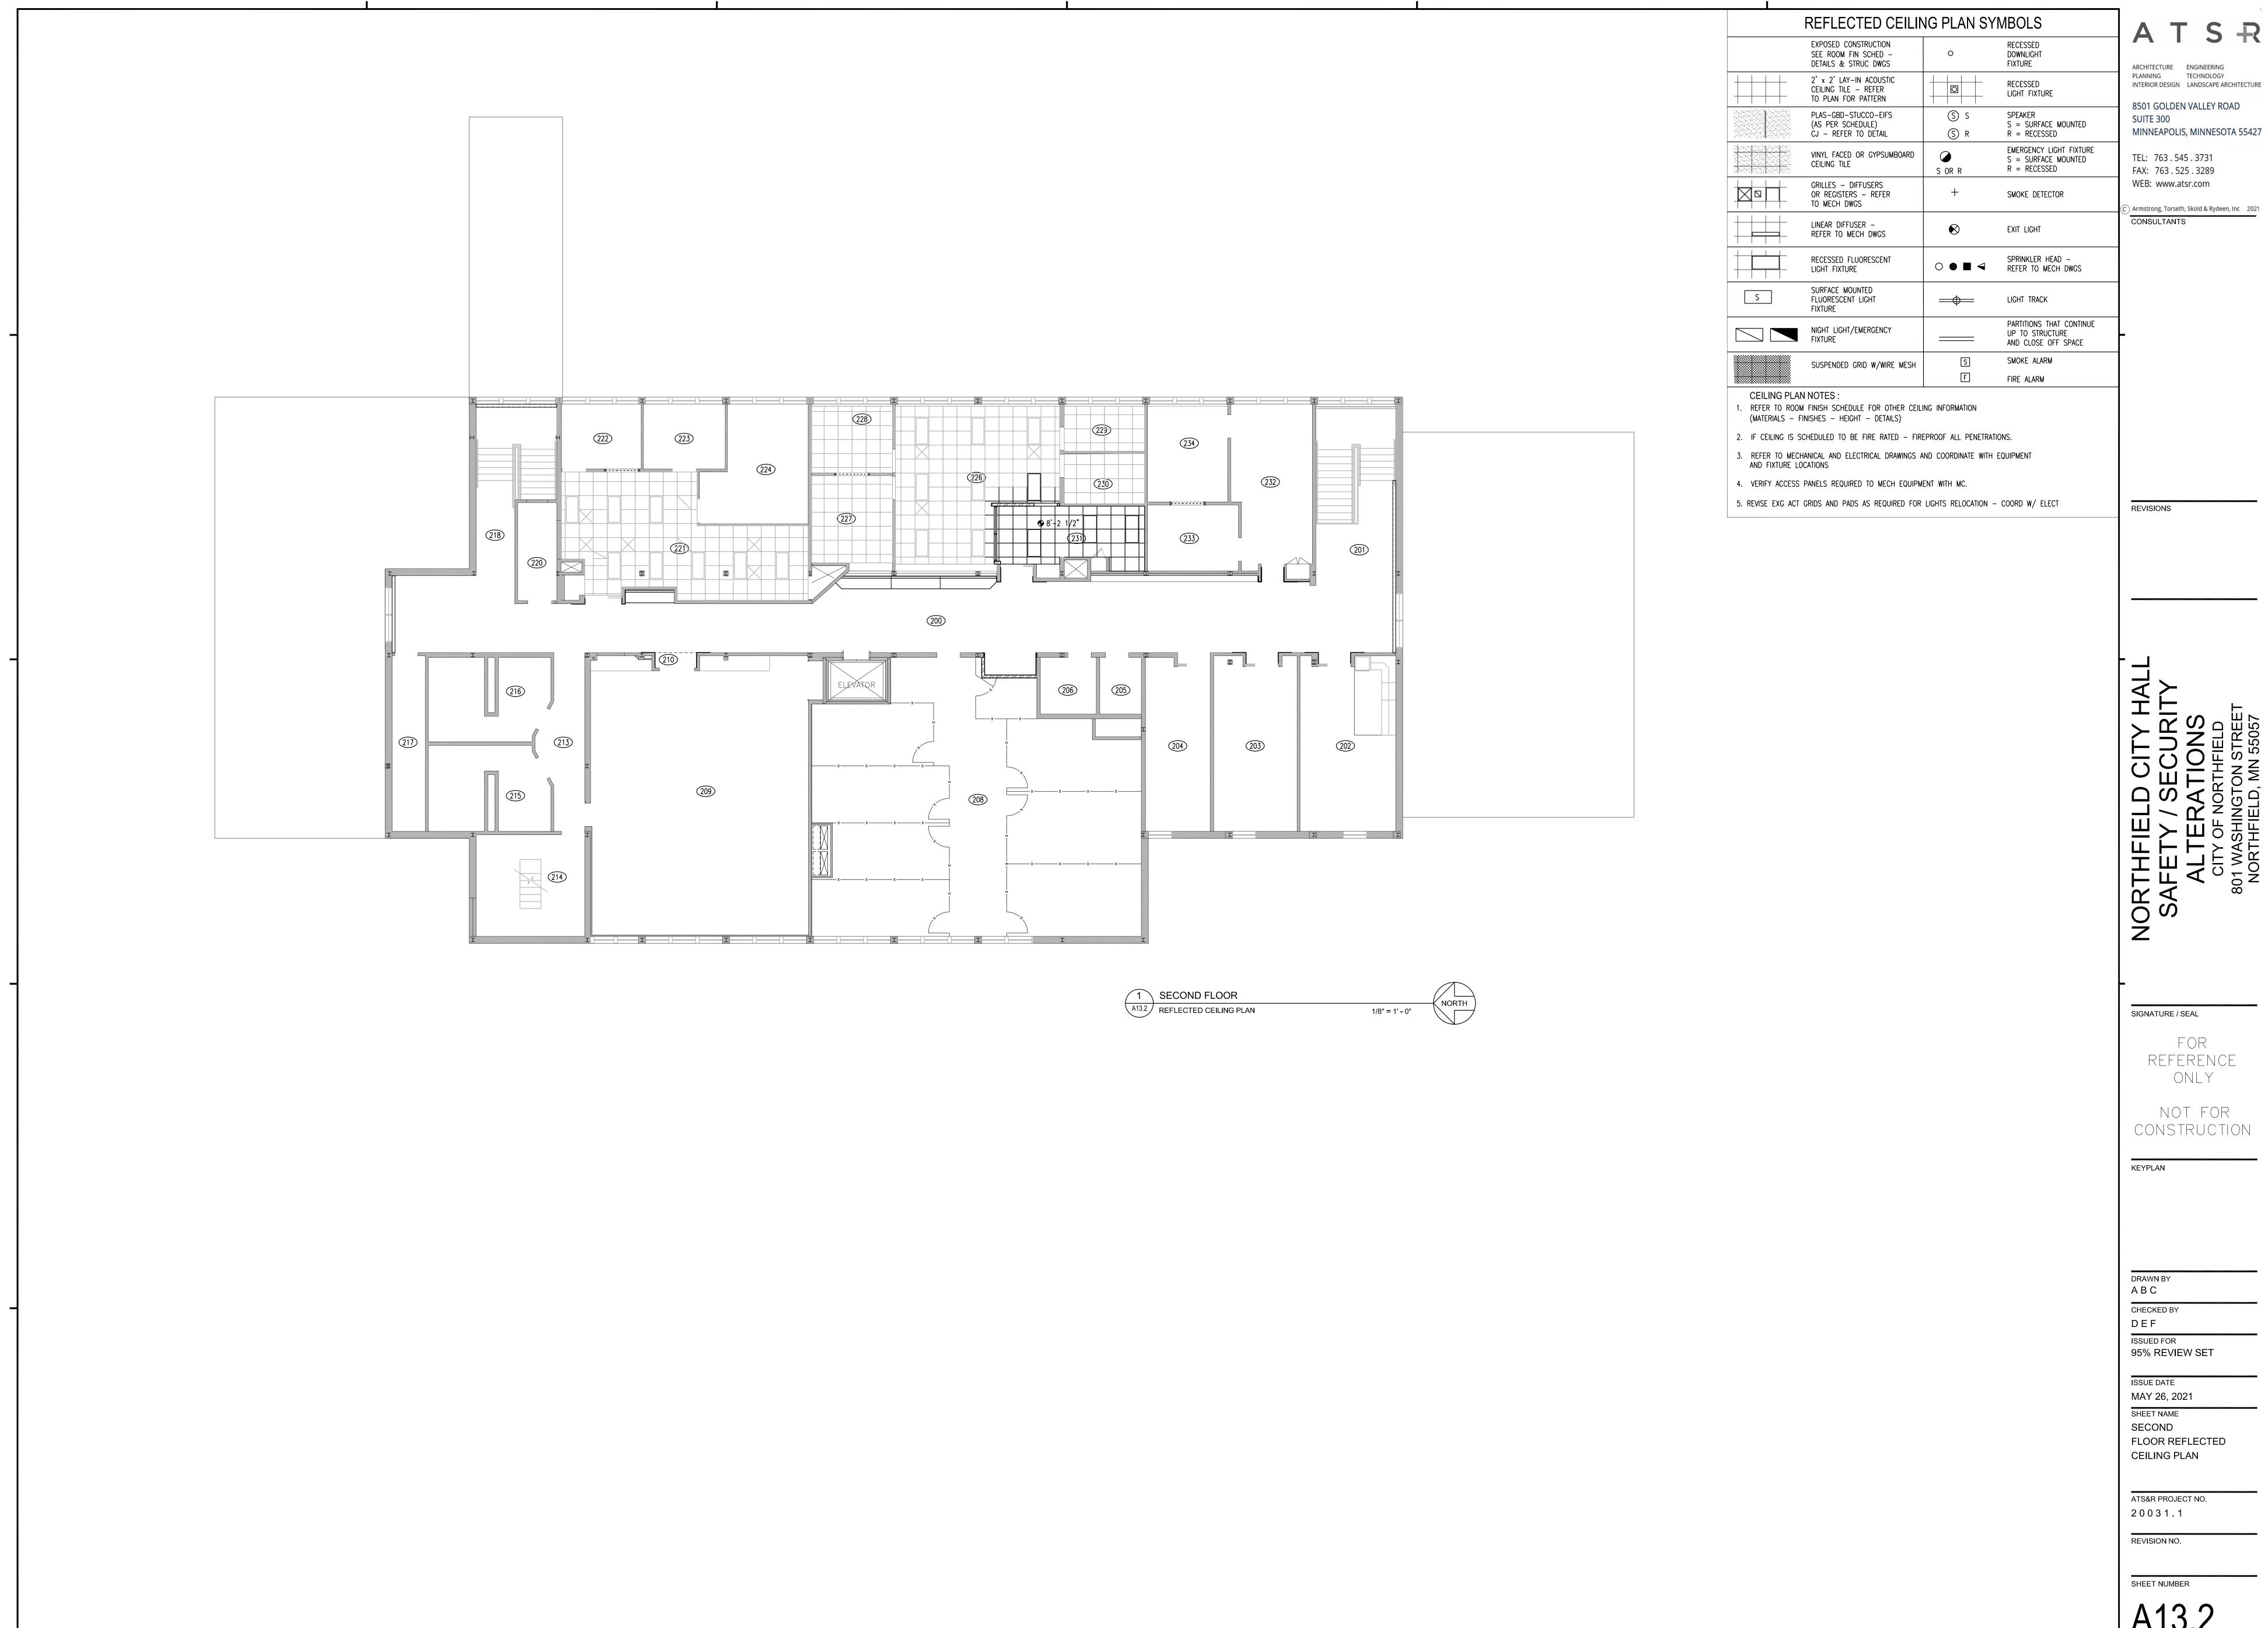

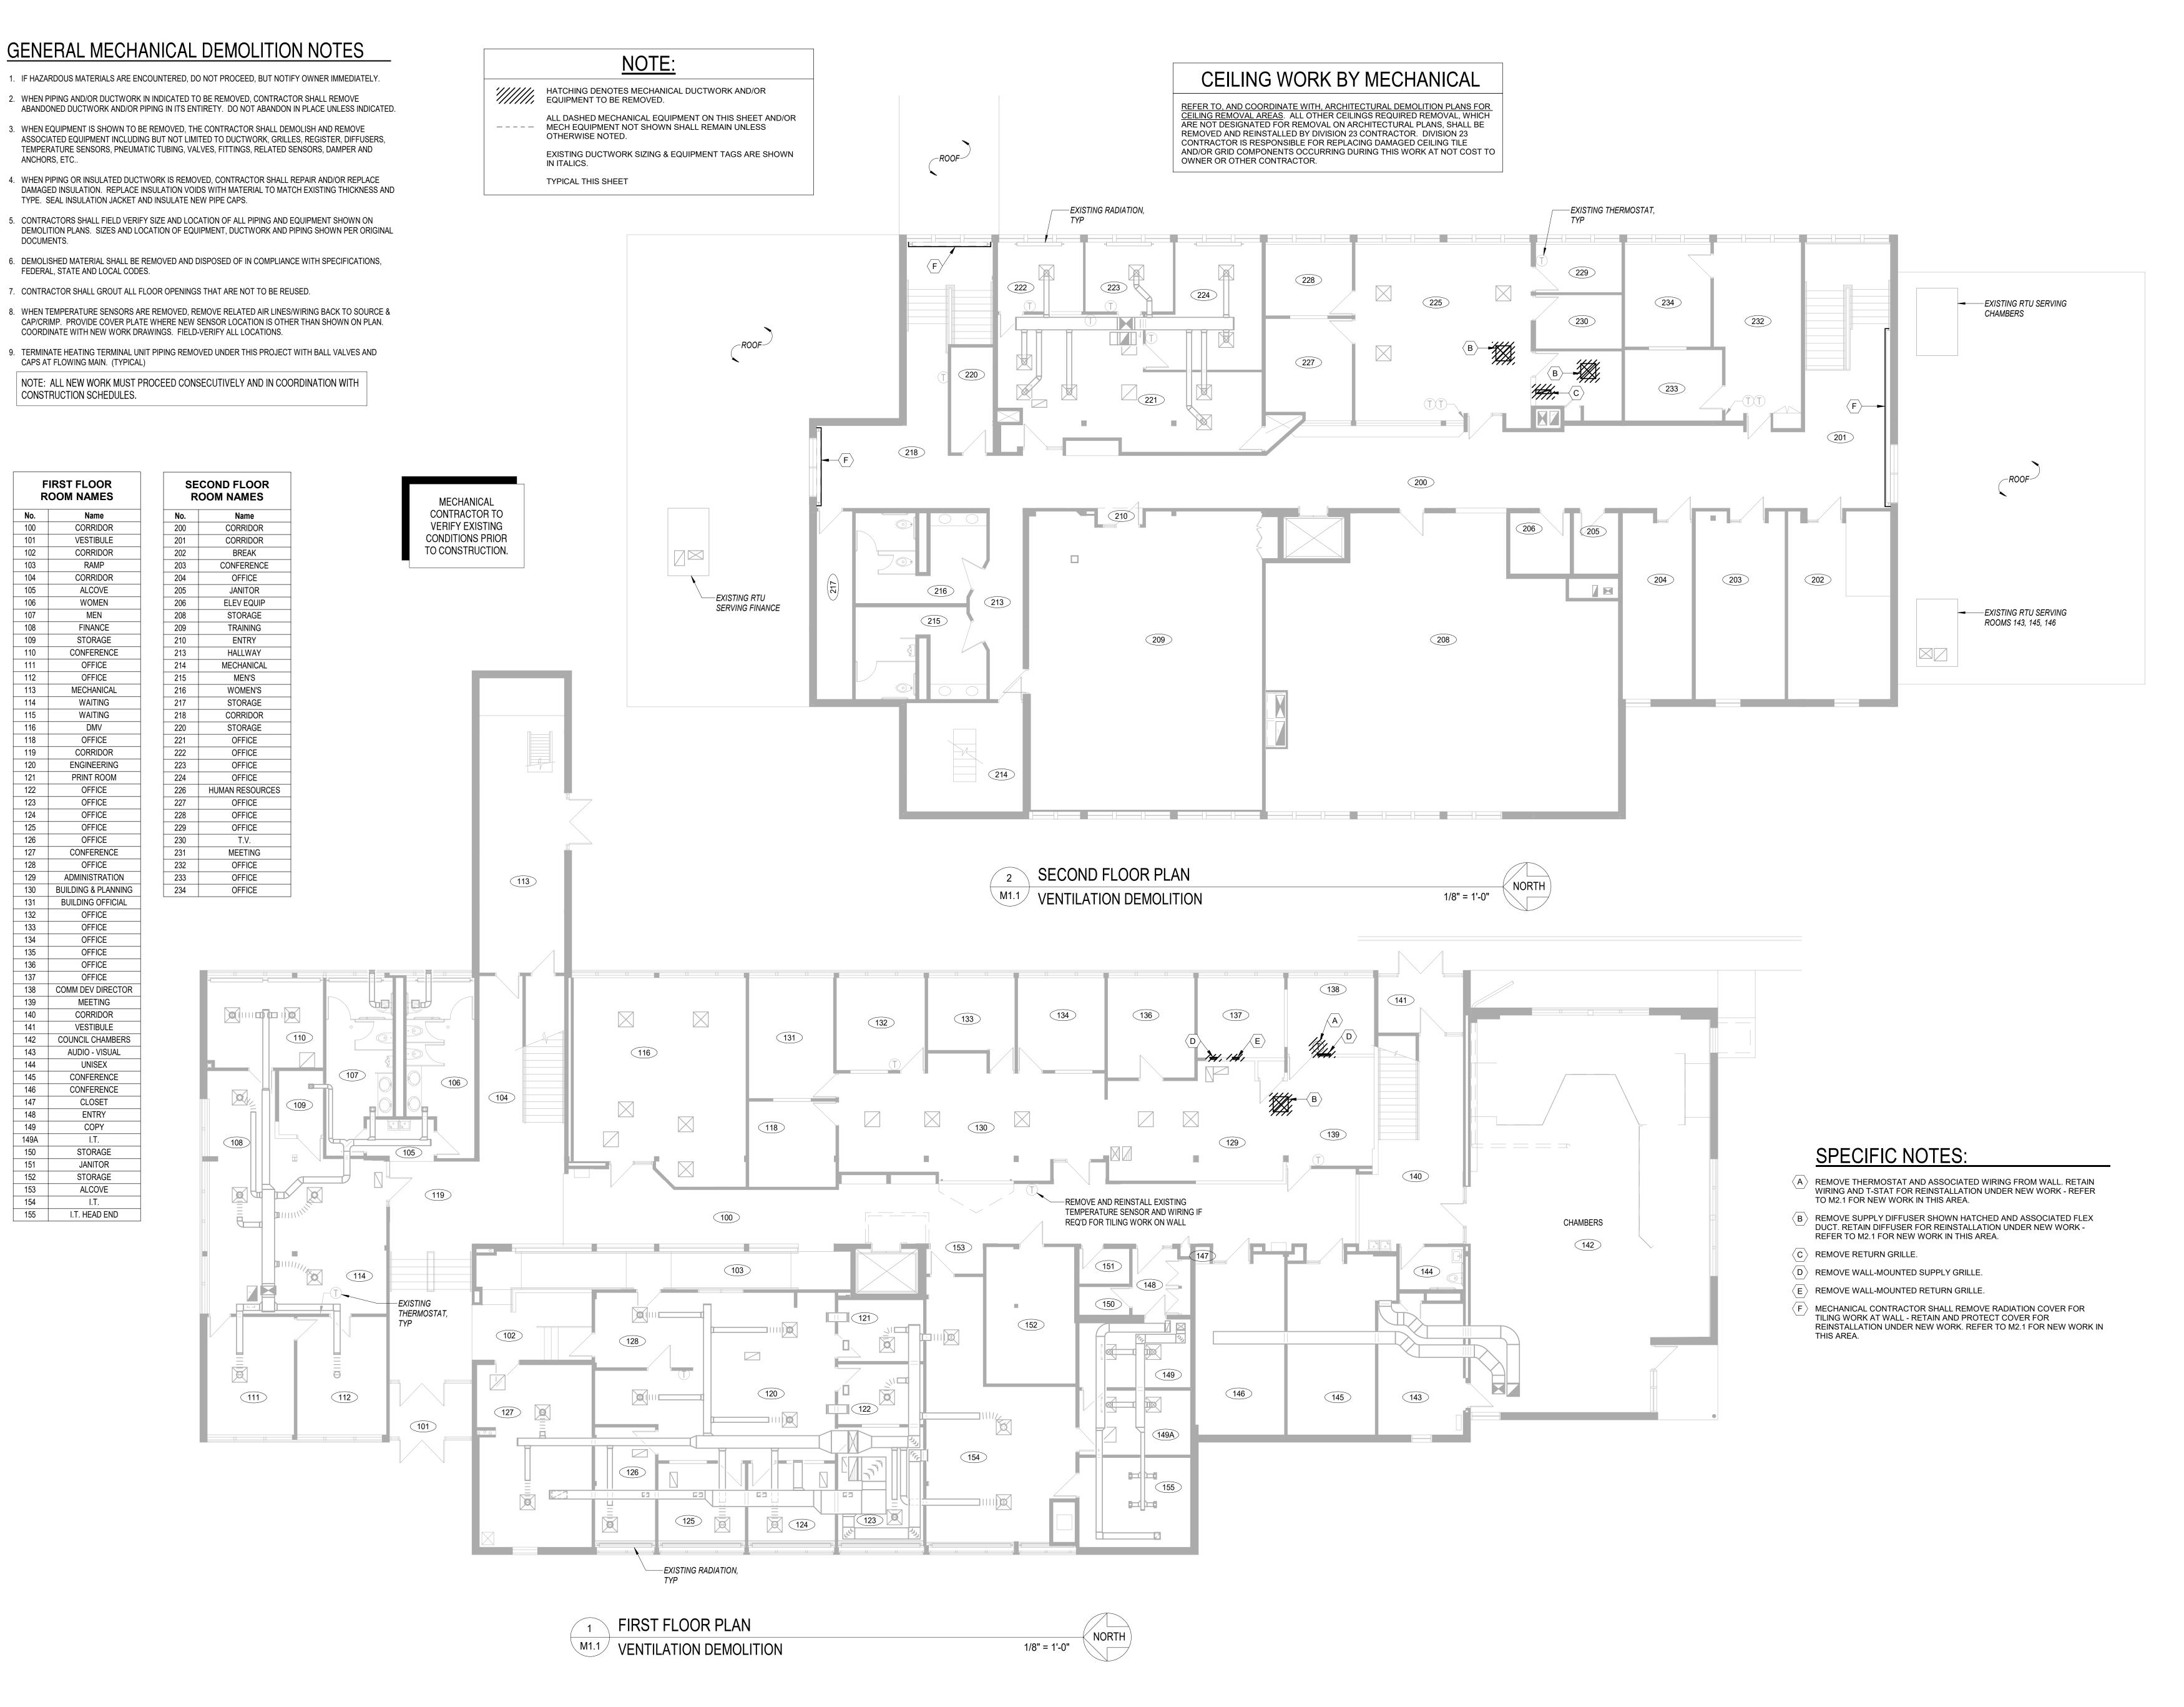

ATSR

ARCHITECTURE ENGINEERING
PLANNING TECHNOLOGY
INTERIOR DESIGN LANDSCAPE ARCHITECTURE

8501 GOLDEN VALLEY ROAD SUITE 300 MINNEAPOLIS, MINNESOTA 55427

TEL: 763 . 545 . 3731 FAX: 763 . 525 . 3289 WEB: www.atsr.com

C Armstrong, Torseth, Skold & Rydeen, Inc 2020 CONSULTANTS

REVISIONS
REV NO DESCRIPTION DATE

SAFETY / SECURITY
ALTERATIONS
CITY OF NORTHFIELD
AND WASHINGTON STREET

SIGNATURE / SEAL

FOR REFERENCE ONLY

NOT FOR CONSTRUCTION

KEYPLAN

DRAWN BY

CHECKED BY

BJP ISSUED FOR

95% REVIEW SET

MAY 26, 2021
SHEET NAME


MECHANICAL DEMOLITION PLANS

ATS&R PROJECT NO. 20031.1

REVISION NO.

SHEET NUMBER

M1.1

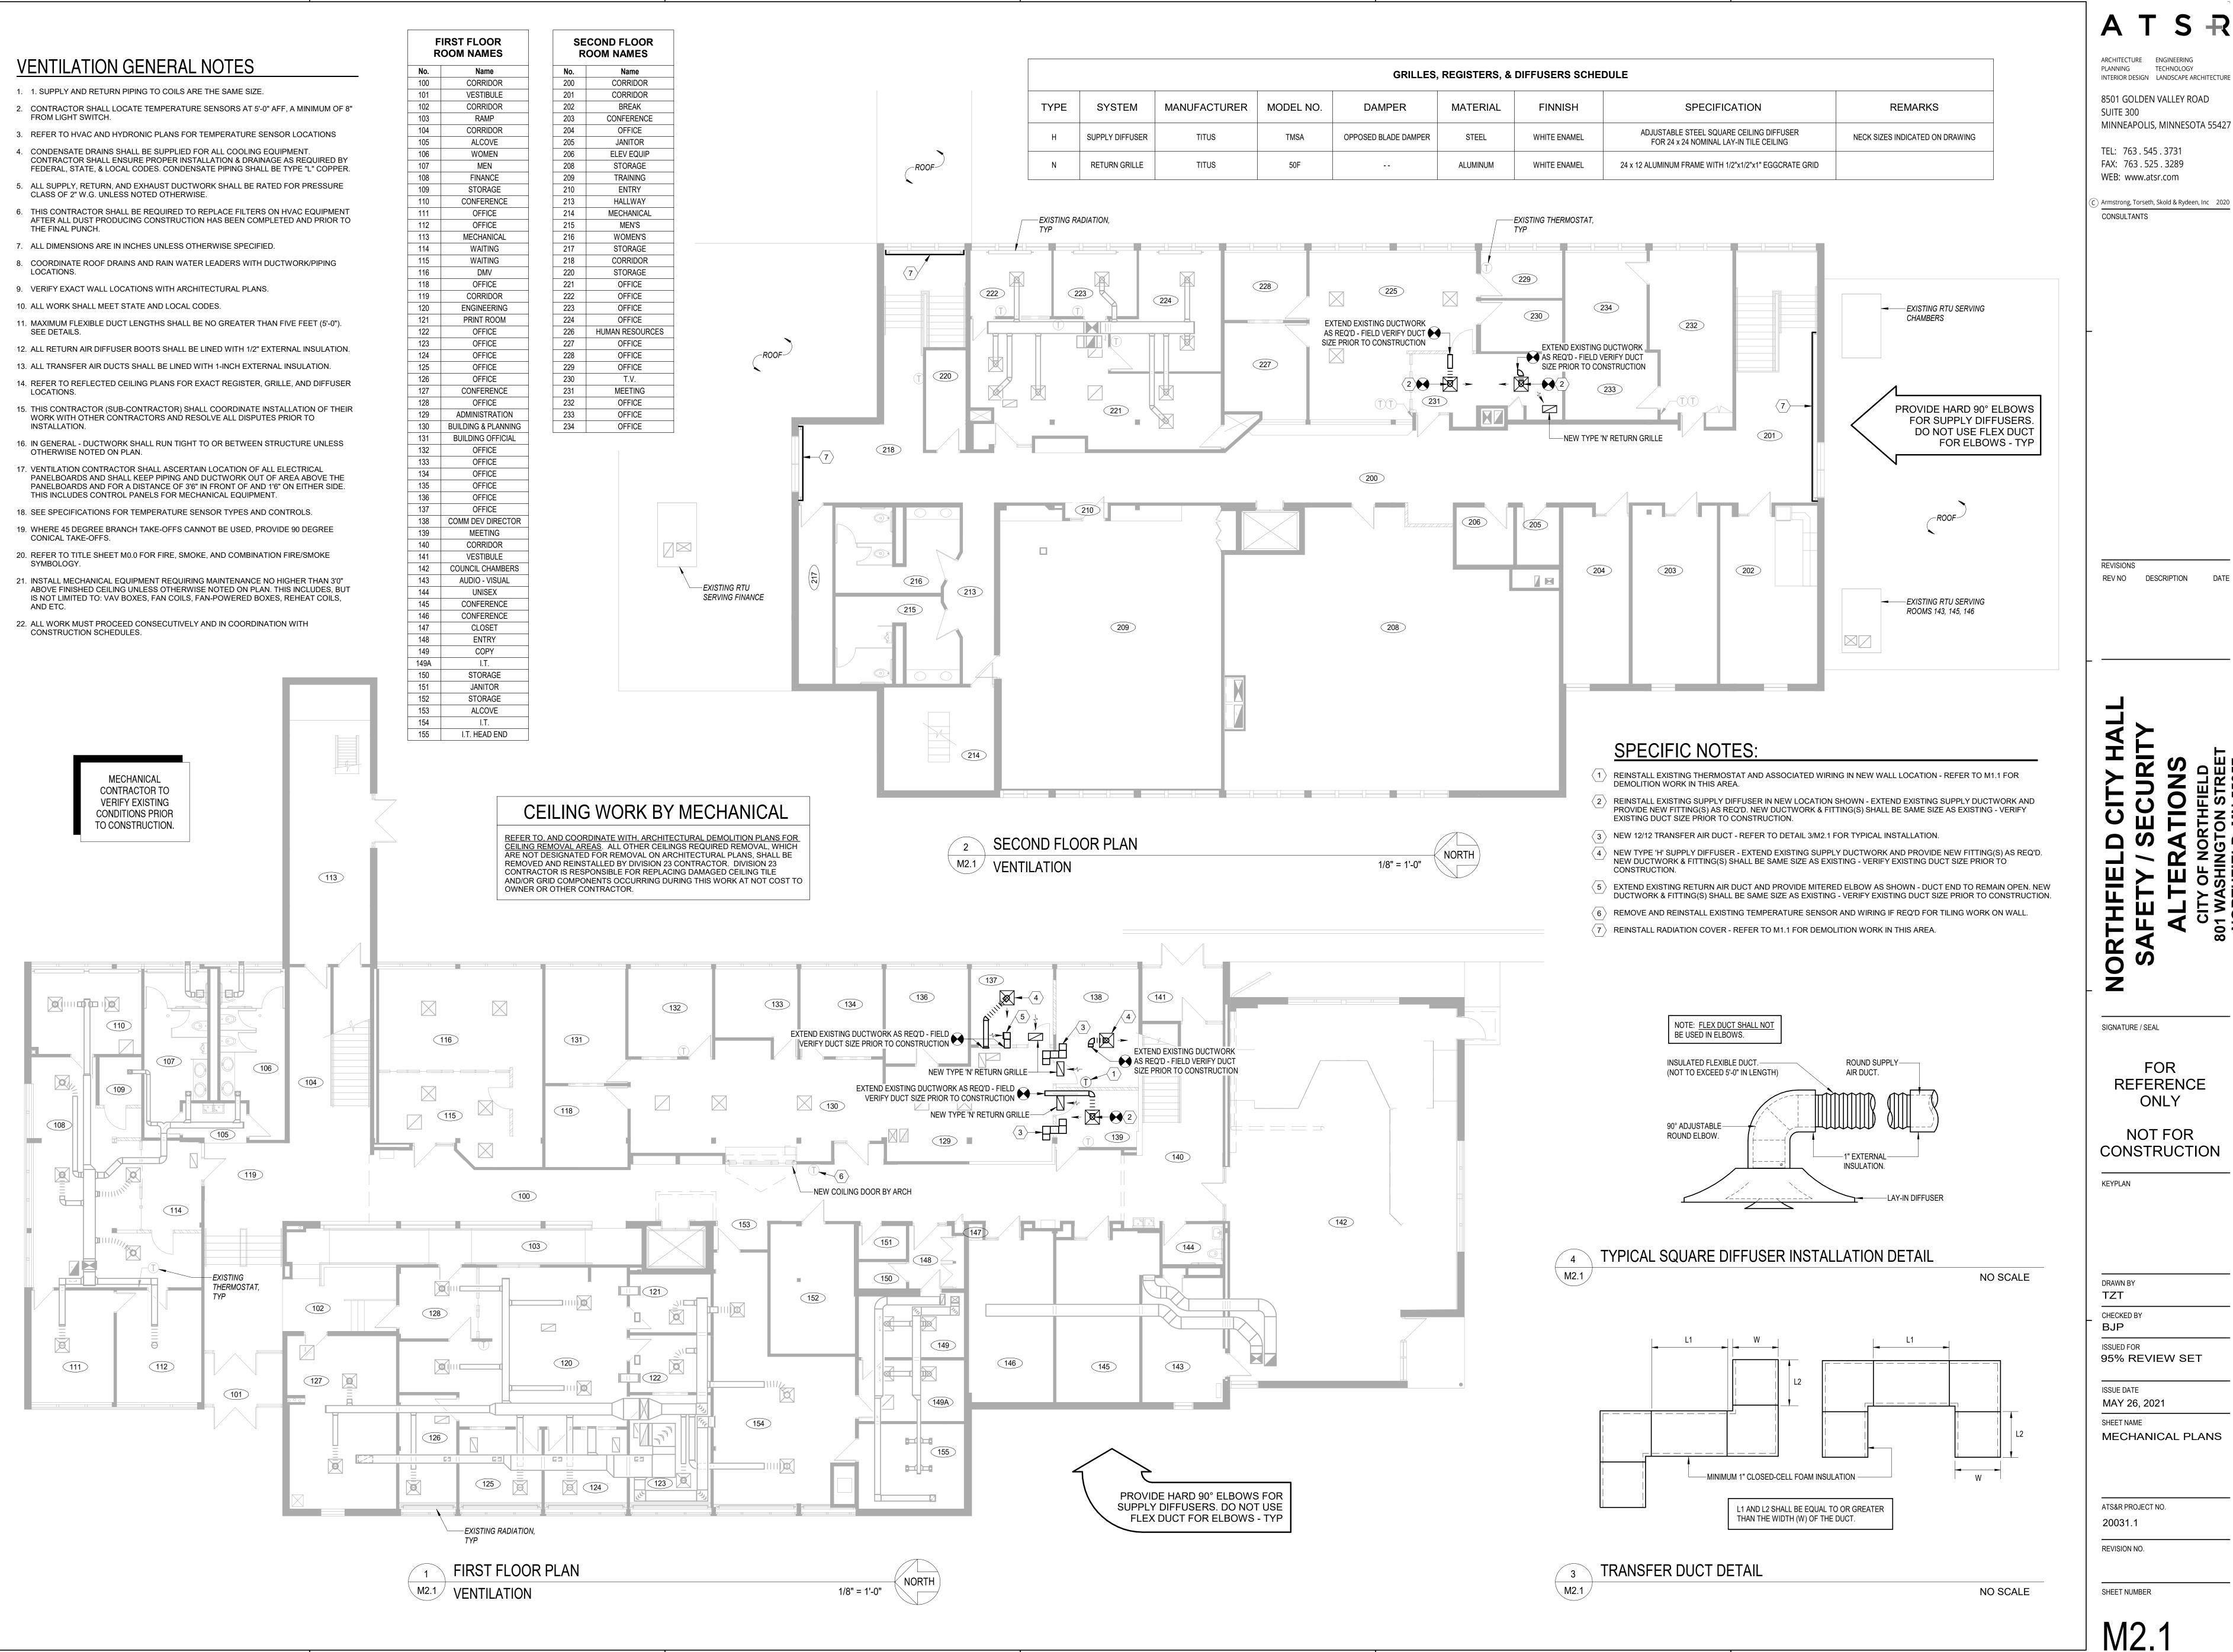

ARCHITECTURE ENGINEERING PLANNING TECHNOLOGY INTERIOR DESIGN LANDSCAPE ARCHITECTURE

8501 GOLDEN VALLEY ROAD SUITE 300

TEL: 763.545.3731 FAX: 763.525.3289

Armstrong, Torseth, Skold & Rydeen, Inc 2020

REVISIONS REV NO DESCRIPTION DATE

FOR REFERENCE ONLY

NOT FOR CONSTRUCTION

KEYPLAN

DRAWN BY TZT CHECKED BY

ISSUED FOR 95% REVIEW SET

ISSUE DATE MAY 26, 2021

SHEET NAME MECHANICAL PLANS

ATS&R PROJECT NO. 20031.1

REVISION NO.

Northfield City Hall Safety / Security Alterations City of Northfield

801 Washington Street Northfield, Minnesota 55057 Electrical

ELECTRICAL SYMBOLS

1. THESE SYMBOLS COMPRISE A STANDARD LIST, NOT ALL SYMBOLS MAY APPEAR ON THIS PROJECT.

3. UNLESS SPECIFICALLY NOTED OTHERWISE, ALL TECHNOLOGY BOXES SHALL BE 4" SQ DEEP WITH ONE GANG

MUD RING.

- 2. ALL MOUNTING HEIGHTS ARE TO CENTER OF DEVICE ABOVE FINISHED FLOOR, MOUNTING HEIGHTS SHOWN ARE TYPICAL, UNLESS NOTED OTHERWISE ON THE DRAWINGS OR IN THE SPECIFICATIONS.
- 4. ITEMS CALLED OUT ON SPECIFIC DETAILS TAKE PRECEDENCE OVER THIS SHEET.
 - 5. PROVIDE "RUGGED-USE" RECEPTACLES IN ALL BOILER ROOMS, MECHANICAL ROOMS, CORRIDORS AND MAINTENANCE AREAS.

SHEET INDEX

- EO.O ELECTRICAL TITLE SHEET & SYMBOLS SCHEDULE
- ED1.1 FIRST AND SECOND FLOOR ELECTRICAL DEMOLITION PLANS
- E1.1 FIRST AND SECOND FLOOR LIGHTING PLANS
- E2.1 FIRST AND SECOND FLOOR POWER PLANS
- E4.1 FIRST AND SECOND FLOOR SYSTEMS PLANS

SYMBOL	SYMBOL DESCRIPTION	MTG HT	SYMBOL	SYMBOL DESCRIPTION	MTG HT	SYMBOL	. SYMBOL DESCRIPTION	MTG HT	SYMBOL	SYMBOL DESCRIPTION	MTG HT	SYMBOL	SYMBOL DESCRIPTION	MTG HT
HOME	ME RUN - HASH MARKS INDICATE QUANTITY OF #12		\$ ²	DOUBLE POLE SWITCH	46"	0	DROP CORD OUTLET	-	Q	WALL MOUNTED LIGHT FIXTURE	SEE SPEC	Ē⊣	FIRE ALARM MANUAL STATION	46"
/ 4 7 1	IDUCTORS. LETTERS INDICATE PANEL NAME. IBERS INDICATE CIRCUIT NUMBERS.		\$ ³	THREE WAY SWITCH	46"	•	PUSH BUTTON	46"	0	SURFACE MOUNTED LIGHT FIXTURE			EXTERIOR FIRE ALARM HORN	
SURF	RFACE MOUNTED CONDUIT		\$ ⁴	FOUR WAY SWITCH	46"	H000	PUSH BUTTON STATION		0	RECESSED LIGHT FIXTURE		2	FIRE ALARM SMOKE DETECTOR	
CONE	IDUIT CONCEALED IN WALL OR CEILING		\$*	SINGLE POLE KEYED SWITCH	46"				×	CEILING MOUNTED EXIT LIGHT			FIRE ALARM DUCT SMOKE DETECTOR. PROVIDE REMOTE TEST STATION FOR EACH DETECTOR, SEE SECTION 28 31 10 OF	
CONE	IDUIT CONCEALED IN FLOOR.]	DIMMER	46"	TS	TIME SWITCH		>	WALL MOUNTED EXIT LIGHT	98"		THE SPECS.	
or CON[IDUIT UP			POWER OR DISTRIBUTION CABINET	SEE SPEC	©-I	WALL MOUNTED CLOCK	98"		EMERGENCY LIGHT - WALL PACK	98"		MAGNETIC DOOR HOLDER	
~ CON[IDUIT DOWN			POWER OR LIGHTING PANEL BOARD	322 31 20	€	PHOTOCELL	-	 \$	SINGLE POLE SWITCH	46"		FIRE ALARM BELL/STROBE	
SURF	RFACE RACEWAY	SEE DWG		METER SOCKET	SEE SPEC	© -1	TIME CLOCK	-	⊕ GFI	DUPLEX GFI RECEPTACLE	18"	\$	FIRE/SMOKE DAMPER	
VERT VERT	TICAL SURFACE METAL RACEWAY	SEE DWG	#	MOTOR - NUMBER REFERS TO MOTOR SCHEDULE	SEE MTR	/□+	BUZZER	SEE DWG	Φ	RANGE RECEPTACLE	18"	<u> </u>	SMOKE DAMPER	
P POWE	VER POLE			DISCONNECT SWITCH	SCHEDULE SEE SPEC	SSF	SOUND FIELD SPEAKER	SEE DWG	····	SPECIAL PURPOSE RECEPTACLE (SEE DWG FOR TYPE)	18"	M	MOTION SENSOR	
1X4	FLUORESCENT LIGHT FIXTURE			MOTOR STARTER	SEE SPEC	Э	FIRE ALARM HEAT DETECTOR			, , , , , , , , , , , , , , , , , , , ,				
2X4	FLUORESCENT LIGHT FIXTURE			COMBINATION STARTER/DISCONNECT	SEE SPEC	DD+	FIRE ALARM SPEAKER/STROBE	82"	⊕ ⊙	FLOOR BOX WITH DUPLEX RECEPTACLE				
2X2	FLUORESCENT LIGHT FIXTURE		R	RELAY	SEE DWG	▶□⊣	FIRE ALARM STROBE	82"	<u>•</u>	FLOOR BOX OR POKE-THOURGH AS NOTED				
→ OUTC	DOOR STANDARD			SINGLE RECEPTACLE	18"	⊳ ©	CEILING MOUNTED FIRE ALARM SPEAKER/STROBE		(J)	JUNCTION BOX				
──────────────────────────────	ERIOR WALL MOUNTED LIGHT FIXTURE		ا 	DUPLEX RECEPTACLE (SEE NOTE #5)	18"	►C	CEILING MOUNTED FIRE ALARM STROBE	-						

ATSR

INTERIOR DESIGN LANDSCAPE ARCHITECTURE 8501 GOLDEN VALLEY ROAD

MINNEAPOLIS, MINNESOTA 55427 TEL: 763.545.3731 FAX: 763.525.3289

WEB: www.atsr.com

Armstrong, Torseth, Skold & Rydeen, Inc 2021 CONSULTANTS

REVISIONS

KEYPLAN

95% REVIEW SET


MAY 26, 2021

SHEET NAME

ELECTRICAL TITLE SHEET & SYMBOLS SCHEDULE

ATS&R PROJECT NO. 20031.1

REVISION NO.

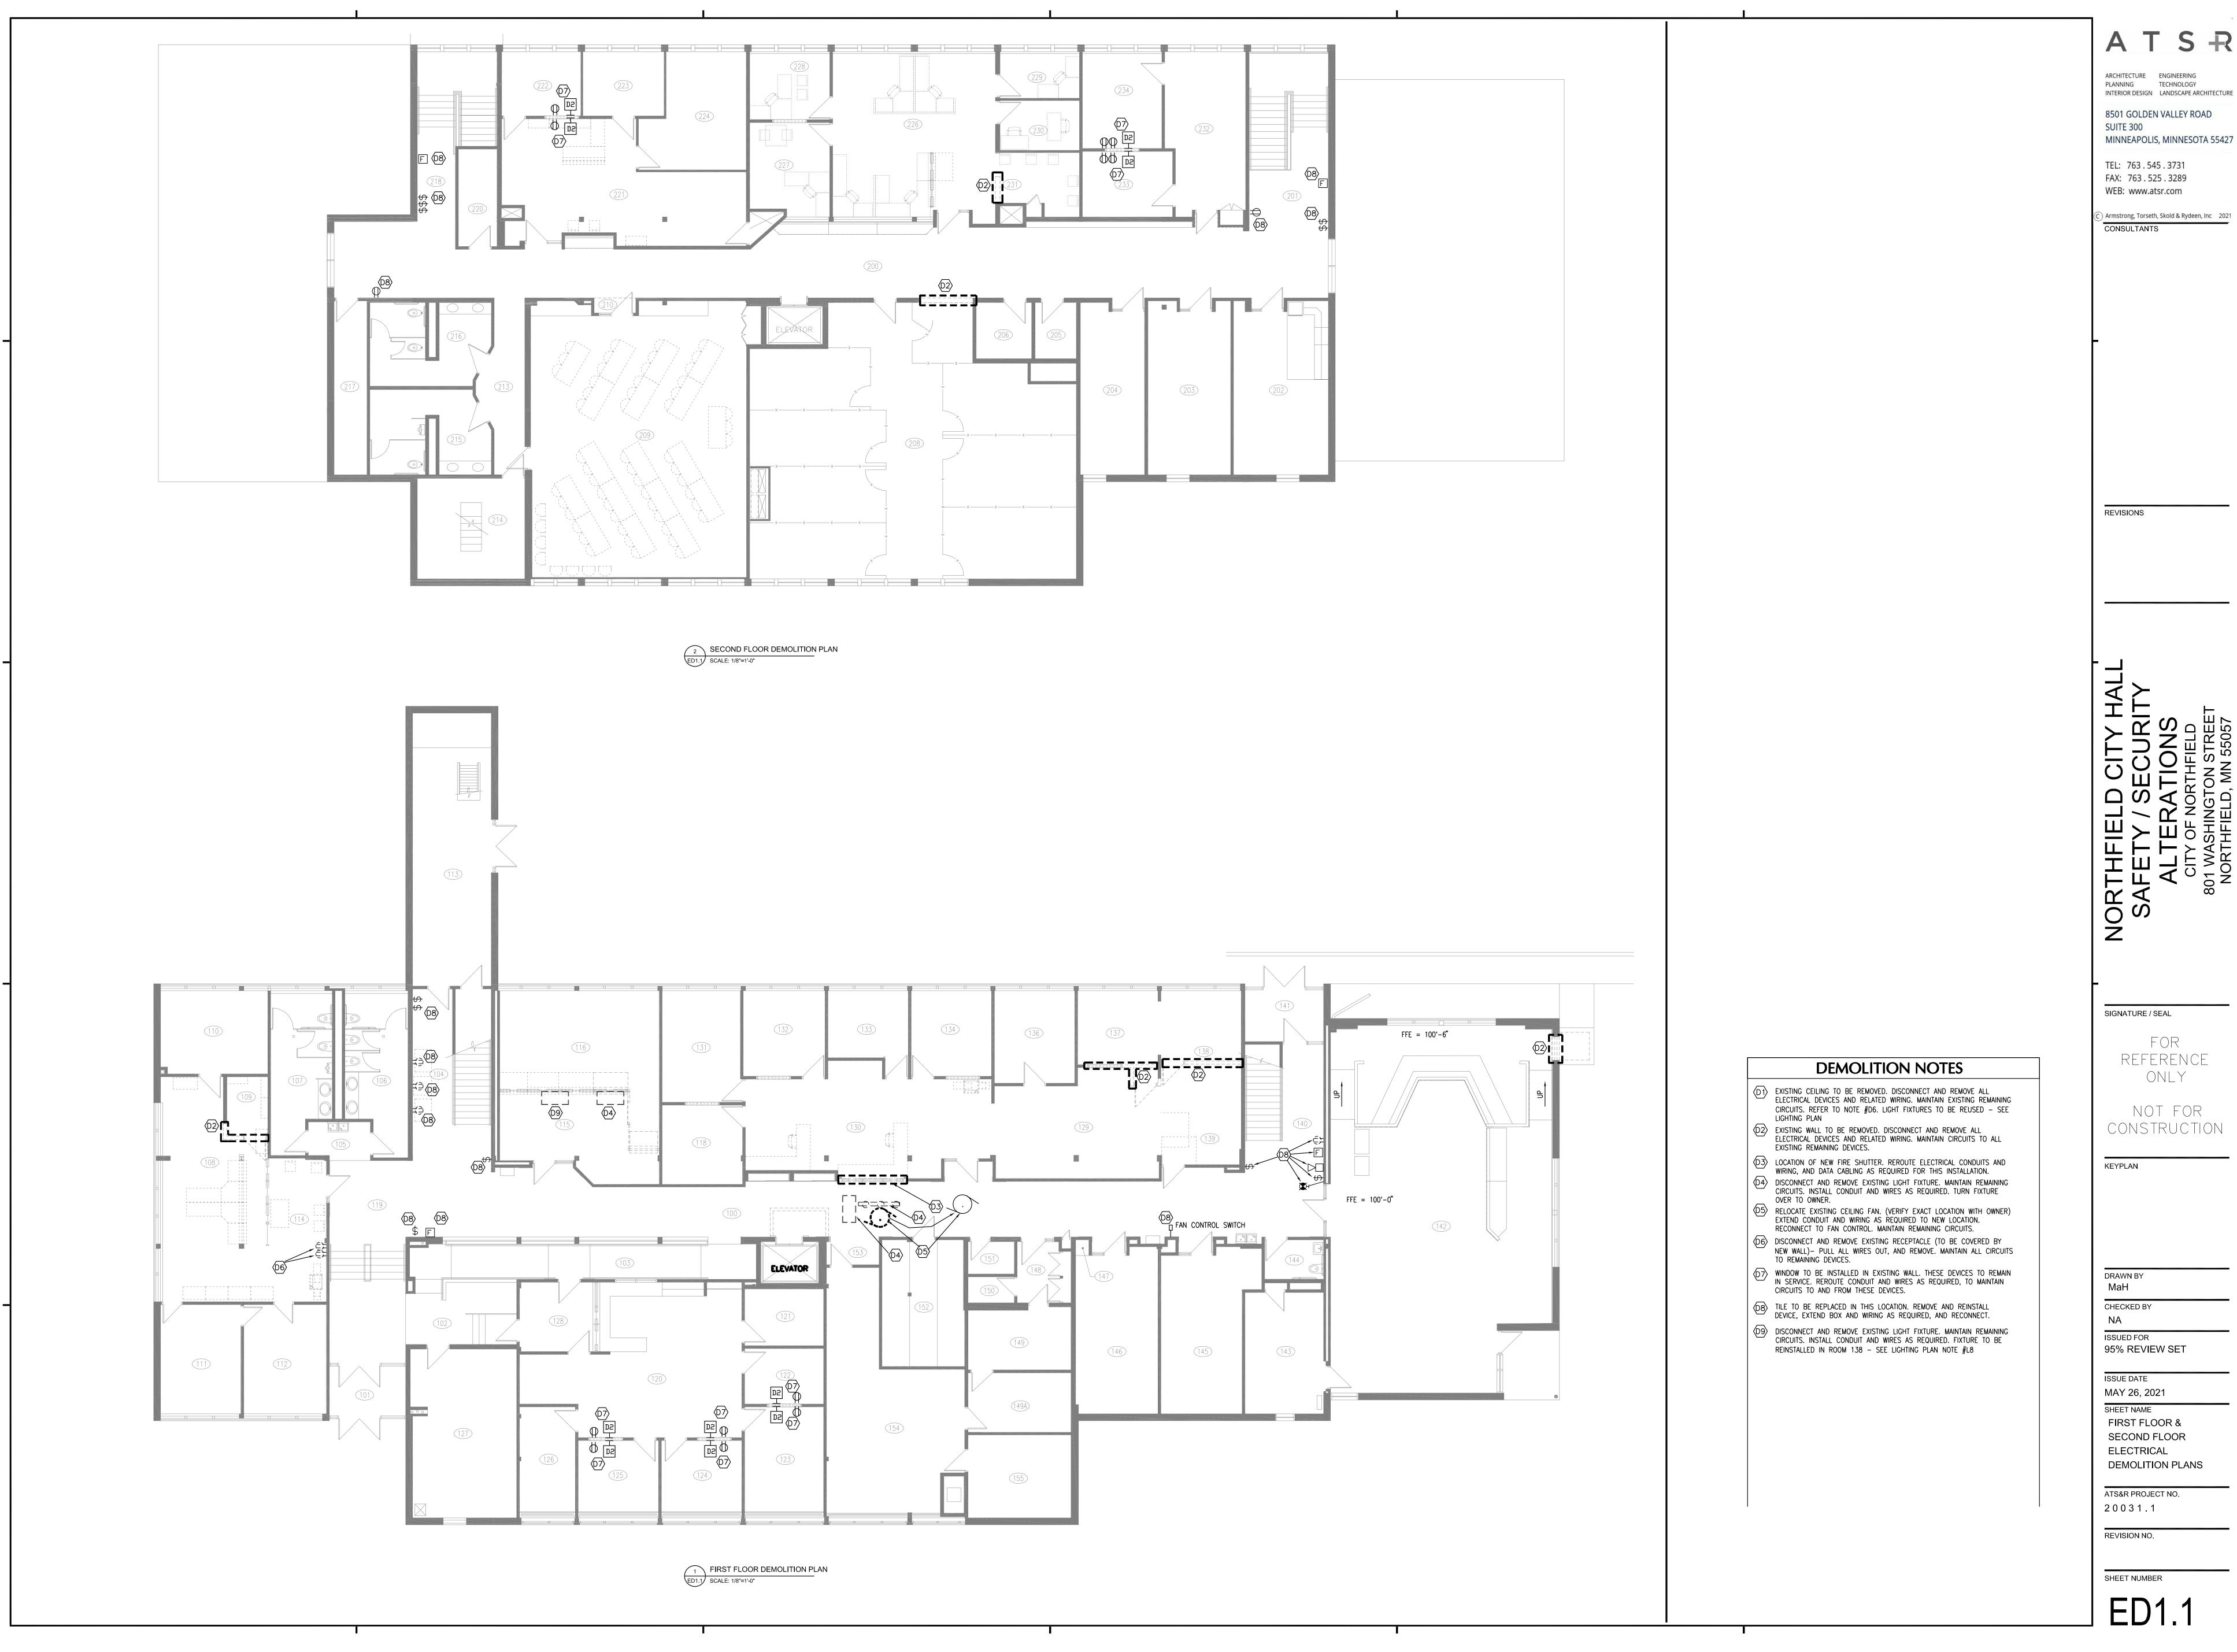

ARCHITECTURE ENGINEERING INTERIOR DESIGN LANDSCAPE ARCHITECTURE 8501 GOLDEN VALLEY ROAD SUITE 300

TEL: 763.545.3731 FAX: 763.525.3289 WEB: www.atsr.com

Armstrong, Torseth, Skold & Rydeen, Inc 2021 CONSULTANTS

REVISIONS

SIGNATURE / SEAL

ONLY

NOT FOR CONSTRUCTION

KEYPLAN

DRAWN BY


MaH CHECKED BY NA


ISSUED FOR 95% REVIEW SET

MAY 26, 2021 SHEET NAME FIRST FLOOR & SECOND FLOOR ELECTRICAL

ATS&R PROJECT NO. 20031.1

REVISION NO.

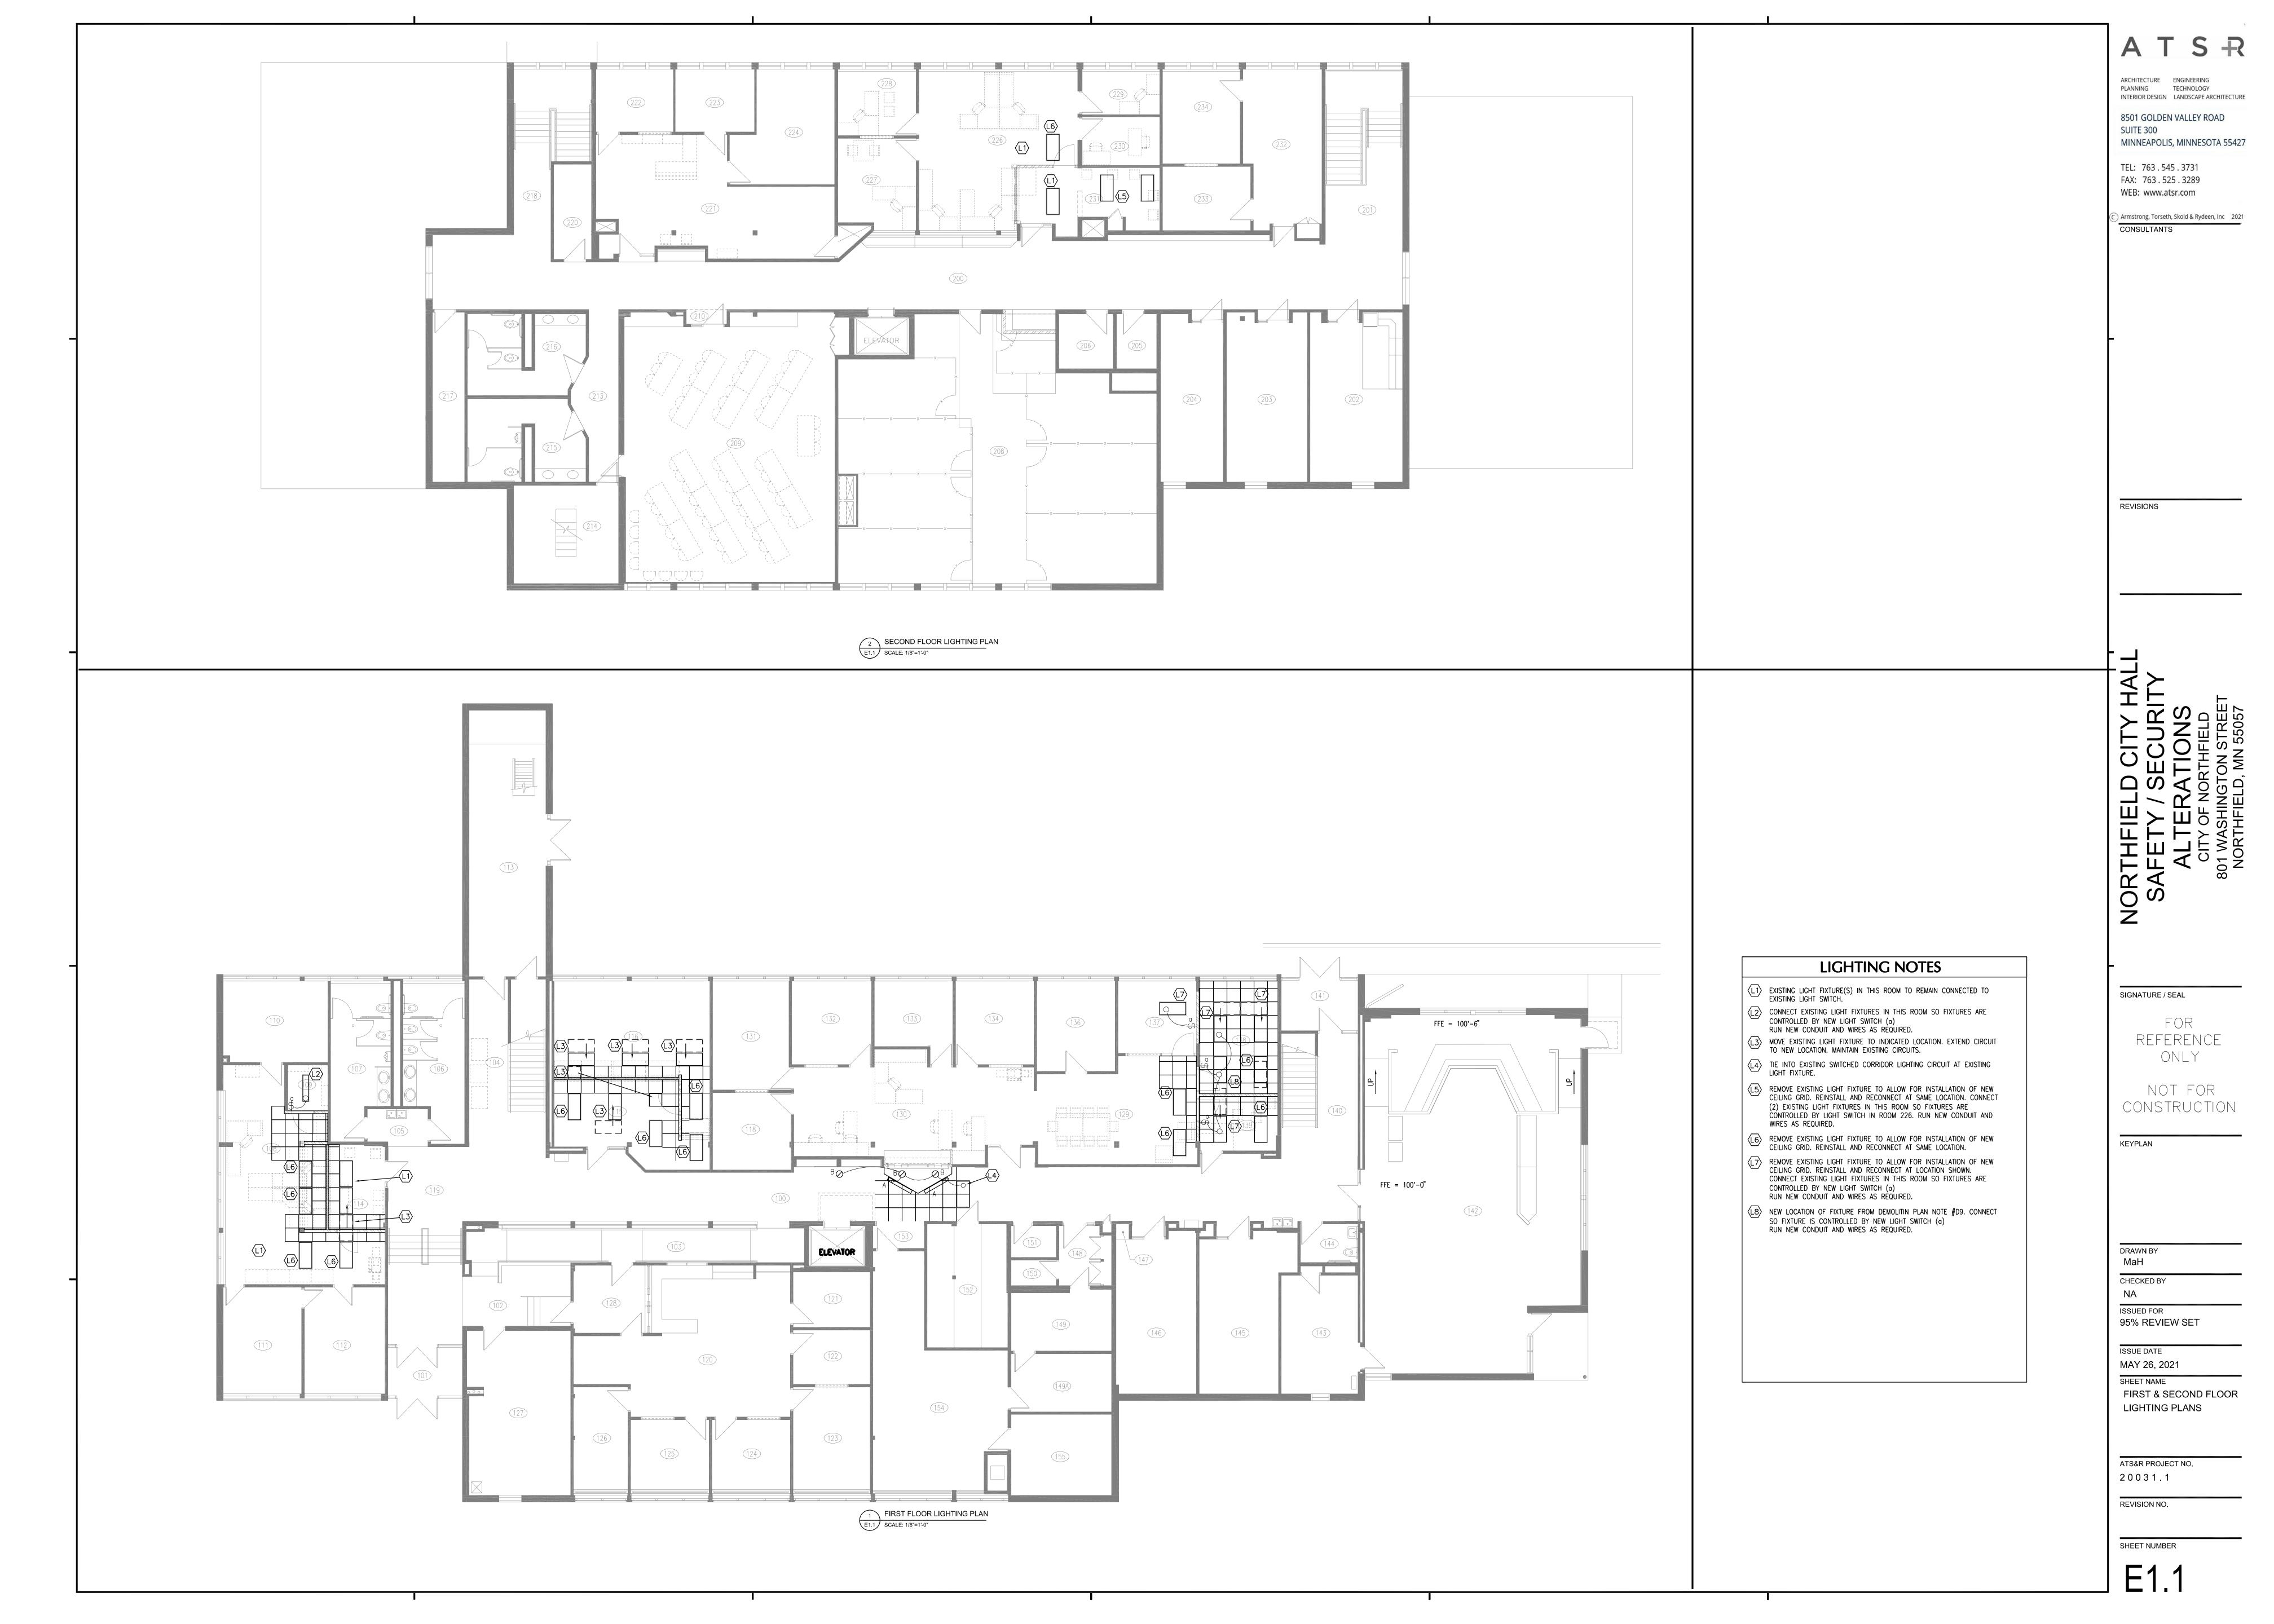

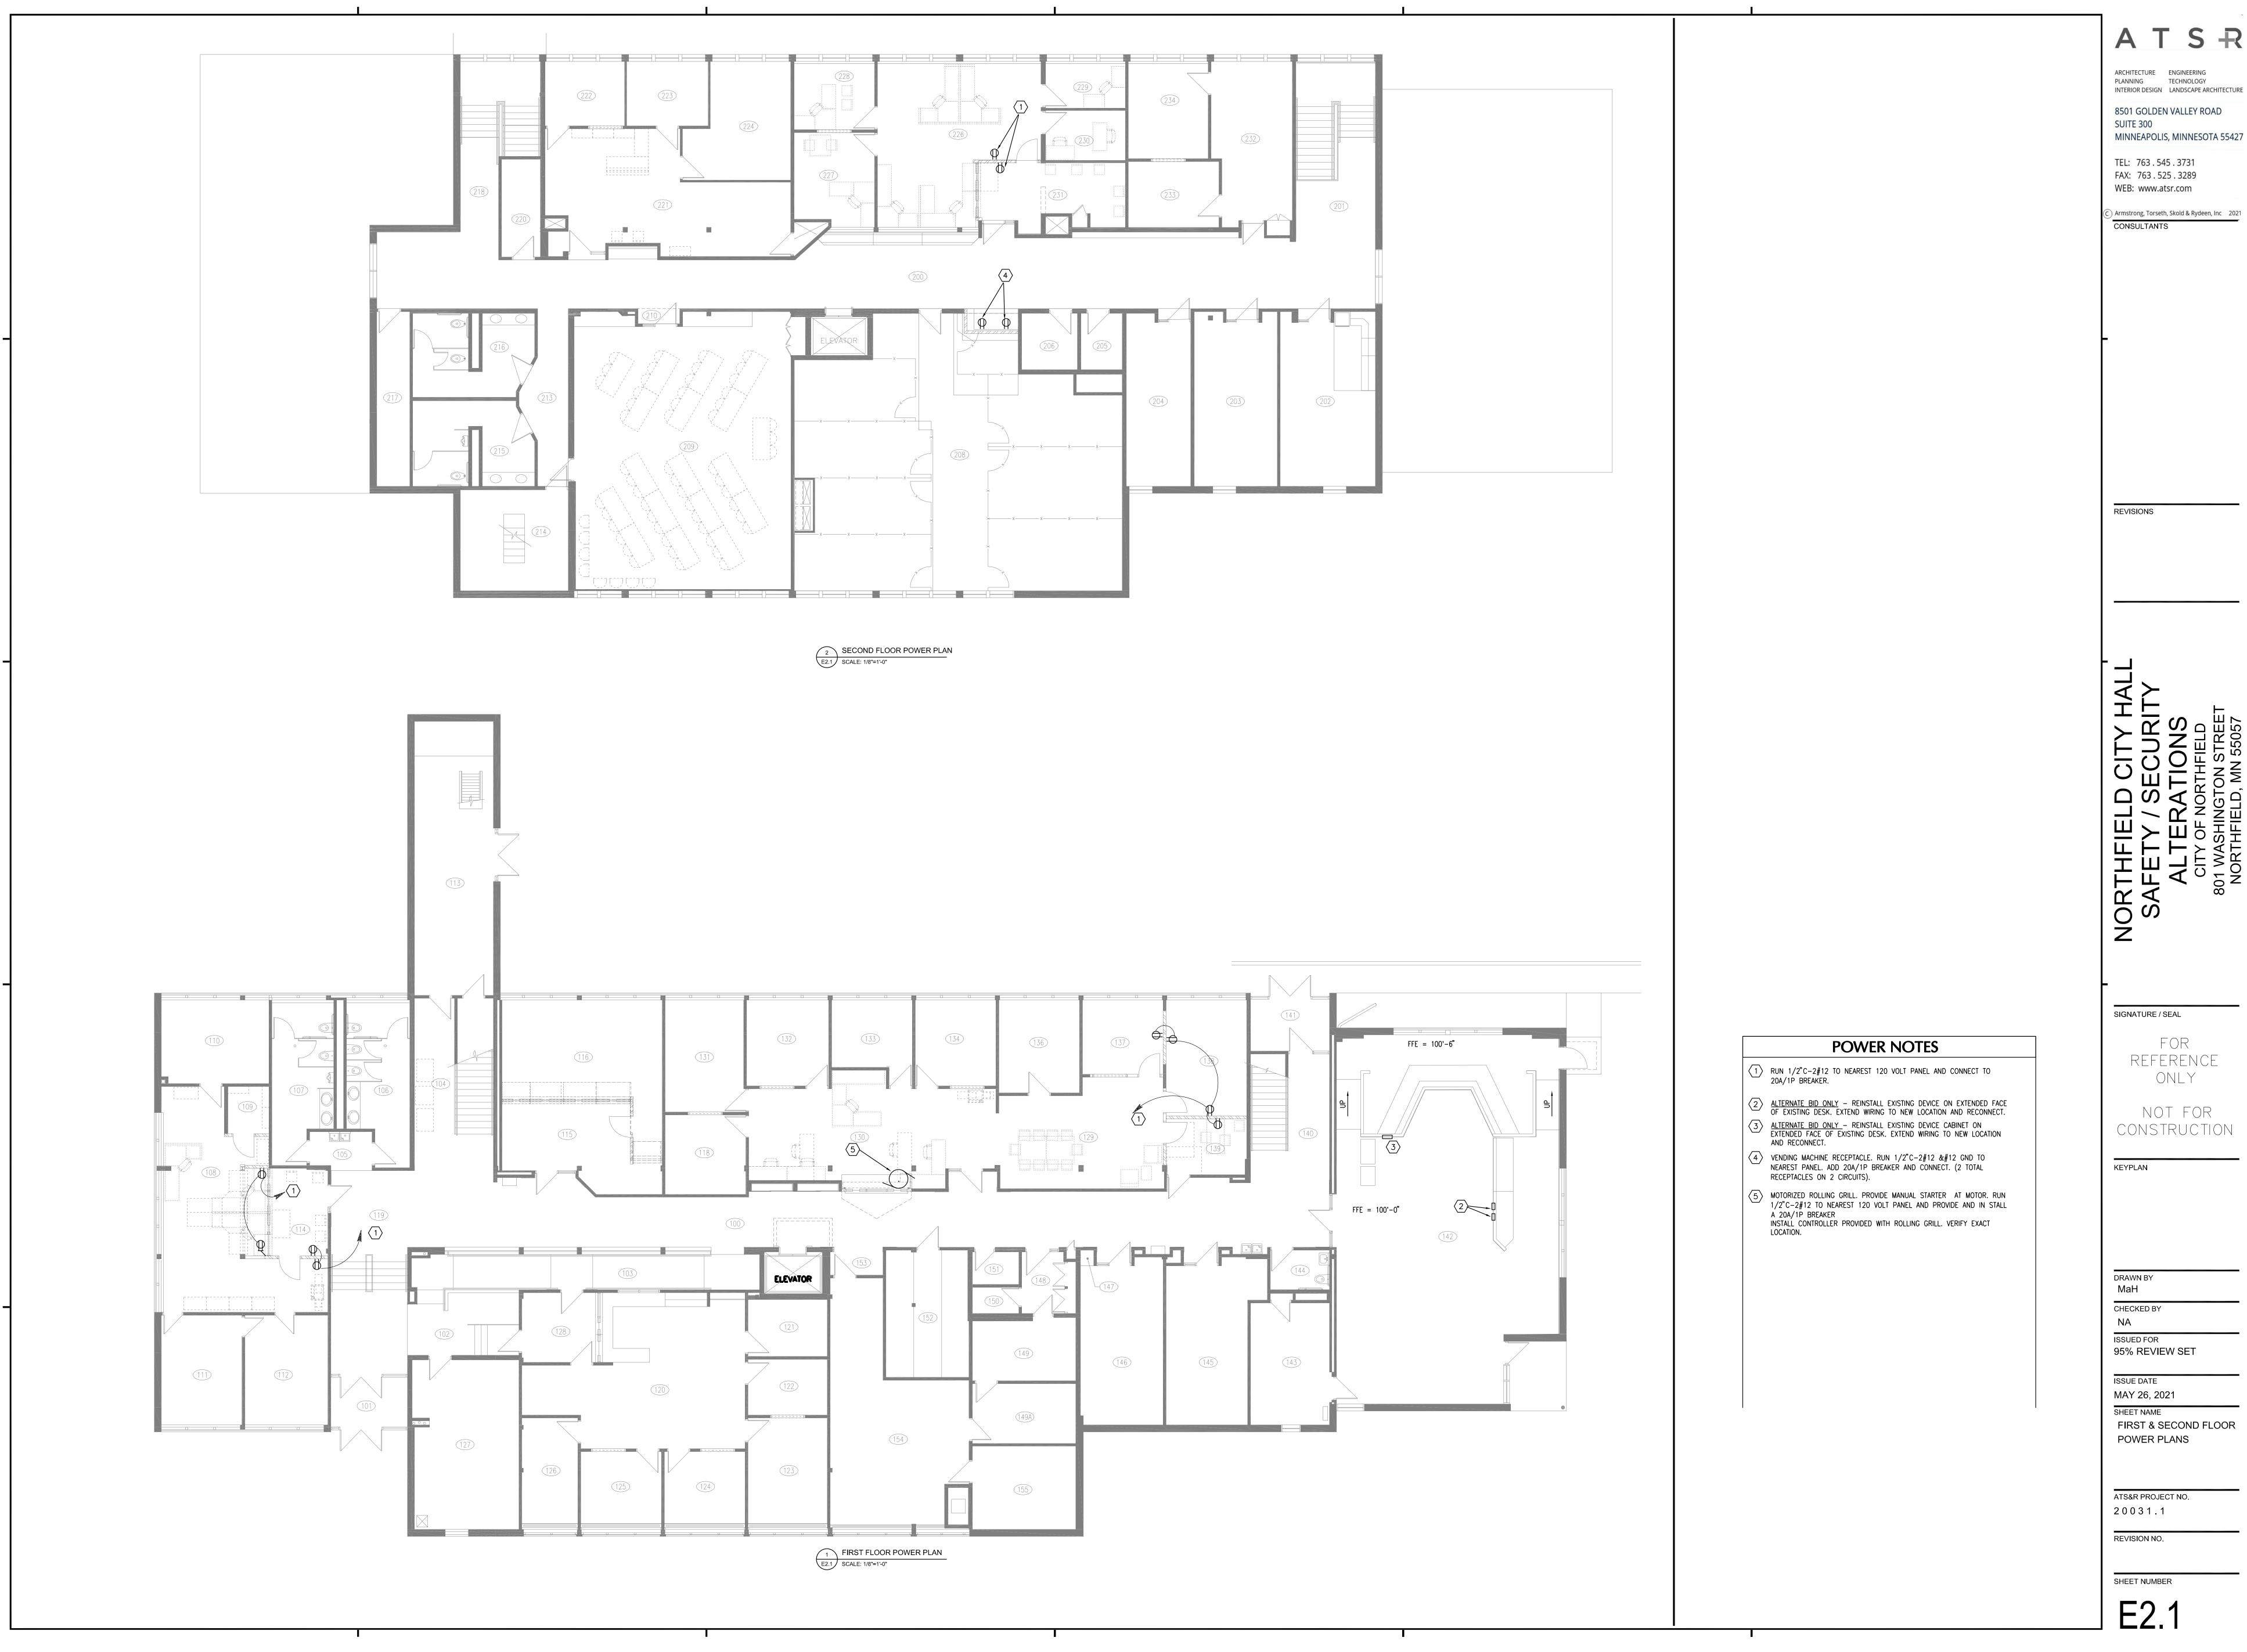

PLANNING TECHNOLOGY INTERIOR DESIGN LANDSCAPE ARCHITECTURE 8501 GOLDEN VALLEY ROAD SUITE 300

TEL: 763.545.3731 FAX: 763.525.3289 WEB: www.atsr.com

Armstrong, Torseth, Skold & Rydeen, Inc 2021 CONSULTANTS

SIGNATURE / SEAL

FOR ONLY

NOT FOR CONSTRUCTION

DRAWN BY

CHECKED BY NA

ISSUED FOR

95% REVIEW SET

MAY 26, 2021 SHEET NAME FIRST & SECOND FLOOR

ATS&R PROJECT NO.

REVISION NO.



SECURITY AND FIRE ALARM SYSTEMS SYMBOLS SCHEDULE

NOTES TO AUDIO VIDEO SYMBOLS SCHEDULE:

1. ALL MOUNTING HEIGHTS ARE TO CENTER OF DEVICE ABOVE FINISHED FLOOR (A.F.F.). MOUNTING HEIGHTS SHOWN ARE TYPICAL AND ARE TO BE OBSERVED UNLESS NOTED OTHERWISE ON THE FLOOR PLANS. MOUNTING HEIGHT ON FLOOR PLANS HAVE PRIORITY.

ALL CABLE SHALL BE PLENUM RATED UNLESS OTHERWISE NOTED.

SYMBOL	DESCRIPTION	MOUNTING HEIGHT OR AS NOTED
(CR)	SECURITY CARD READER. SURFACE WALL MOUNTED.	34"
ES	ELECTRIC STRIKE DOOR LOCKING HARDWARE. PROVIDED BY DIVISION 8. 24 VOLT POWER, WIRED AND CONTROLLED BY DIVISION 28 SECURITY CONTRACTOR.	DOOR FRAME
ML	MAGNETIC LOCK DOOR LOCKING HARDWARE. PROVIDED BY DIVISION 8. 24 VOLT POWER, WIRED AND CONTROLLED BY DIVISION 28 SECURITY CONTRACTOR.	DOOR FRAME
(DC)	FLUSH MAGNETIC DOOR POSITION CONTACT SET. PROVIDED BY DIVISION 28.	DOOR FRAME
•	DOOR RELEASE PUSHBUTTON (MOMENTARY CONTACT). MOUNTED ON SYSTEMS FURNITURE. FIELD VERIFY EXACT LOCATION WITH OWNER. SWITCH MOMENTARILY UNLOCKS DOOR BETWEEN STAFF SIDE AND PUBLIC SIDE OF DEPARTMENT.	ON SYSTEMS FURNITURE
P	LOCKDOWN PUSHBUTTON (MAINTAINED CONTACT). WALL MOUNTED. FIELD VERIFY EXACT LOCATION WITH OWNER.	ON SYSTEMS FURNITURE
∇	AUDIO VIDEO DOOR INTERCOM MASTER STATION. MOUNTED ON SYSTEMS FURNITURE.	ON SYSTEMS FURNITURE
∇^{M}	AUDIO VIDEO DOOR INTERCOM DOOR STATION. FLUSH WALL MOUNTED.	54"
s	SMOKE DETECTOR. TIE INTO EXISTING FIRE ALARM SYSTEM. PROVIDE PROGRAMMING AS REQUIRED.	CEILING

CEILING WORK NOTE

REFER TO, AND COORDINATE WITH, ARCHITECTURAL DEMOLITION PLANS FOR CEILING REMOVAL AREAS. ALL OTHER CEILINGS REQUIRING REMOVAL, WHICH ARE NOT DESIGNATED FOR REMOVAL ON ARCHITECTURAL PLANS, SHALL BE REMOVED AND REINSTALLED BY DIVISIONS 27 AND 28 CONTRACTORS AS THEIR WORK REQUIRES. DIVISIONS 27 AND 28 CONTRACTORS ARE RESPONSIBLE FOR REPLACING DAMAGED CEILING TILES AND/OR GRID COMPONENTS DAMAGED DURING THEIR WORK AT NO COST TO OWNER OR OTHER CONTRACTOR.

GENERAL NOTES

- A. FIELD VERIFY EXACT LOCATION OF DOOR RELEASE
 PUSHBUTTON AND LOCKDOWN PUSHBUTTON WITH OWNER.
- B. EACH LOCKDOWN PUSHBUTTON SHALL BE IDENTIFIED SPECIFICALLY BY LOCATION BY THE SECURITY SYSTEM.
- C. NEW SECURITY DEVICES AND DATA OUTLETS INSTALLED ON EXISTING GYPSUM BOARD WALLS SHALL BE FLUSH MOUNTED AND THE CABLE SHALL BE INSTALLED CONCEALED IN THE WALL. NO SURFACE RACEWAY SHALL BE USED ON EXISTING GYPSUM BOARD WALLS.
- D. THE ELECTRICAL CONTRACTOR SHALL DISCONNECT ELECTRICAL AND DATA AT SYSTEMS FURNITURE WHEN IT IS REMOVED BY THE OWNER'S SYSTEMS FURNITURE CONTRACTOR AND CONNECT POWER AND DATA TO NEW SYSTEMS FURNITURE.
- . INSTALL CARD READERS WHERE SHOWN TO PREVENT CONFLICT WITH TILING IN CORRIDORS.

SPECIFIC SYSTEMS NOTES

- S1 EXISTING CARD READER CONTROLLED DOOR. SHOWN FOR REFERENCE ONLY. MIGRATE CARD READER TO NEW CONTROLLER SYSTEM.
- DOOR RELEASE FUNCTION BUILT INTO DOOR INTERCOM MASTER STATION. PROVIDE DOOR INTERCOM SOFTWARE
 - ON ASSOCIATED OWNER'S COMPUTER.
 - FIELD VERIFY EXACT LOCATION OF LOCKDOWN PUSHBUTTON WITH OWNER.

 (S4) PROVIDE NEW FLUSH MOUNTED DOOR POSITION SWITCH
 - SECURITY SYSTEM.

ON NEW EXTERIOR DOOR. CONNECT TO CARD ACCESS

- THIS IS A DATA CLOSET WITH A CABINET DOOR. PROVIDE CARD READER WITH MAGNETIC LOCK TO SECURE DOOR.
- PROVIDE NEW SECURITY CONTROL PANELS. FIELD VERIFY EXACT LOCATION WITH OWNER.
- REMOVE AND REINSTALL EXISTING D4 DATA OUTLETS FROM EXISTING COLUMN INTO NEW WALL. REUSE EXISTING DATA CABLING.
- THE EXISTING VOICE AND DATA CABLING FROM THIS OFFICE AREA ARE ROUTED THROUGH TWO CONDUIT SLEEVES DIRECTLY ABOVE WHERE THE NEW ROLLING SHUTTER IS BEING INSTALLED. THE DIVISION 27 CONTRACTOR SHALL REROUTE THESE CABLES AS REQUIRED TO GET THEM OUT OF THE WAY OF THE NEW SHUTTER. THIS WILL REQUIRE REMOVING THE CBALE FROM THE EXISTING OUTLETS AND PULLING THEM BEACK TO THE CORRIDOR, PROVIDING NEW CONDUIT SLEEVES AND REINSTALLING THE CABLES TO THE OUTLETS. PROVIDE NEW CONDUIT SLEEVES AS REQUIRED. ALL PENETRATIONS OF THE CORRIDOR WALL SHALL BE FIRE STOPPED.

SPECIFIC FIRE ALARM NOTES

PROGRAMMING AS REQUIRED.

F1 MAKE CONNECTIONS AS REQUIRED TO FIRE ALARM SHUTTER. PROVIDE 120 VOLT CIRCUIT FROM NEAREST PANEL AND CONNECT. PROVIDE ADDRESSIBLE FIRE ALARM CONTROL MODULE AND MAKE CONNECTIONS AS REQUIRED TO FIRE ALARM SYSTEM. PROVIDE

ATSR

ARCHITECTURE ENGINEERING
PLANNING TECHNOLOGY
INTERIOR DESIGN LANDSCAPE ARCHITECTURE

8501 GOLDEN VALLEY ROAD SUITE 300 MINNEAPOLIS, MINNESOTA 55427

TEL: 763.545.3731 FAX: 763.525.3289 WEB: www.atsr.com

C Armstrong, Torseth, Skold & Rydeen, Inc 2021
CONSULTANTS

REVISIONS

SAFETY / SECURITY

ALTERATIONS

CITY OF NORTHFIELD

S01 WASHINGTON STREET

SIGNATURE / SEAL

FOR REFERENCE ONLY

NOT FOR

KEYPLAN

DRAWN BY

DB CHECKED BY

N ACHINA

ISSUED FOR 95% REVIEW SET

ISSUE DATE

MAY 26, 2021
SHEET NAME

ATS&R PROJECT NO.

TECHNOLOGY FLOOR PLAN AND DETAILS

20031.1

REVISION NO.