


SINGLE AXIS TRACKER EAST-WEST ELEVATION NTS

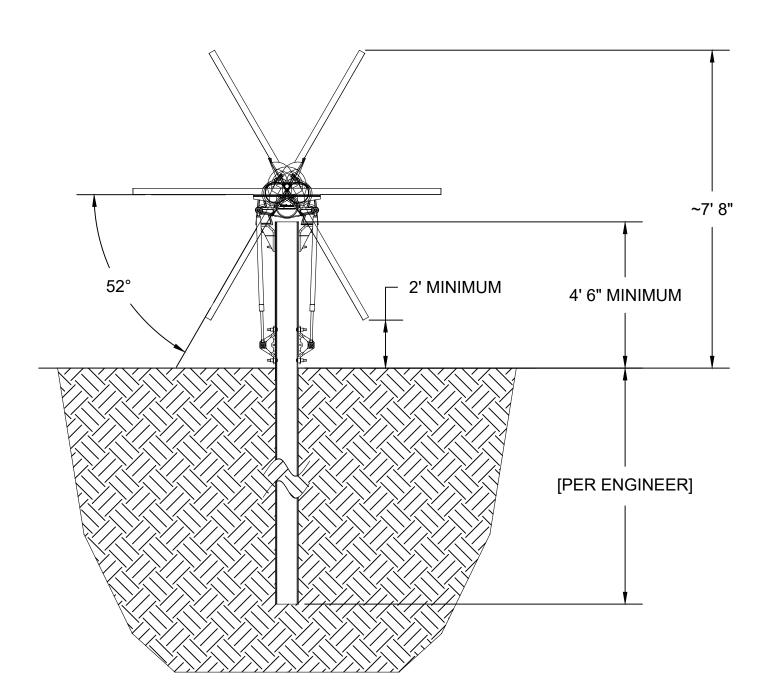

3 SINGLE AXIS TRACKER NORTH-SOUTH ELEVATION NTS



NEW ENERGY EQUITY, LLC 2530 RIVA ROAD, SUITE 200 ANNAPOLIS, MD 21041 NEWENERGYEQUITY.COM 443-267-5012

PROJECT ADDRESS 3869-3999 MN-19 NORTHFIELD, MN 55057

LAT: 44.4737619461 LONG: -93.2188576538

SYSTEM SPECIFICATIONS			
SYSTEM SIZE DC	1.454 MW		
SYSTEM SIZE AC	1.000 MW		
DC/AC RATIO	1.454		
AZIMUTH	180°		
TILT	+/- 52°		
MODULE COUNT	3825		
MODULE TYPE	REC 380TP2SM 72		
MODULE STC RATING	380 W		
INVERTER COUNT	8		
INVERTER TYPE	CPS SCA125KTL-DO/US		
INVERTER POWER	125kW		
RACKING	TBD		
MONITORING	ALSO ENERGY		

DESIGN CRITERIA		
MIN/MAX TEMP.	-29°C / 31°C	
WIND SPEED (ASCE 7-10)	105 MPH	
BUILDING CATEGORY	I	
EXPOSURE CATEGORY	С	
GROUND SNOW LOAD	50 PSF	
BUILDING HEIGHT	0'-0"	

OTHER NOTES

CASE NUMBER 04124406

NO POSITION, DISTANCE, OR CLEARANCE ISSUES WITH OVERHEAD ELECTRIC SERVICE LINES OR OTHER UTILITIES IN RELATION TO THE PV PANELS.

24/7 UNESCORTED KEYLESS ACCESS PROVIDED TO ALL XCEL ENERGY EQUIPMENT INCLUDING THE METERS AND AC DISCONNECT.

INTERCONNECTION TYPE: SECONDARY

PROJECT OWNER: MN CSG 2019-77 LLC

	REVISIONS		
#	DESCRIPTION	BY	DATE
0	ORIGINAL DESIGN	SPC	10/14/2020
1	SITE PLAN	MPH	10/20/2020
2	UPDATE WITH XCEL COMMENTS	MPH	11/4/2020
3	CUP PACKAGE	JAT	1/18/2021
4			
5			
6			
7			

DRAWN BY

JOSE TAVARES

PROJECT NAME

DEVNEY CSG


SAT RACKING DETAIL

NTS




SHEE

PV2

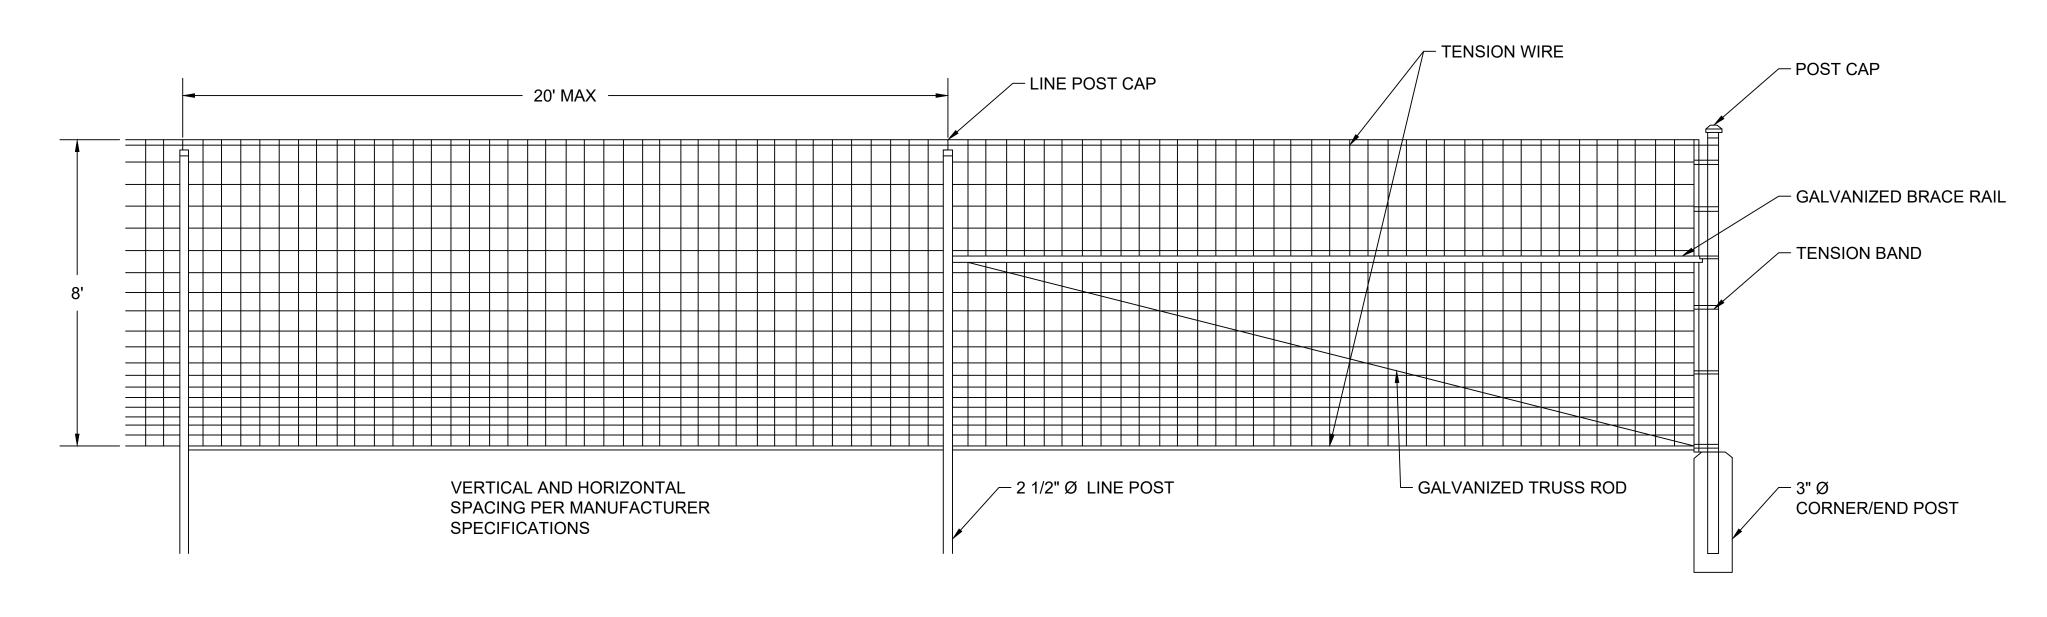

8' FIXED KNOT FENCE NTS

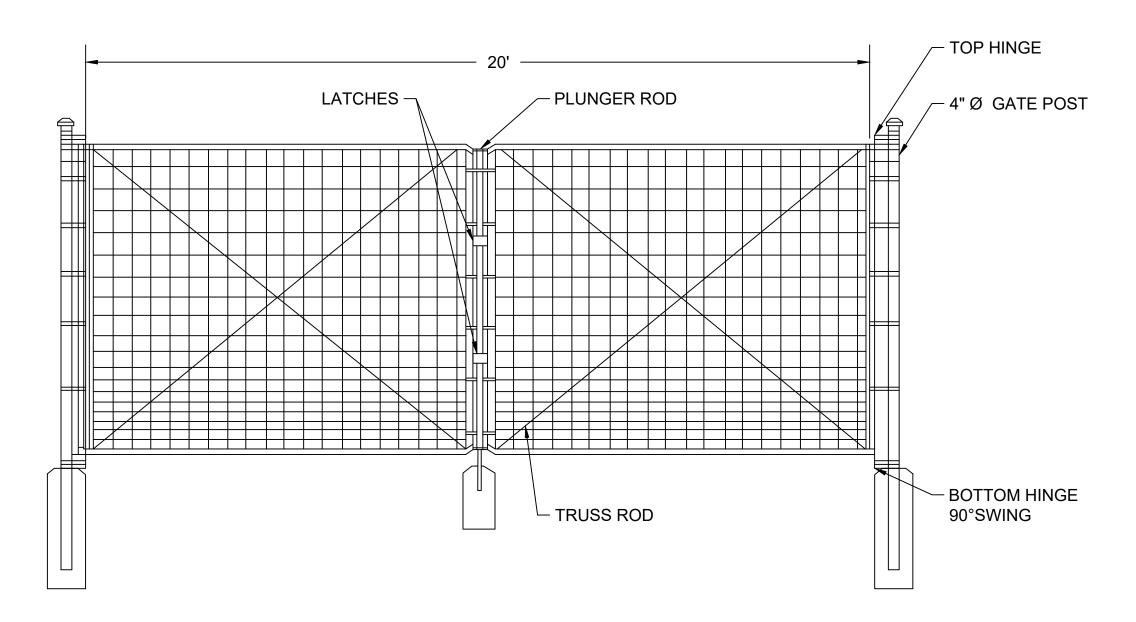

8' FIXED KNOT FENCE GATE NTS

- 1. THIS DRAWING IS FOR INFORMATIONAL PURPOSES ONLY
- AND NOT TO BE USED FOR CONTRUCTION.
- 2. DO NOT SCALE DRAWING



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3869-3999 MN-19 NORTHFIELD, MN 55057

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MODULE STC RATING	380 W			
INVERTER COUNT	8			
INVERTER TYPE	CPS SCA125KTL-DO/US			
INVERTER POWER	125kW			
RACKING	TBD			
MONITORING	ALSO ENERGY			

DESIGN CRITERIA		
MIN/MAX TEMP.	-29°C / 31°C	
WIND SPEED (ASCE 7-10)	105 MPH	
BUILDING CATEGORY	1	
EXPOSURE CATEGORY	С	
GROUND SNOW LOAD	50 PSF	
BUILDING HEIGHT	0'-0"	

OTHER NOTES

CASE NUMBER 04124406

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DRAWN BY


JOSE TAVARES


PROJECT NAME


DEVNEY CSG

DRAWING TITLE FENCE DETAIL


SCALE 1 NTS

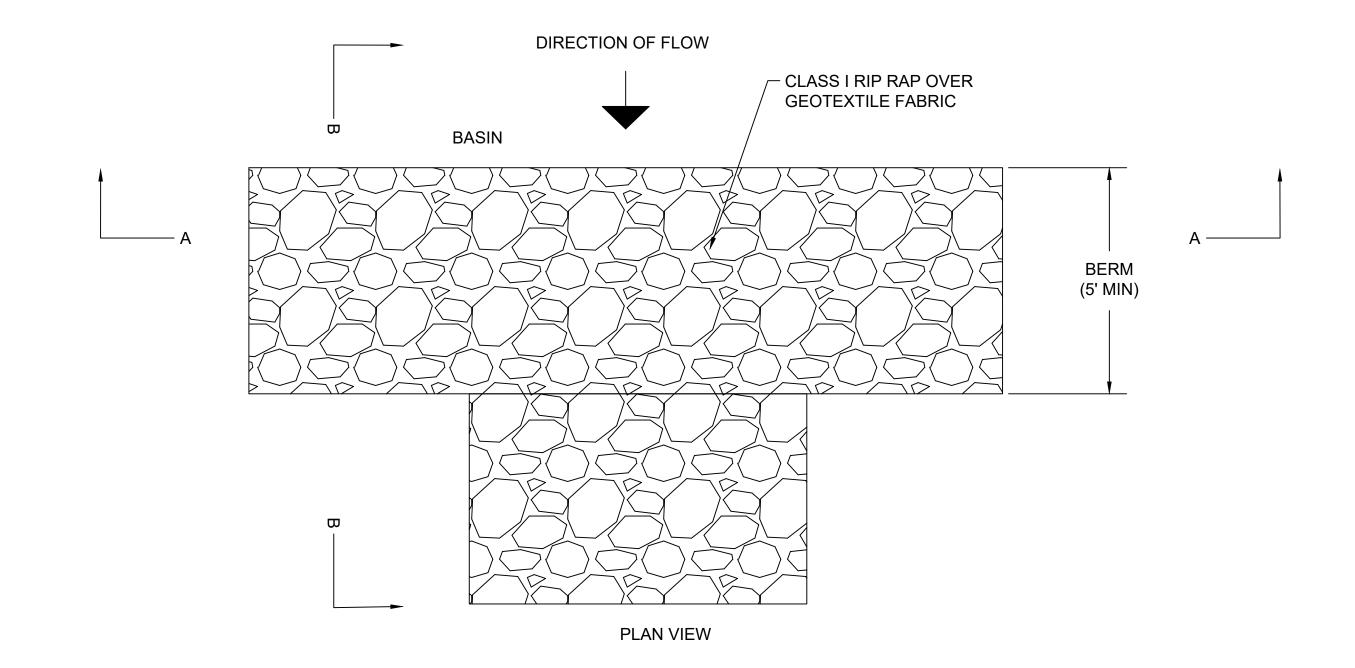

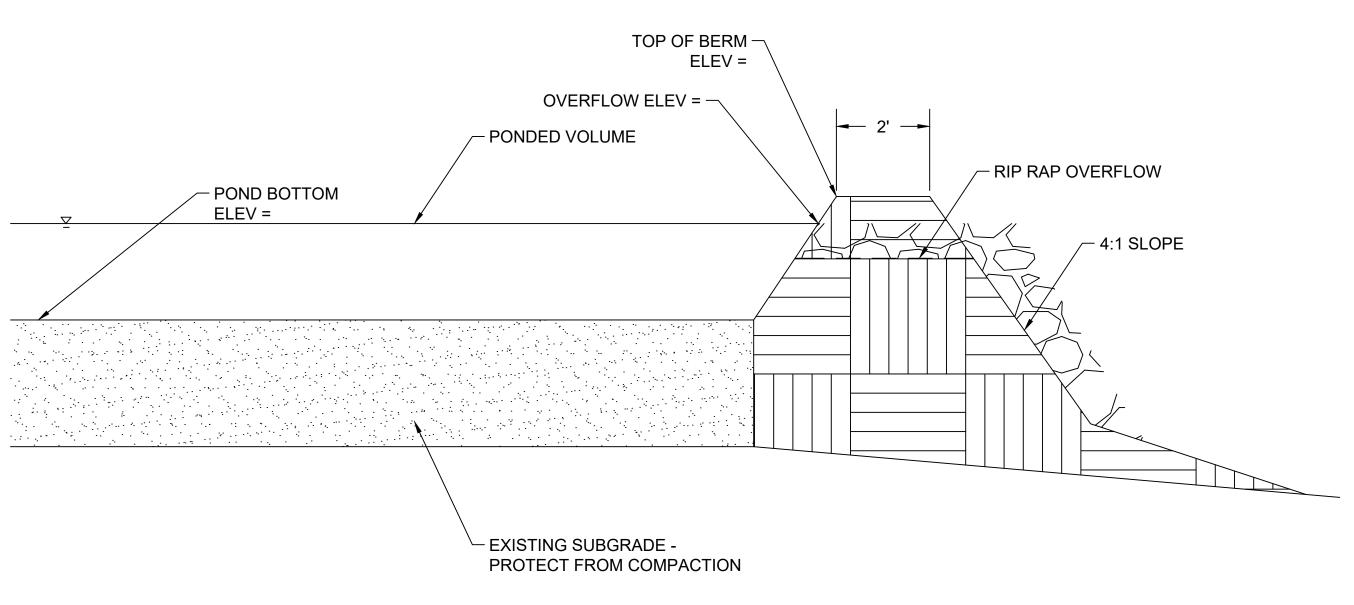

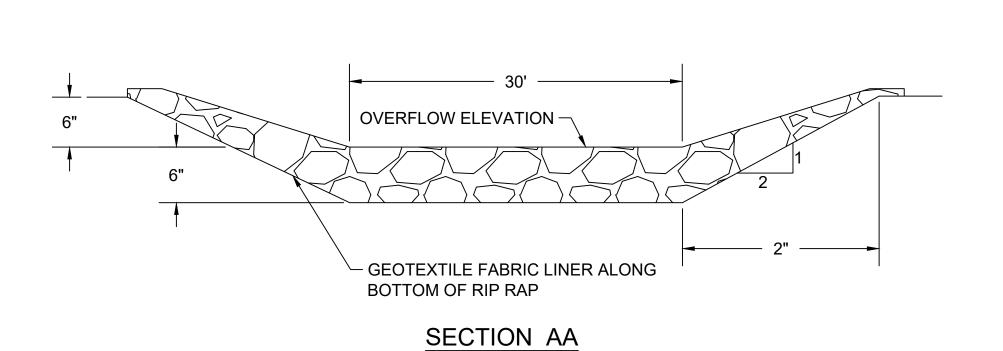

1 INFILTRATION BASIN

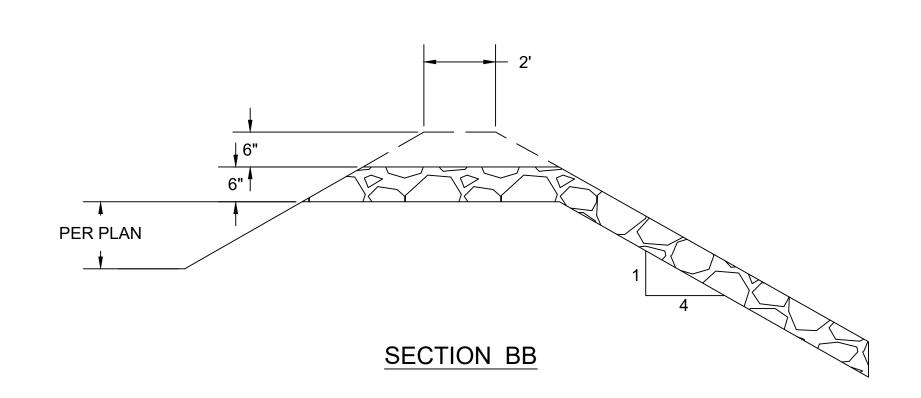

2 RIP RAP OVERFLOW



NEW ENERGY EQUITY, LLC 2530 RIVA ROAD, SUITE 200 ANNAPOLIS, MD 21041 NEWENERGYEQUITY.COM 443-267-5012

PROJECT ADDRESS 3869-3999 MN-19 NORTHFIELD, MN 55057 LAT: 44.4737619461 LONG: -93.2188576538

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SYSTEM SIZE AC	1.000 MW
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TILT	+/- 52°
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MODULE STC RATING	380 W
INVERTER COUNT	8
INVERTER TYPE	CPS SCA125KTL-DO/US
INVERTER POWER	125kW
RACKING	TBD
MONITORING	ALSO ENERGY

DESIGN CRITERIA		
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WIND SPEED (ASCE 7-10)	105 MPH	
BUILDING CATEGORY	I	
EXPOSURE CATEGORY	С	
GROUND SNOW LOAD	50 PSF	
BUILDING HEIGHT	0'-0"	

OTHER NOTES

CASE NUMBER 04124406

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INTERCONNECTION TYPE: SECONDARY

PROJECT OWNER: MN CSG 2019-77 LLC

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DRAWN BY

JOSE TAVARES

PROJECT NAME

DEVNEY CSG

INFILTRATION BASIN DETAIL

NTS




SHEE


PV4



1 BLACK HILLS SPRUCE SCREENING

Scale: N.T.S.

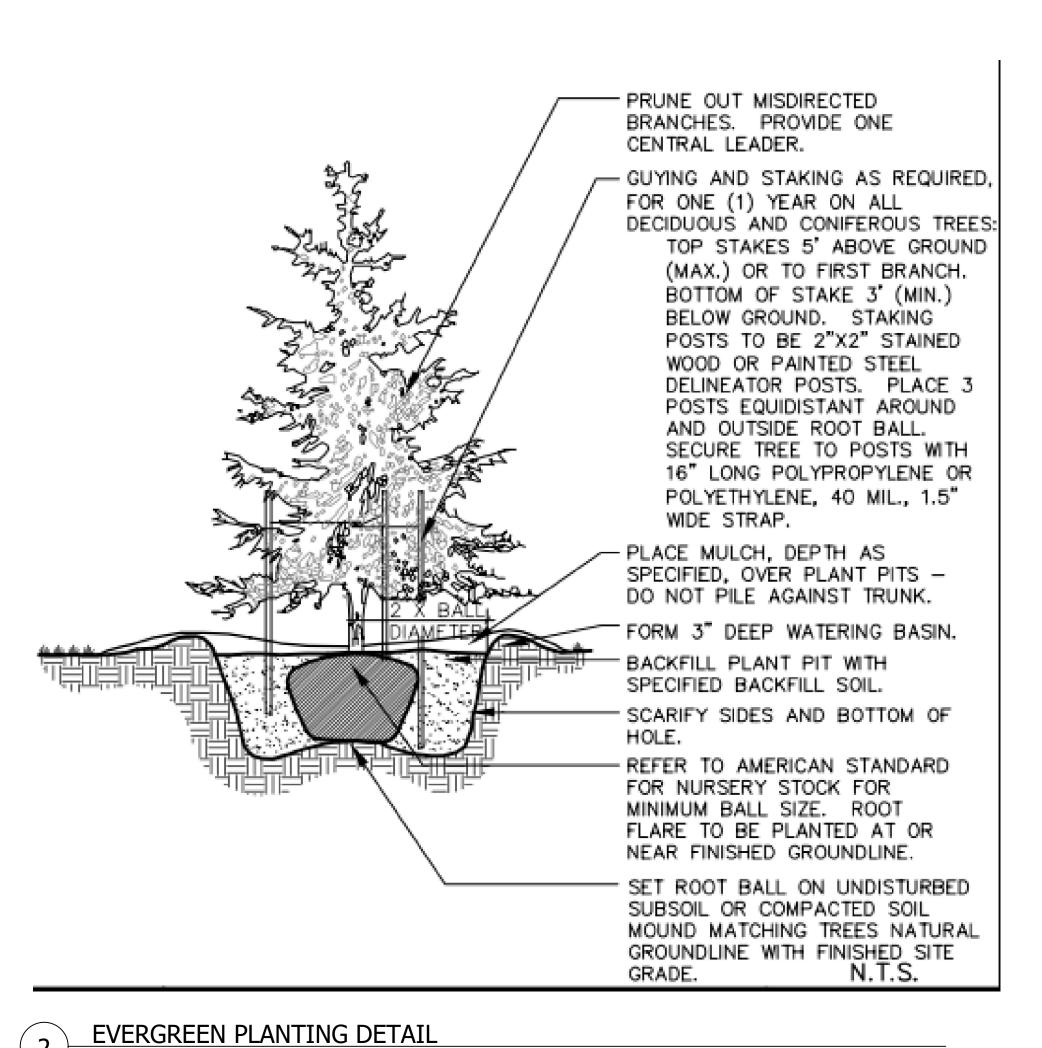

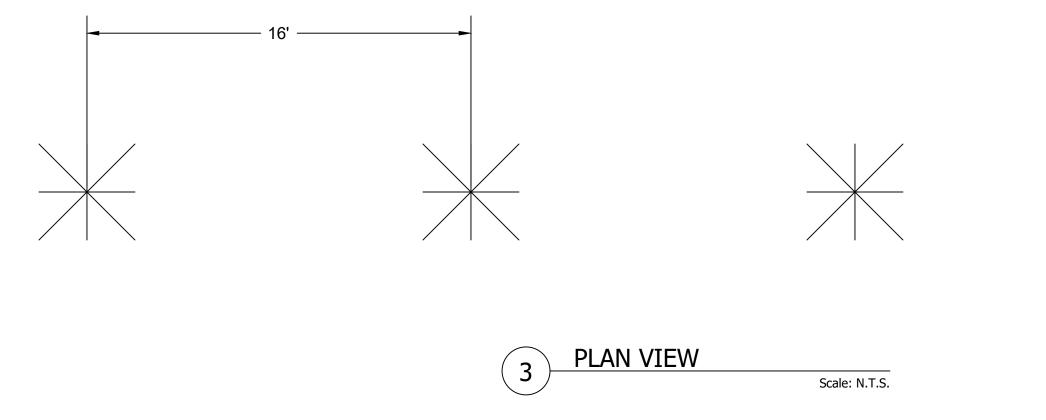

PLANTING SCHEDULE

NUMBER OF ROWS: 1

SPACING: 16' O.C.

TYPE: BLACK HILLS SPRUCE

HEIGHT: 6' MIN WITHIN 3 YEARS OF PLANTING



NEW ENERGY EQUITY, LLC 2530 RIVA ROAD, SUITE 200 ANNAPOLIS, MD 21041 NEWENERGYEQUITY.COM 443-267-5012

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MODULE STC RATING	380 W			
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INVERTER POWER	125kW			
RACKING	TBD			
MONITORING	ALSO ENERGY			

DESIGN CRITERIA		
MIN/MAX TEMP.	-29°C / 31°C	
WIND SPEED (ASCE 7-10)	105 MPH	
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BUILDING HEIGHT	0'-0"	

OTHER NOTES

CASE NUMBER 04124406

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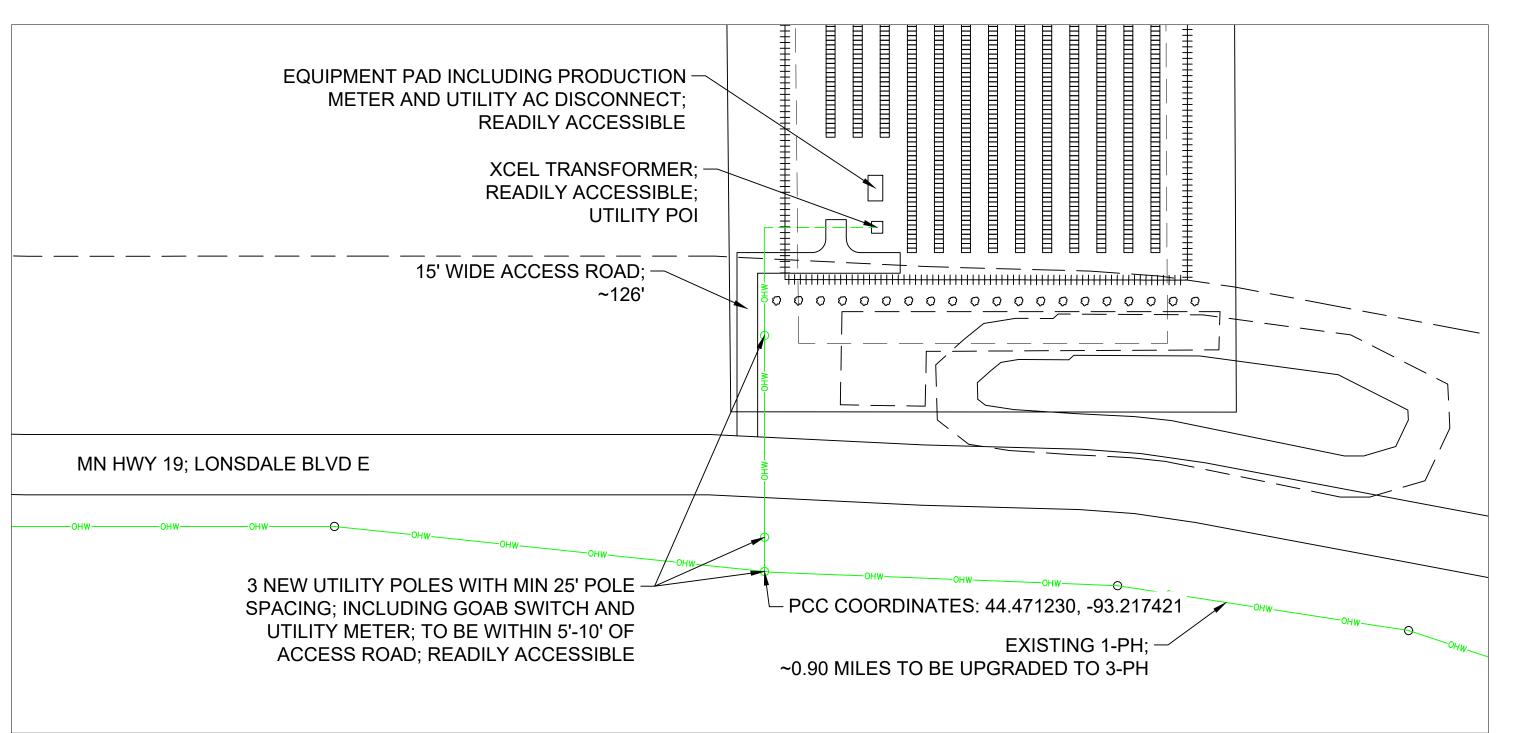
TREE PLAN

SCALE 1



SHEET

DV5




INTERCONNECTION PLAN

Scale: 1" = 70'


SHEET NOTES:

- 1. Overhead line to underground service conductors detail - provided by utility 2. Fence Detail and Fence Grounding -
- provided in the civil engineering drawings



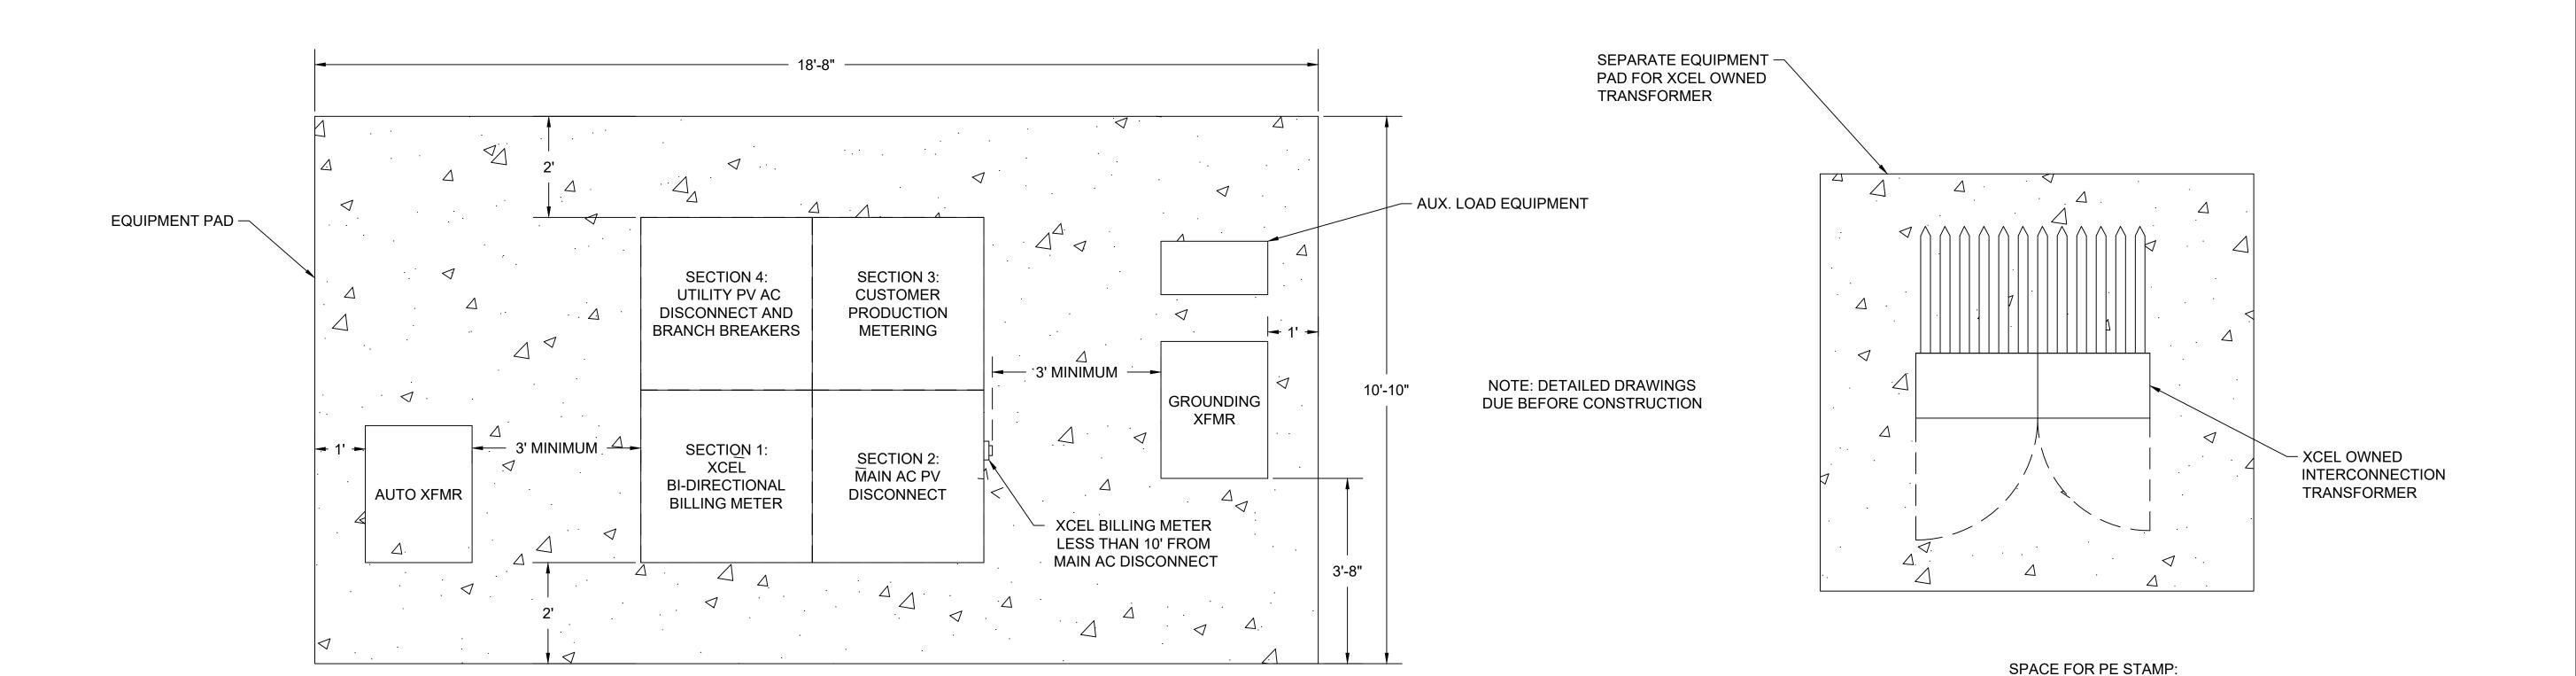

EQUIPMENT PAD PLAN Scale: 3/4" = 1'

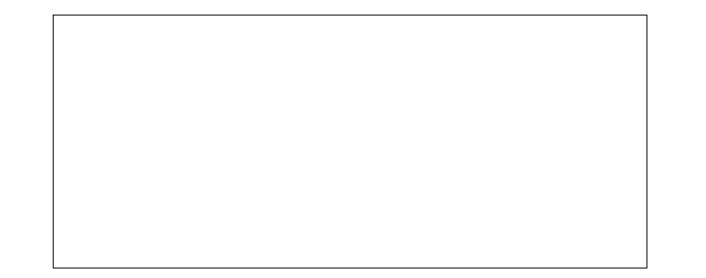



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INVERTER POWER	125kW	
RACKING	TBD	
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DESIGN CRITERIA		
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OTHER NOTES

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DRAWN BY


JOSE TAVARES

PROJECT NAME

DEVNEY CSG

DRAWING TITLE ELECTRICAL DETAILS

AS NOTED 0

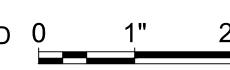

SHEET



The 100 & 125kW high power CPS three phase string inverters are designed for ground mount applications. The units are high performance, advanced and reliable inverters designed specifically for the North American environment and grid. High efficiency at 99.1% peak and 98.5% CEC, wide operating voltages, broad temperature ranges and a NEMA Type 4X enclosure enable this inverter platform to operate at high performance across many applications. The CPS 100/125kW products ship with the Standard or Centralized Wire-box, each fully integrated and separable with AC and DC disconnect switches. The Standard Wire-box inlcudes touch safe fusing for up to 20 strings. The CPS Flex Gateway enables communication, controls and remote product upgrades.

Key Features

- NFPA 70, NEC 2014 and 2017 compliant
- Touch safe DC Fuse holders adds convenience and safety CPS Flex Gateway enables remote FW upgrades
- Integrated AC & DC disconnect switches
- 1 MPPT with 20 fused inputs for maximum flexibility
- Copper and Aluminum compatible AC connections



100/125KTL Standard Wire-box

© CHINT POWER SYSTEMS AMERICA 2020/01-MKT NA

Chint Power Systems America 6800 Koll Center Parkway, Suite 235 Pleasanton, CA 94566 Sales@chintpower.com Web: www.chintpowersystems.com Tel: 855-584-7168 Mail: AmericaSale

100/125KTL Centralized Wire-box

NEMA Type 4X outdoor rated, tough tested enclosure


kVA Headroom yields 100kW @ 0.9PF and 125kW @ 0.95PF

Advanced Smart-Grid features (CA Rule 21 certified)


■ Generous 1.87 and 1.5 DC/AC Inverter Load Ratios

Standard 5 year warranty with extensions to 20 years

Separable wire-box design for fast service

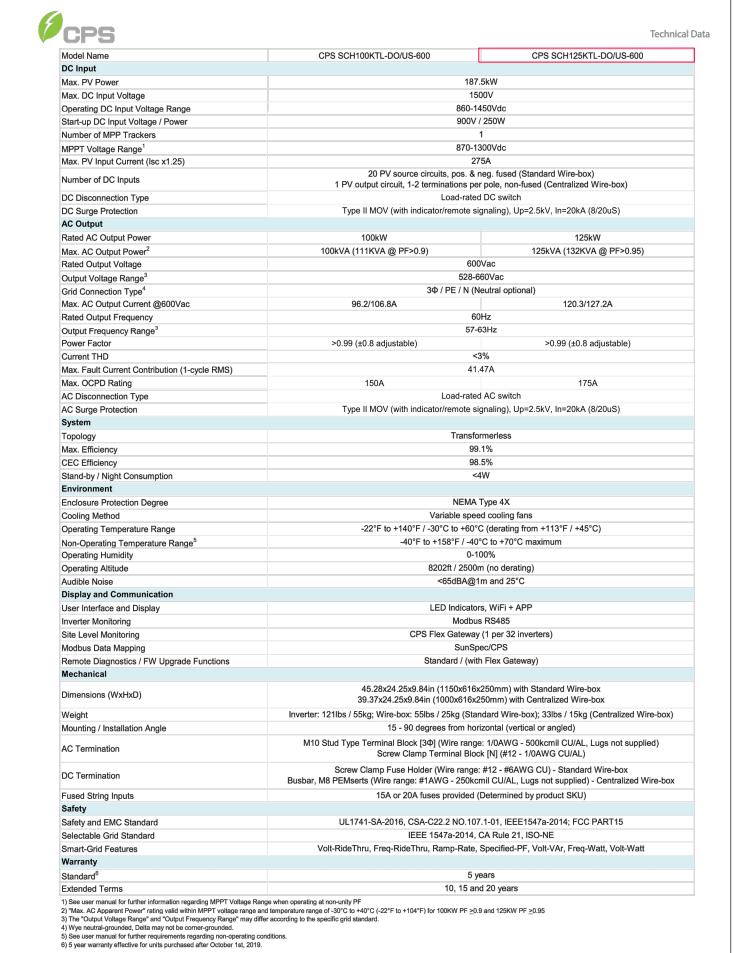

REC TWINPEAK 25 MONO 72 SERIES

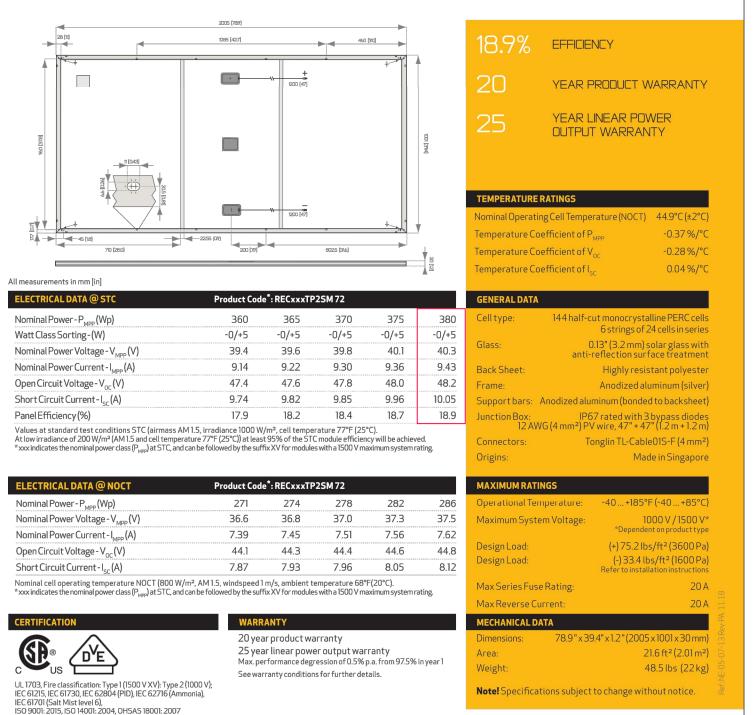

 REC



ANNAPOLIS, MD 21041

NEWENERGYEQUITY.COM

443-267-5012 PROJECT ADDRESS

3869-3999 MN-19

NORTHFIELD, MN 55057

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6				
7				

DRAWN BY JOSE TAVARES PROJECT NAME DEVNEY CSG

DRAWING TITLE **EQUIPMENT DOCUMENTS**

SCALE 1

SHEET

