


NORTHFIELD BRIDGE SQUARE

RIVERFRONT & SQUARE IMPROVEMENTS

12 BRIDGE SQUARE NORTHFIELD, MN 55057

PROJECT # 22-184

CONTEXT MAP

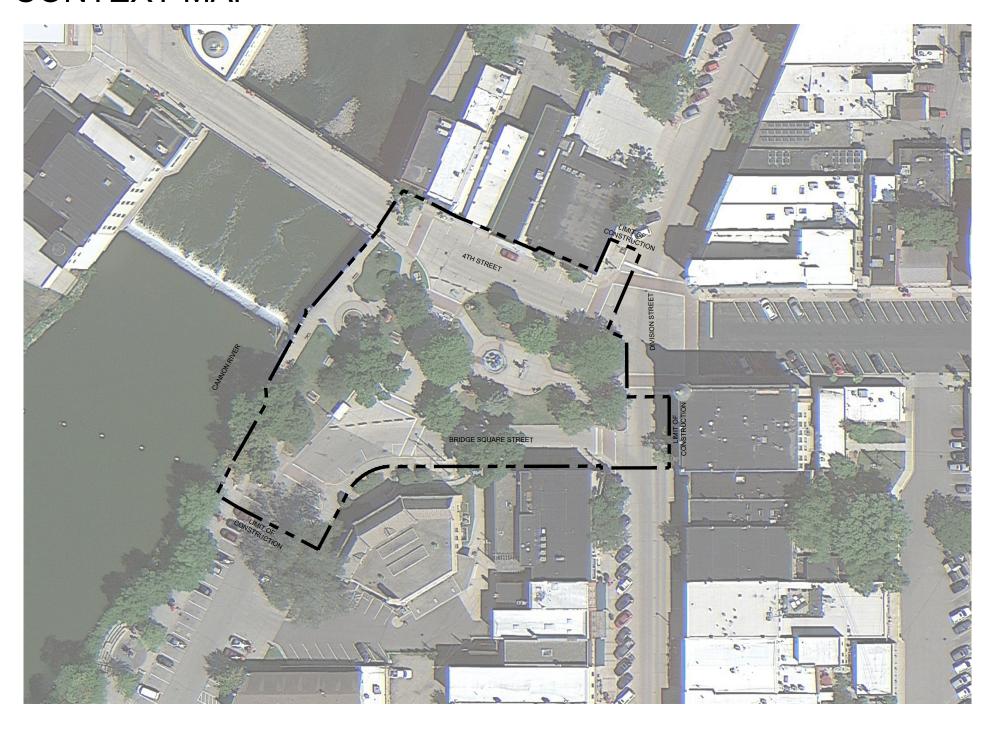

PROPOSED DESIGN



PROJECT DIRECTORY

OWNER

CITY OF NORTHFIELD

DAVID BENNETT | PUBLIC WORKS DIRECTOR/CITY ENGINEER 801 WASHINGTON STREET NORTHFIELD, MINNESOTA 55057 DAVID.BENNETT@CI.NORTHFIELD.MN.US

P: 507.645.3006

LANDSCAPE ARCHITECT

DAMON FARBER LANDSCAPE ARCHITECTS
310 S 4TH AVE
MINNEAPOLIS, MN 55415
CONTACT: RACHEL BAUDLER BLASEG, PLA
RBLASEG@DAMONFARBER.COM
415.407.7883

CIVIL ENGINEER

BOLTON & MENK
CONTACT: BRAD FISHER P.E.
BRADLEY.FISHER@BOLTON-MENK.COM
612.759.7240

ELECTRICAL ENGINEER

NELSON-RUDIE & ASSOCIATES, INC. CONTACT: SARAH GREFF SARAH.GREFF@NELSONRUDIE.COM 763.367.7600


LIGHTING ENGINEER

SCHULER & SHOOK
CONTACT: PAUL WHITAKER, LEED AP, WELL AP, PRINCIPAL
PWHITAKER@SCHULERSHOOK.COM
612.339.5958

SHEET INDEX

SHEETI	NDEX
SHEET#	SHEET TITLE
GENERAL G000 G001	COVER & SHEET INDEX EXISTING CONDITIONS PLAN
CIVIL C0.01 C1.01 C2.01 C3.01 C4.01 C4.02 C5.01 C6.01 C6.02	REMOVALS PLAN GEOMETRICS PLAN FINISHING PLAN GRADING AND DRAINAGE PLAN UTILITY PLAN - STORM SEWER UTILITY PLAN - SANITARY & WATER SEDIMENT AND EROSION CONTROL PLAN CIVIL DETAILS CIVIL DETAILS
LANDSCAPE L001 L002 L003 L004 L010 L011 L012 L050 L100 L101 L102 L121 L130 L140 L141 L150 L400 L500 L501 L502 L503 L504 L505 L506 L507	GENERAL NOTES, ABBREVIATIONS & SYMBOLS LANDSCAPE NOTES TREE PRESERVATION NOTES & DETAILS SITE TREE PROTECTION PLAN SITE MATERIALS SCHEDULE SITE LANDSCAPE SCHEDULE SITE SCHEDULES SITE ORIENTATION PLAN SITE LAYOUT AND DIMENSIONING PLAN SITE HARDSCAPE PLAN SITE FURNISHINGS PLAN PLANT ENLARGEMENT - LAWN TERRACE PLANT ENLARGEMENT - THE SQUARE SITE SOILS PLAN SITE TREE PLAN SITE TREE PLAN SITE UNDERSTORY PLANTING SITE IRRIGATION PLAN SITE SECTIONS KEY PLAN SITE DETAILS SITE LANDSCAPE DETAILS SITE LANDSCAPE DETAILS
ELECTRICAL E001 E100 E200	ELECTRICAL TITLE SHEET ELECTRICAL SITE PLAN ELECTRICAL DETAILS
<u>LIGHTING</u> AL100 AL101	

COVER & SHEET INDEX

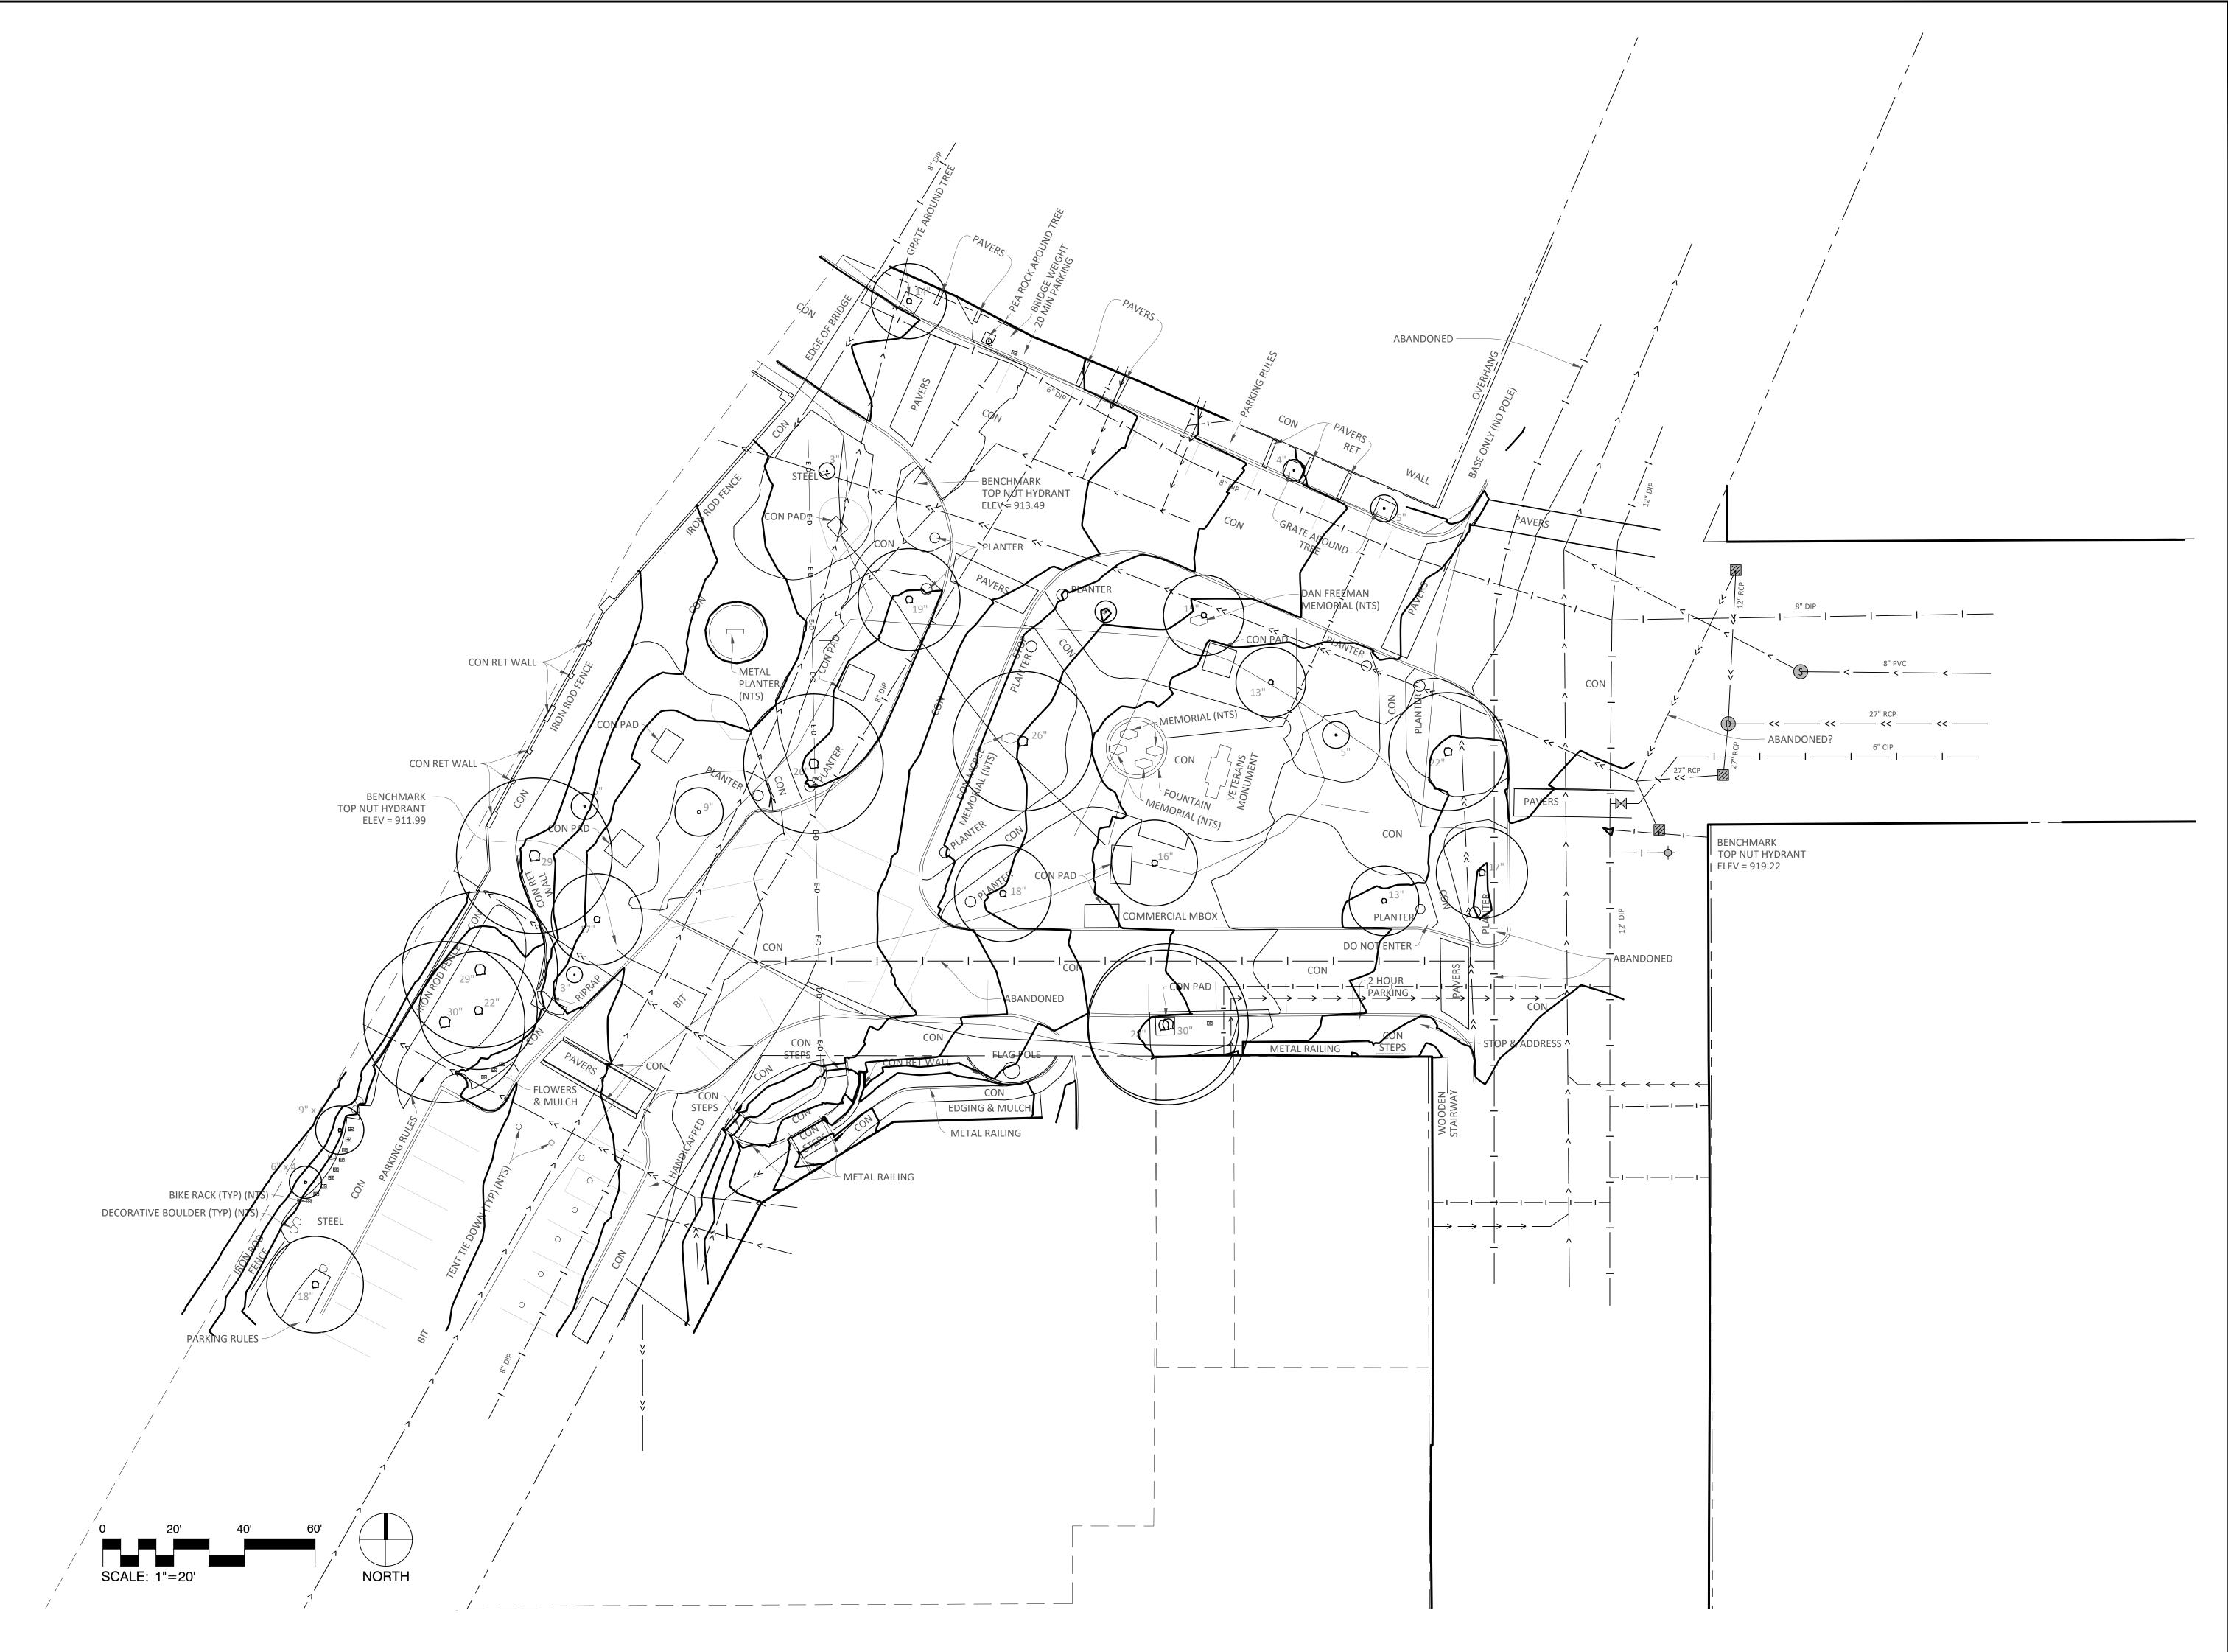



Minnesota

CITY OF NORTHFIELD 801 WASHINGTON STREET NORTHFIELD, MINNESOTA 55057

DAMON FARBER LANDSCAPE ARCHITECTS

DAVID.BENNETT@CI.NORTHFIELD.MN.US

310 S 4TH AVE MINNEAPOLIS, MN 55415 RBLASEG@DAMONFARBER.COM 612.332.7522

BOLTON & MENK

7575 GOLDEN VALLEY ROAD SUITE 200 MINNEAPOLIS, MN 55427 BRADLEY.FISHER@BOLTON-MENK.COM 612.759.7240

NELSON-RUDIE & ASSOCIATES, 9100 49TH AVE N,

MINNEAPOLIS, MN 55428 SARAH.GREFF@NELSONRUDIE.COM 763.367.7600

SCHULER & SHOOK

219 SE MAIN ST MINNEAPOLIS, MN 55414 PWHITAKER@SCHULERSHOOK.COM 612.339.5958

60% PRICING SET

NORTHFIELD BRIDGE SQUARE


NORTHFIELD, MN


I hereby certify that this document was prepared by me or under my direct supervision and that I am a duly licensed Landscape Architect under the laws of the State of Minnesota.

Tom Whitlock

26292 Registration# Date Signature 09/26/2023 DF/ Project # 22-184 AS SHOWN RP/AG/BE/RB Drawn/Checked

> **EXISTING** CONDITIONS PLAN

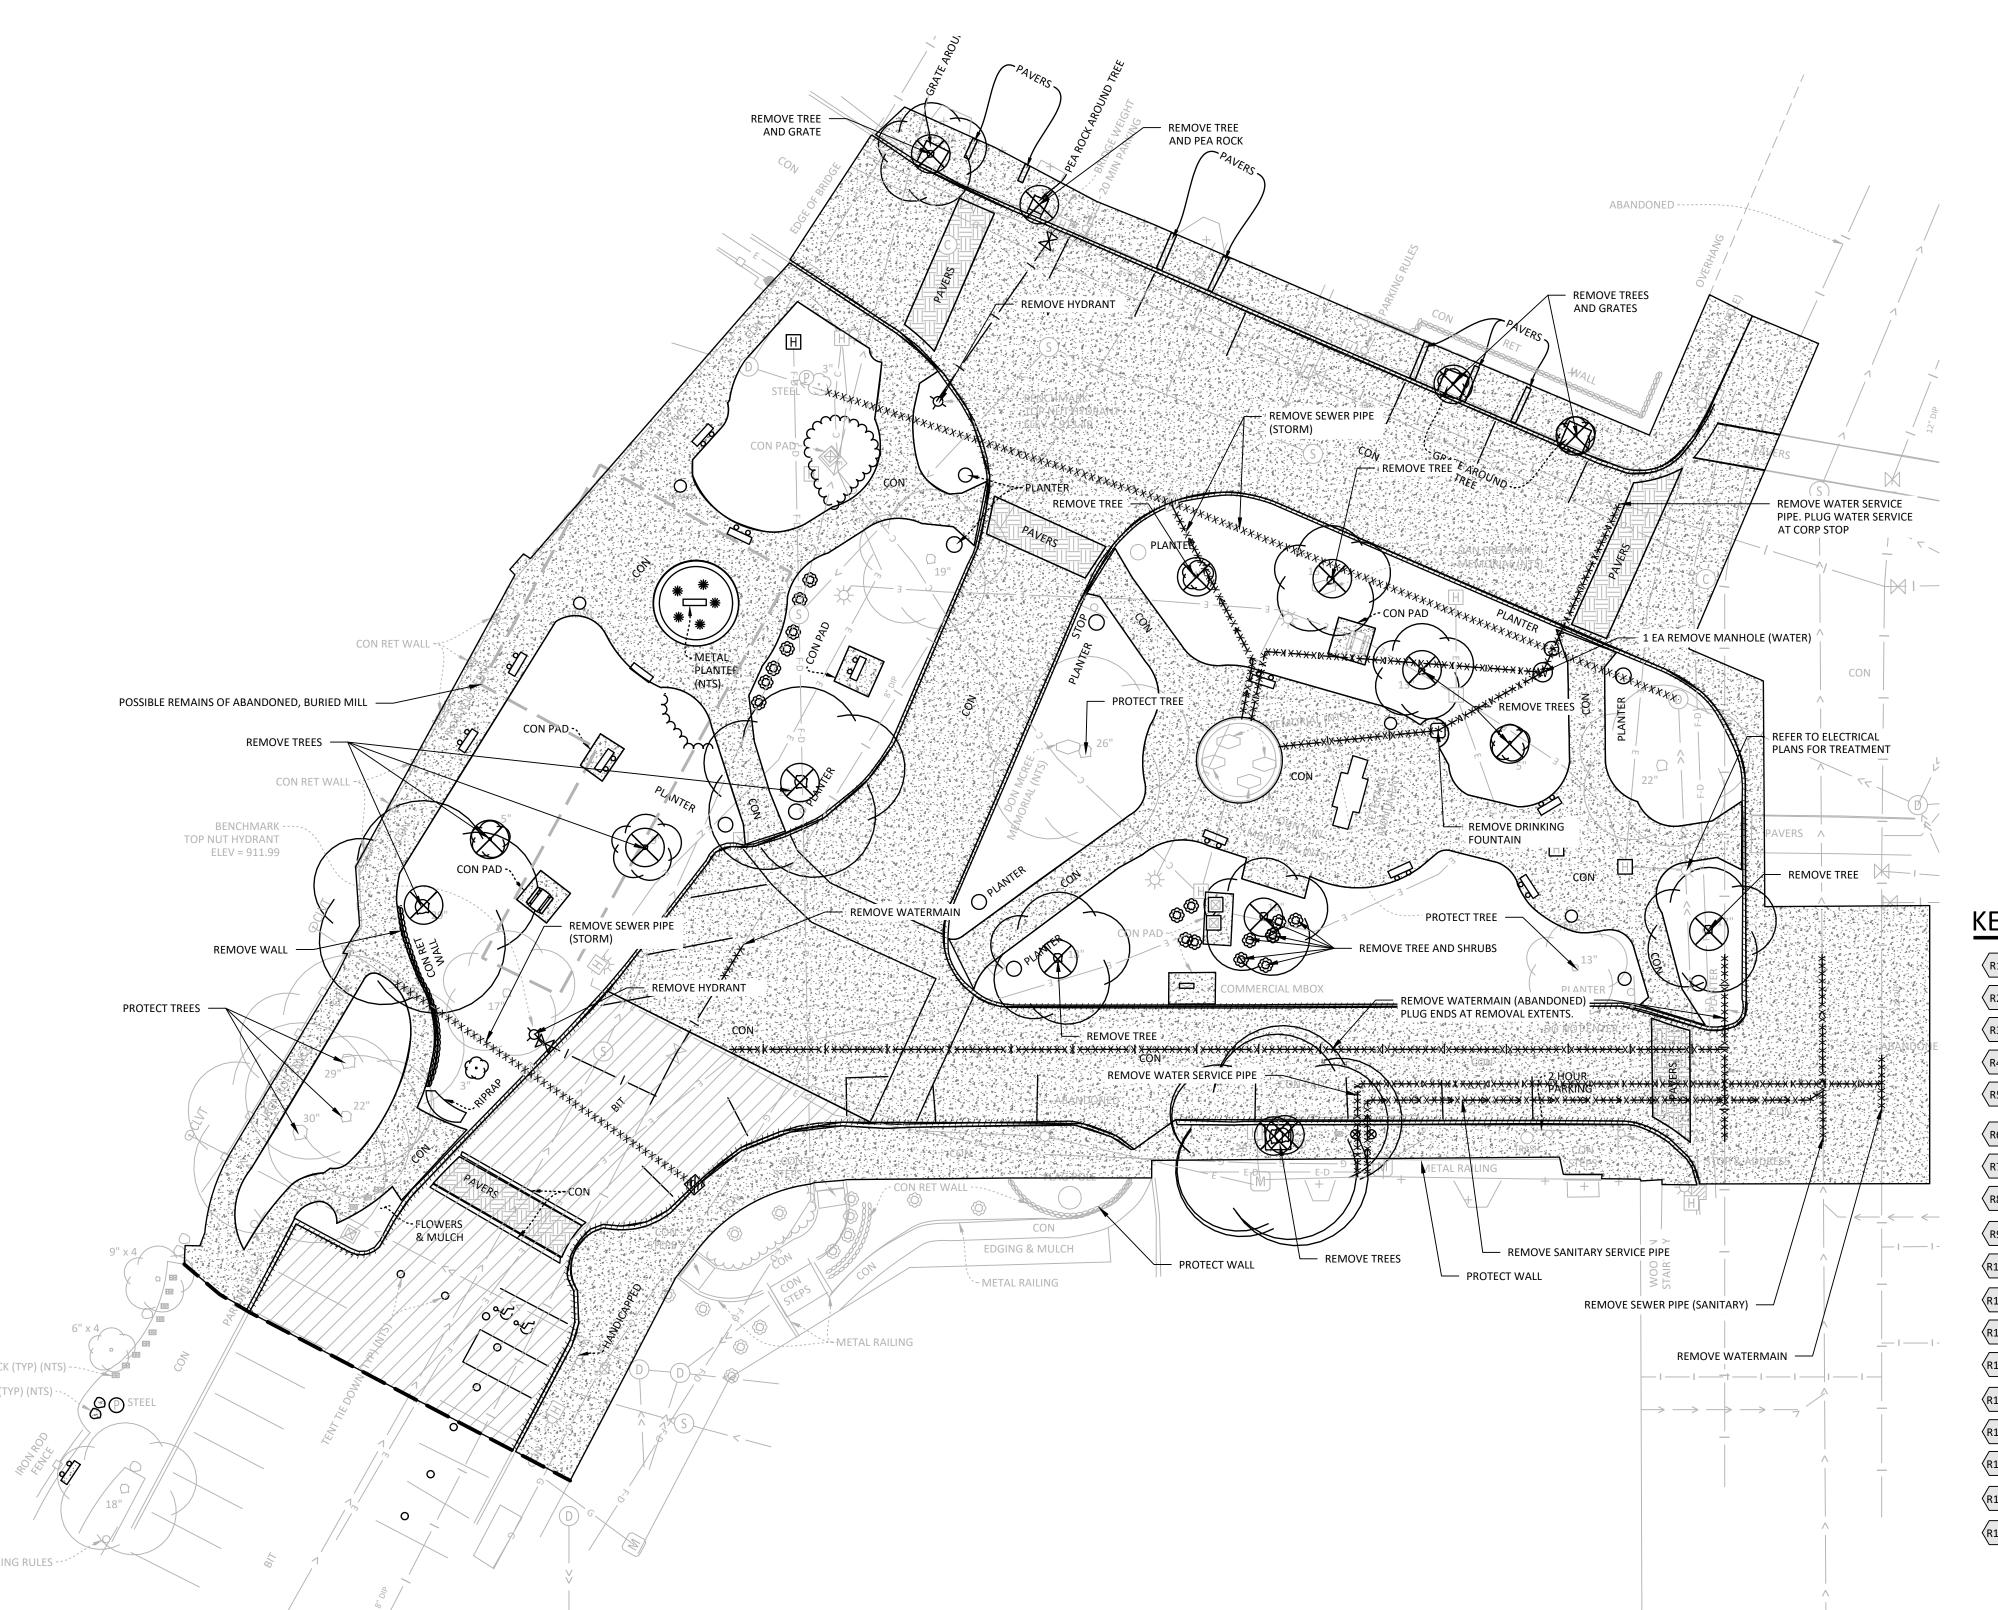

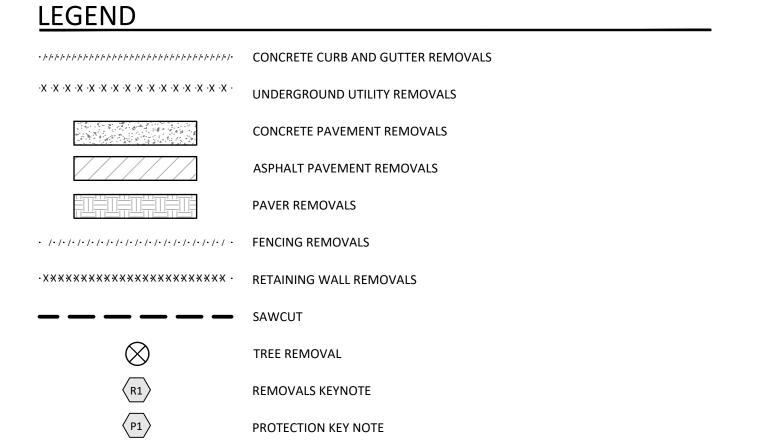

NOTES


1. REFER TO SHEET C3.01, GRADING AN DRAINAGE PLAN, FOR GENERAL NOTES.

— PROPERTY LINE

- 2. MINIMIZE DISTURBANCE TO SITE AND PROTECT EXISTING VEGETATION AND SITE FEATURES (CURBS, WALKS, PAVEMENTS, OVERHEAD AND UNDERGROUND UTILITIES, SIGNAGE, FENCING, ROADWAYS, ETC.) WHICH ARE TO REMAIN.
- 3. REPAIR OR REPLACE EXISTING PROPERTY AND SITE FEATURES, INCLUDING GRASS AND VEGETATION, WHICH IS TO REMAIN THAT IS DAMAGED BY THE WORK, TO THE OWNER'S SATISFACTION AND AT NO ADDITIONAL COST TO THE OWNER.
- 4. VISIT THE SITE PRIOR TO BIDDING; BE FAMILIAR WITH ACTUAL CONDITIONS IN THE FIELD. EXTRA COMPENSATION WILL NOT BE ALLOWED FOR CONDITIONS WHICH COULD HAVE BEEN DETERMINED OR ANTICIPATED BY EXAMINATION OF THE SITE, THE CONTRACT DRAWINGS AND THE INFORMATION AVAILABLE PERTAINING TO EXISTING SOILS, UTILITIES AND OTHER SITE
- 5. HIRE THE SERVICES OF A UTILITY LOCATOR COMPANY TO LOCATE ALL PRIVATELY OWNED UTILITIES THAT MAY BE DISTURBED BY
- 6. MAINTAIN DRAINAGE FROM EXISTING BUILDING AT ALL TIMES. PROVIDE TEMPORARY STORM SEWER, INCLUDING, BUT NOT LIMITED TO, CATCH BASINS, MANHOLES, PIPING, AND SIMILAR. DO NOT REMOVE EXISTING STORM SEWER UNTIL TEMPORARY OR PERMANENT STORM SEWER IS INSTALLED AND FUNCTIONAL. COORDINATE ALL REMOVALS WITH APPROPRIATE TRADES (SITE UTILITY CONTRACTOR, MECHANICAL CONTRACTOR, ETC.) AS REQUIRED.

KEY NOTE LEGEND

CHARACTERISTICS.

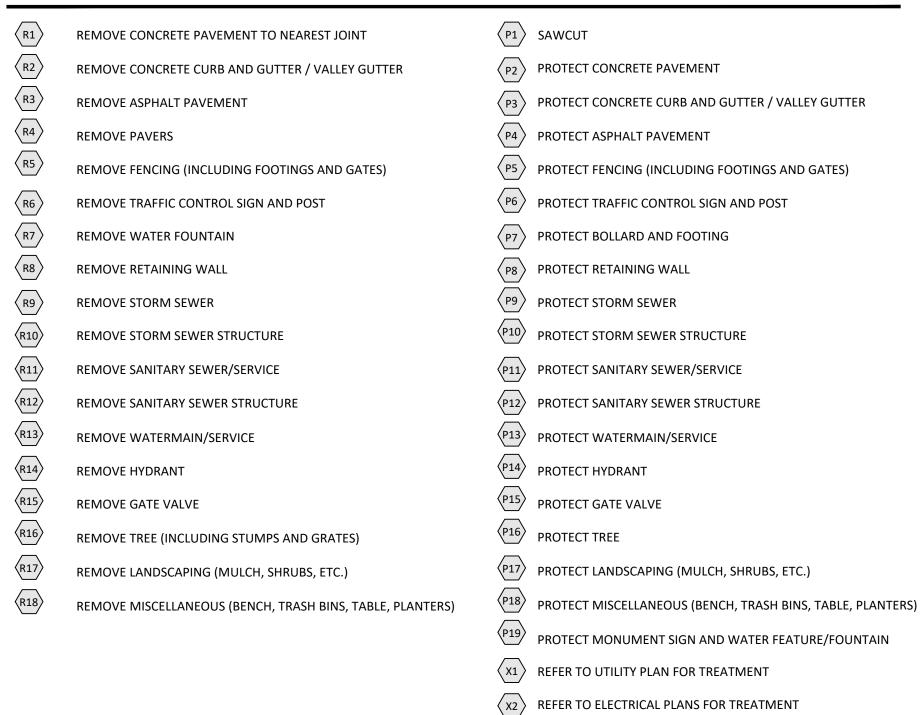



CITY OF NORTHFIELD

801 WASHINGTON STREET
NORTHFIELD, MINNESOTA 55057
DAVID.BENNETT@CI.NORTHFIELD.MN.US

DAMON FARBER
LANDSCAPE ARCHITECTS

310 S 4TH AVE
MINNEAPOLIS, MN 55415
RBLASEG@DAMONFARBER.COM
612.332.7522

BOLTON & MENK

7575 GOLDEN VALLEY ROAD SUITE 200 MINNEAPOLIS, MN 55427 BRADLEY.FISHER@BOLTON-MENK.COM 612.759.7240

NELSON-RUDIE & ASSOCIATES, 9100 49TH AVE N, MINNEAPOLIS, MN 55428

MINNEAPOLIS, MN 55428 SARAH.GREFF@NELSONRUDIE.COM 763.367.7600

SCHULER & SHOOK

219 SE MAIN ST MINNEAPOLIS, MN 55414 PWHITAKER@SCHULERSHOOK.COM 612.339.5958

60% PRICING SET

NORTHFIELD BRIDGE SQUARE

NORTHFIELD, MN


I hereby certify that this document was prepared by me or under my direct supervision and that I am a duly licensed Landscape Architect under the laws of the State of Minnesota.

Tom Whitlock


Registration#	262
Signature	Da
	09/26/20
DF/ Project #	22-1
Scale	AS SHOV
Drawn/Checked	RP/AG/BE/I
REVISION •	400

REMOVALS PLAN

C0.01

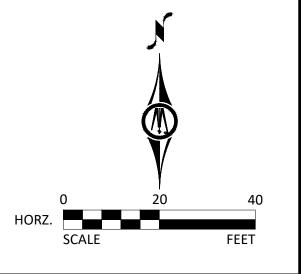


X3 REFER TO ARCHITECTURAL PLANS FOR TREATMENT

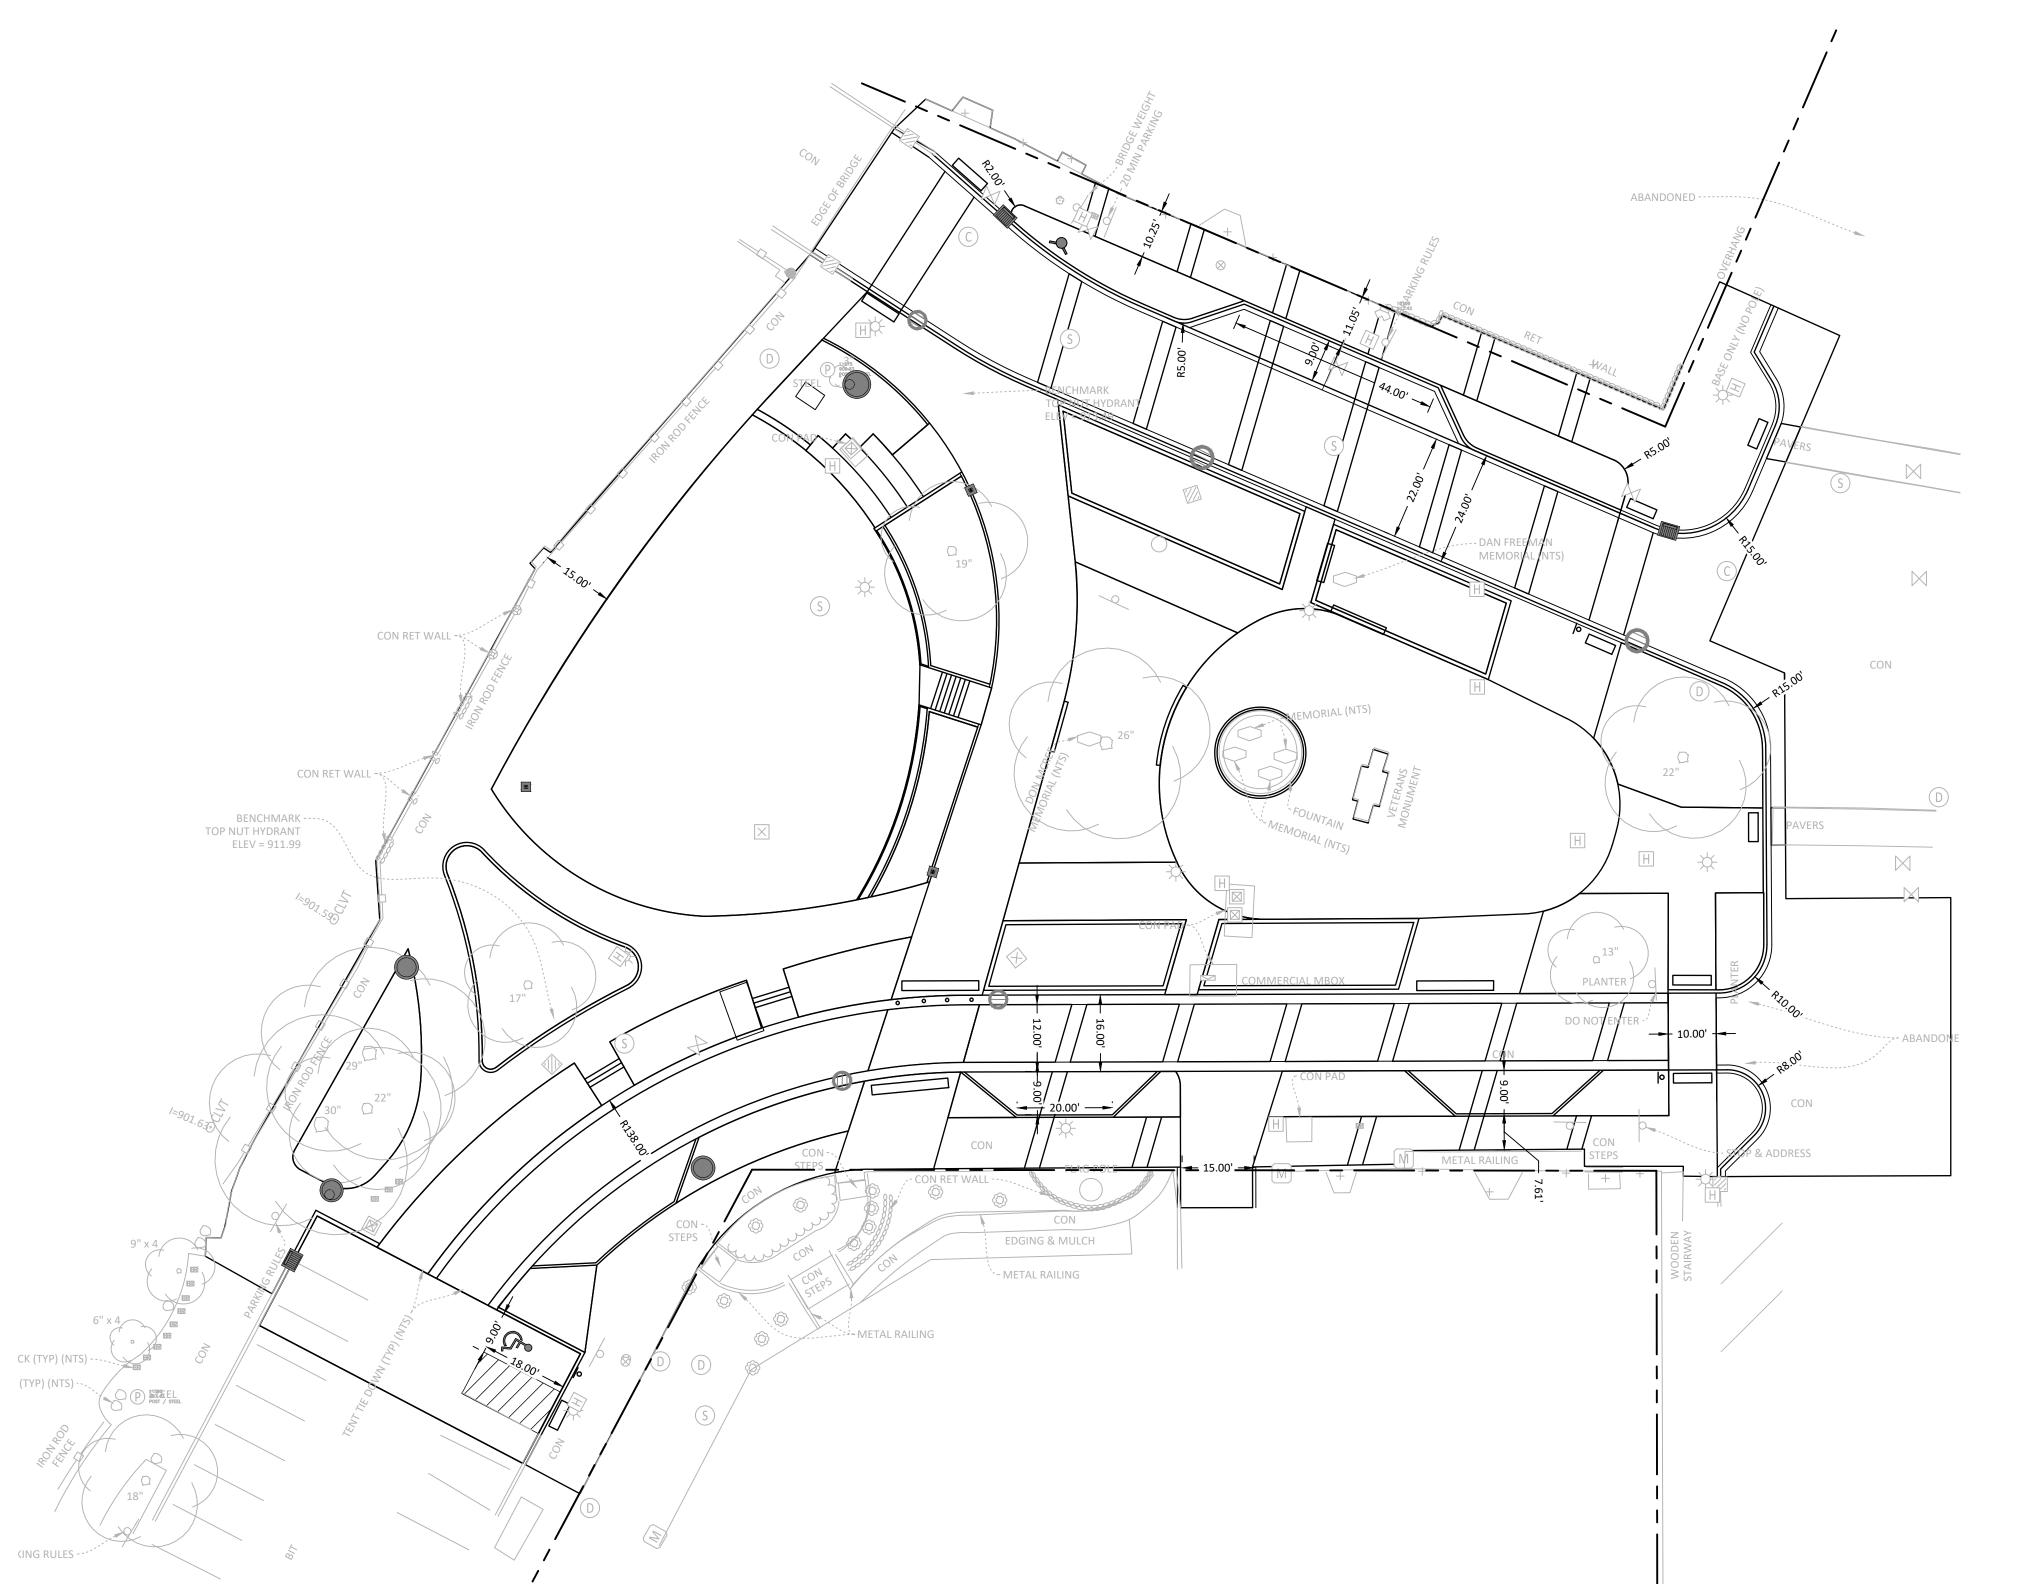

	BASELINE FOR DIMENSIONS
PI	POINT OF INTERSECTION
PC	POINT OF CURVATURE
PT	POINT OF TANGENCY
PCC	POINT OF COMPOUND CURVATURE
	PROPERTY LINE

NOTES

- 1. REFER TO SHEET C3.01, GRADING AND DRAINAGE PLAN, FOR GENERAL NOTES.
- 2. ALL APPLICABLE DIMENSIONS ARE TO FACE OF CURB, EDGE OF PAVEMENT, CENTERLINE OF FENCE, OR PROPERTY LINE UNLESS OTHERWISE NOTED.
- 3. CHECK ALL PLAN AND DETAIL DIMENSIONS AND VERIFY SAME BEFORE FIELD LAYOUT.
- 4. SIGNAGE SHALL BE INSTALLED 18" BEHIND THE BACK OF CURB OR EDGE OF PAVEMENT.

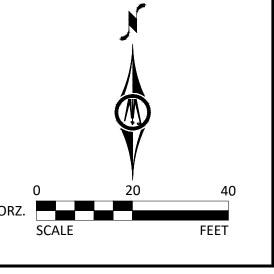

Vorthfield

CITY OF NORTHFIELD
801 WASHINGTON STREET

Minnesota

801 WASHINGTON STREET
NORTHFIELD, MINNESOTA 55057
DAVID.BENNETT@CI.NORTHFIELD.MN.US

DAMON FARBER
LANDSCAPE ARCHITECTS
310 S 4TH AVE

310 S 4TH AVE MINNEAPOLIS, MN 55415 RBLASEG@DAMONFARBER.COM 612.332.7522

BOLTON & MENK 7575 GOLDEN VALLEY ROAD

SUITE 200 MINNEAPOLIS, MN 55427 BRADLEY.FISHER@BOLTON-MENK.COM 612.759.7240

NELSON-RUDIE & ASSOCIATES, 9100 49TH AVE N, MINNEAPOLIS, MN 55428

MINNEAPOLIS, MN 55428 SARAH.GREFF@NELSONRUDIE.COM 763.367.7600

SCHULER & SHOOK

219 SE MAIN ST MINNEAPOLIS, MN 55414 PWHITAKER@SCHULERSHOOK.COM 612.339.5958

60% PRICING SET

NORTHFIELD BRIDGE SQUARE

NORTHFIELD, MN

I hereby certify that this document was prepared by me or under my direct supervision and that I am a duly licensed Landscape Architect under the laws of the State of Minnesota.

Tom Whitlock

Registration# 26292

Signature Date

09/26/2023

DF/ Project # 22-184


Scale AS SHOWN


Drawn/Checked RP/AG/BE/RB

REVISION ---

GEOMETRICS PLAN

C1.01

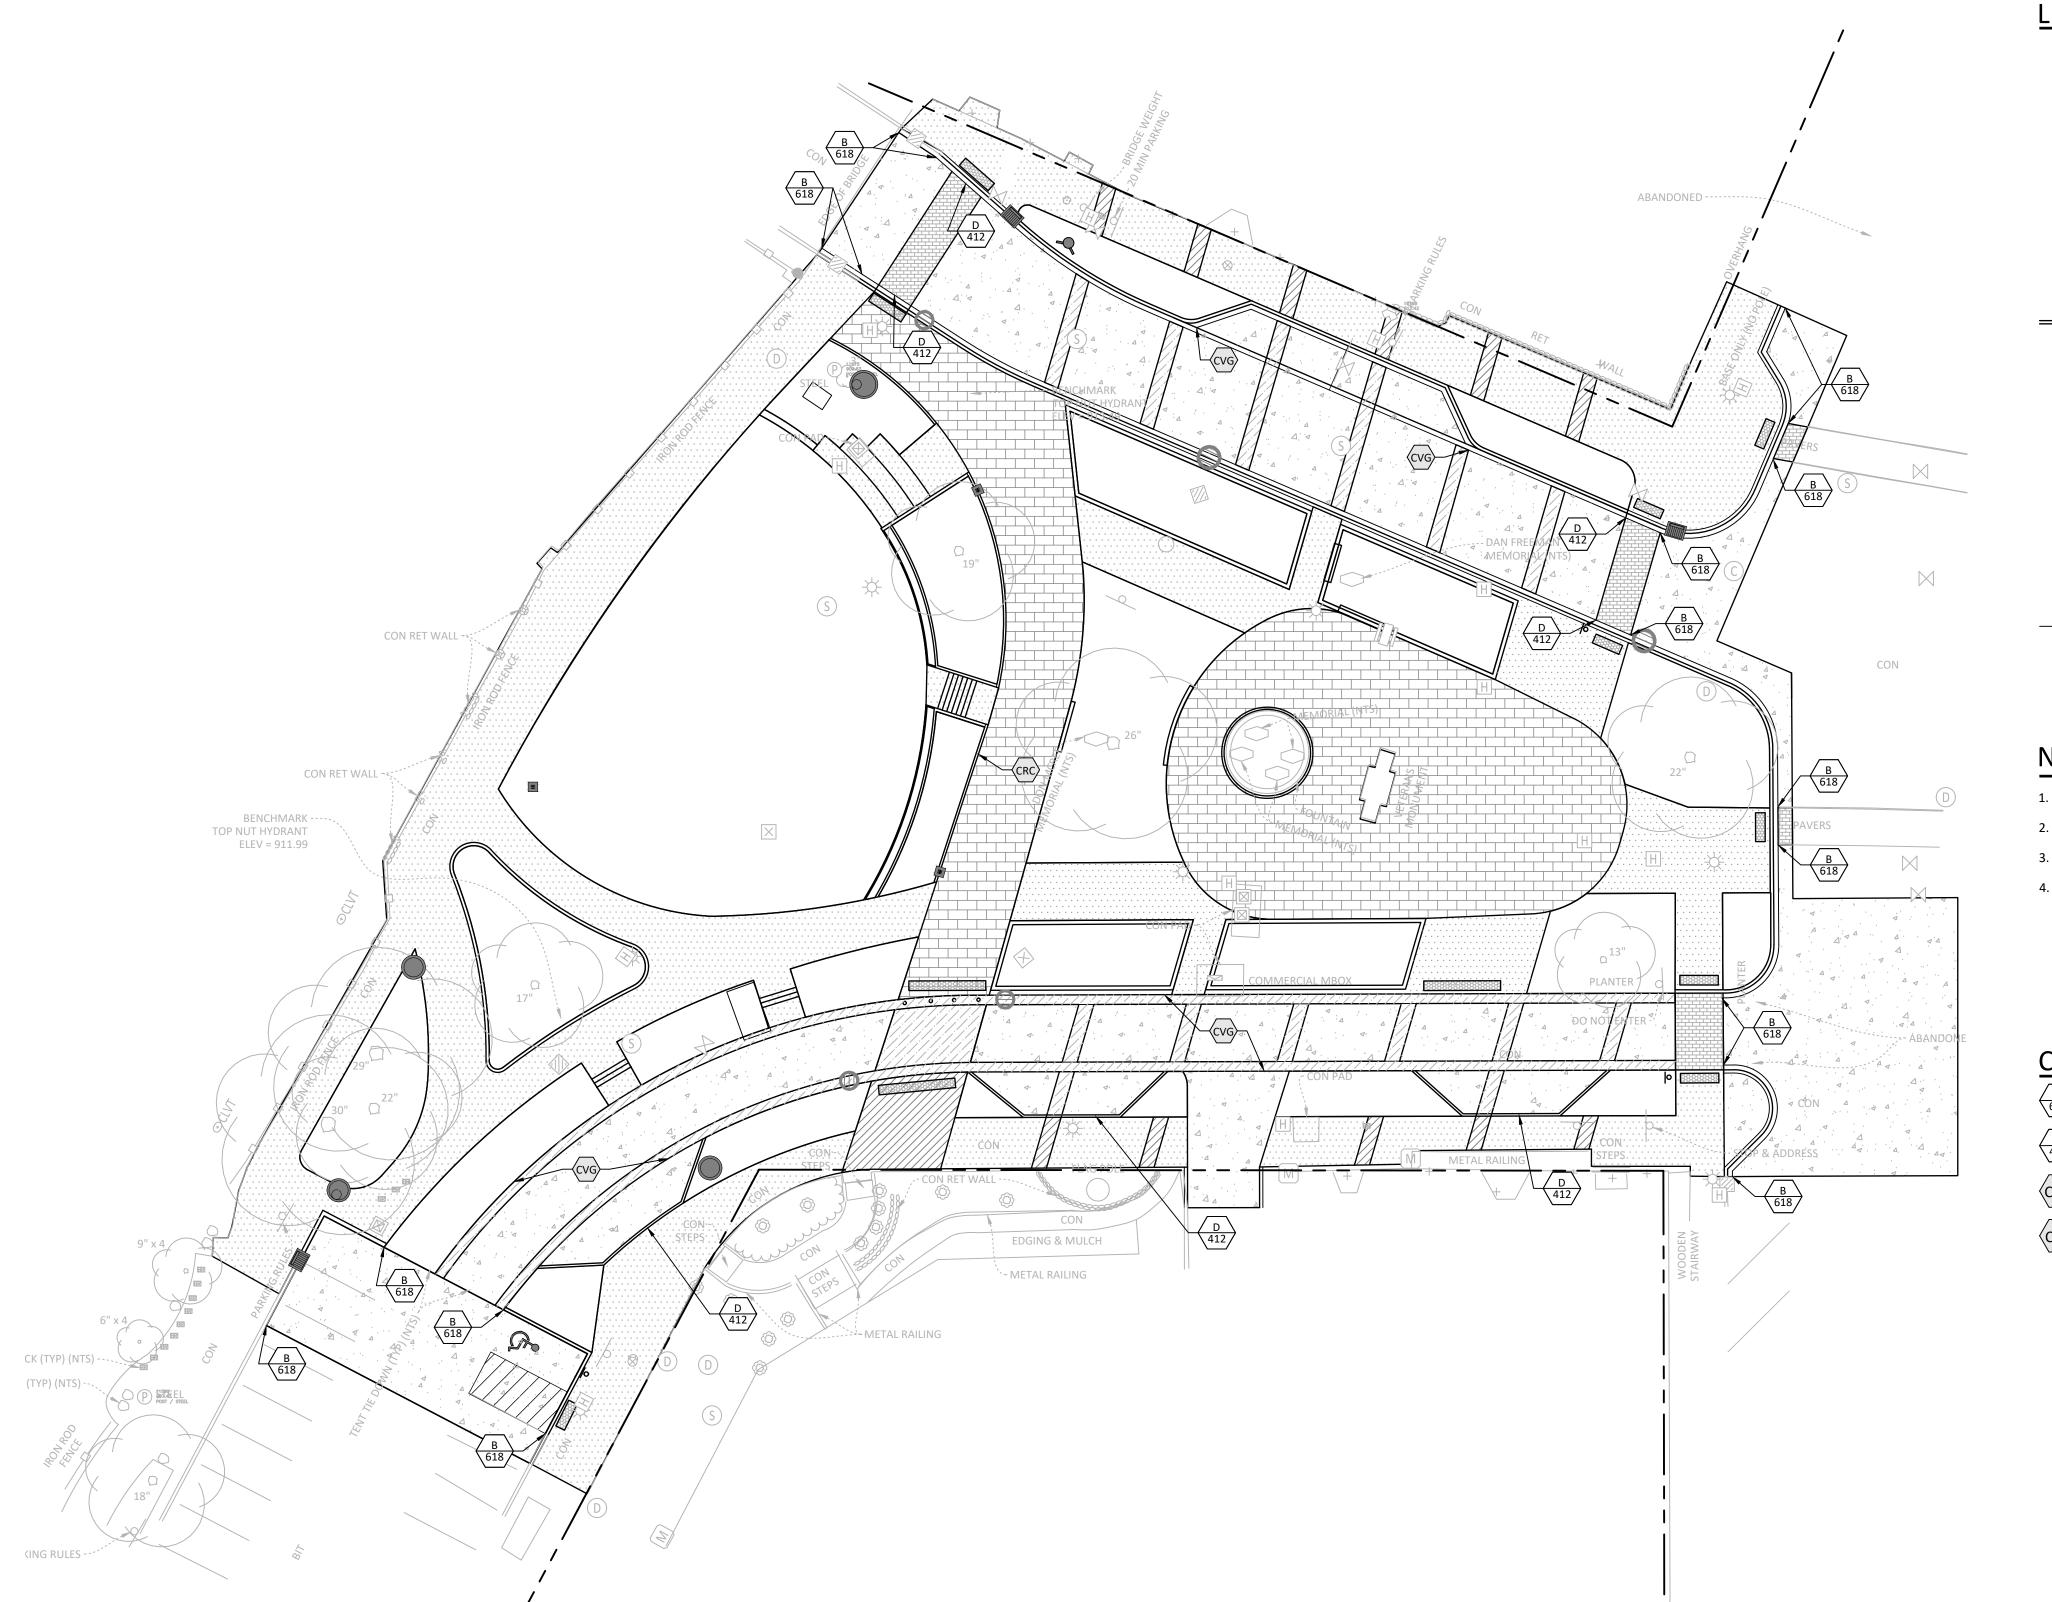

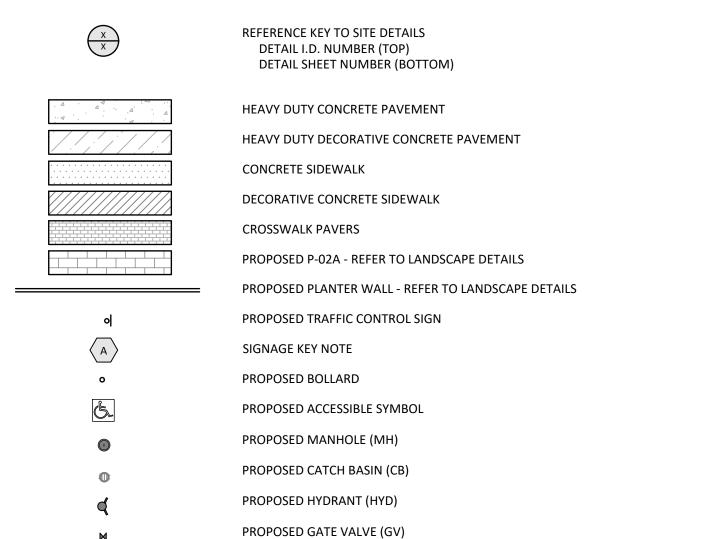

NOTES

- 1. REFER TO SHEET C3.01, GRADING AND DRAINAGE PLAN, FOR GENERAL NOTES.
- 2. CHECK ALL PLAN AND DETAIL DIMENSIONS AND VERIFY SAME BEFORE FIELD LAYOUT.

PROPERTY LINE

- 3. INSTALL TRAFFIC CONTROL SIGNS APPROXIMATELY 18 INCHES BEHIND BACK OF CURB.
- 4. ALL DISTURBED AREAS OUTSIDE THE BUILDING PAD, WHICH ARE NOT DESIGNATED TO BE PAVED OR RECEIVE AGLIME, SHALL RECEIVE AT LEAST 6" OF TOPSOIL.

PROPOSED LIGHT POLE - REFER TO ELECTRICAL PLANS

CURBING KEY NOTES

B-618 CURB AND GUTTER - 6" STANDARD CURB



D-412 CURB AND GUTTER - 4" SURMOUNTABLE CURB

CONCRETE VALLEY GUTTER

CONCRETE RIBBON CURB

CITY OF NORTHFIELD

Minnesota

801 WASHINGTON STREET NORTHFIELD, MINNESOTA 55057 DAVID.BENNETT@CI.NORTHFIELD.MN.US

DAMON FARBER LANDSCAPE ARCHITECTS

310 S 4TH AVE MINNEAPOLIS, MN 55415 RBLASEG@DAMONFARBER.COM 612.332.7522

BOLTON & MENK 7575 GOLDEN VALLEY ROAD

SUITE 200 MINNEAPOLIS, MN 55427 BRADLEY.FISHER@BOLTON-MENK.COM 612.759.7240

NELSON-RUDIE & ASSOCIATES, 9100 49TH AVE N,

MINNEAPOLIS, MN 55428 SARAH.GREFF@NELSONRUDIE.COM 763.367.7600

SCHULER & SHOOK 219 SE MAIN ST

MINNEAPOLIS, MN 55414 PWHITAKER@SCHULERSHOOK.COM 612.339.5958

60% PRICING SET

NORTHFIELD BRIDGE SQUARE


NORTHFIELD, MN


I hereby certify that this document was prepared by me or under my direct supervision and that I am a duly licensed Landscape Architect under the laws of the State of Minnesota.


Tom Whitlock

26292 Registration# Date Signature 09/26/2023 22-184 DF/ Project # AS SHOWN RP/AG/BE/RB Drawn/Checked

> FINISHING PLAN

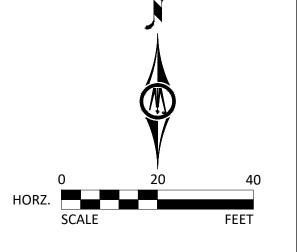

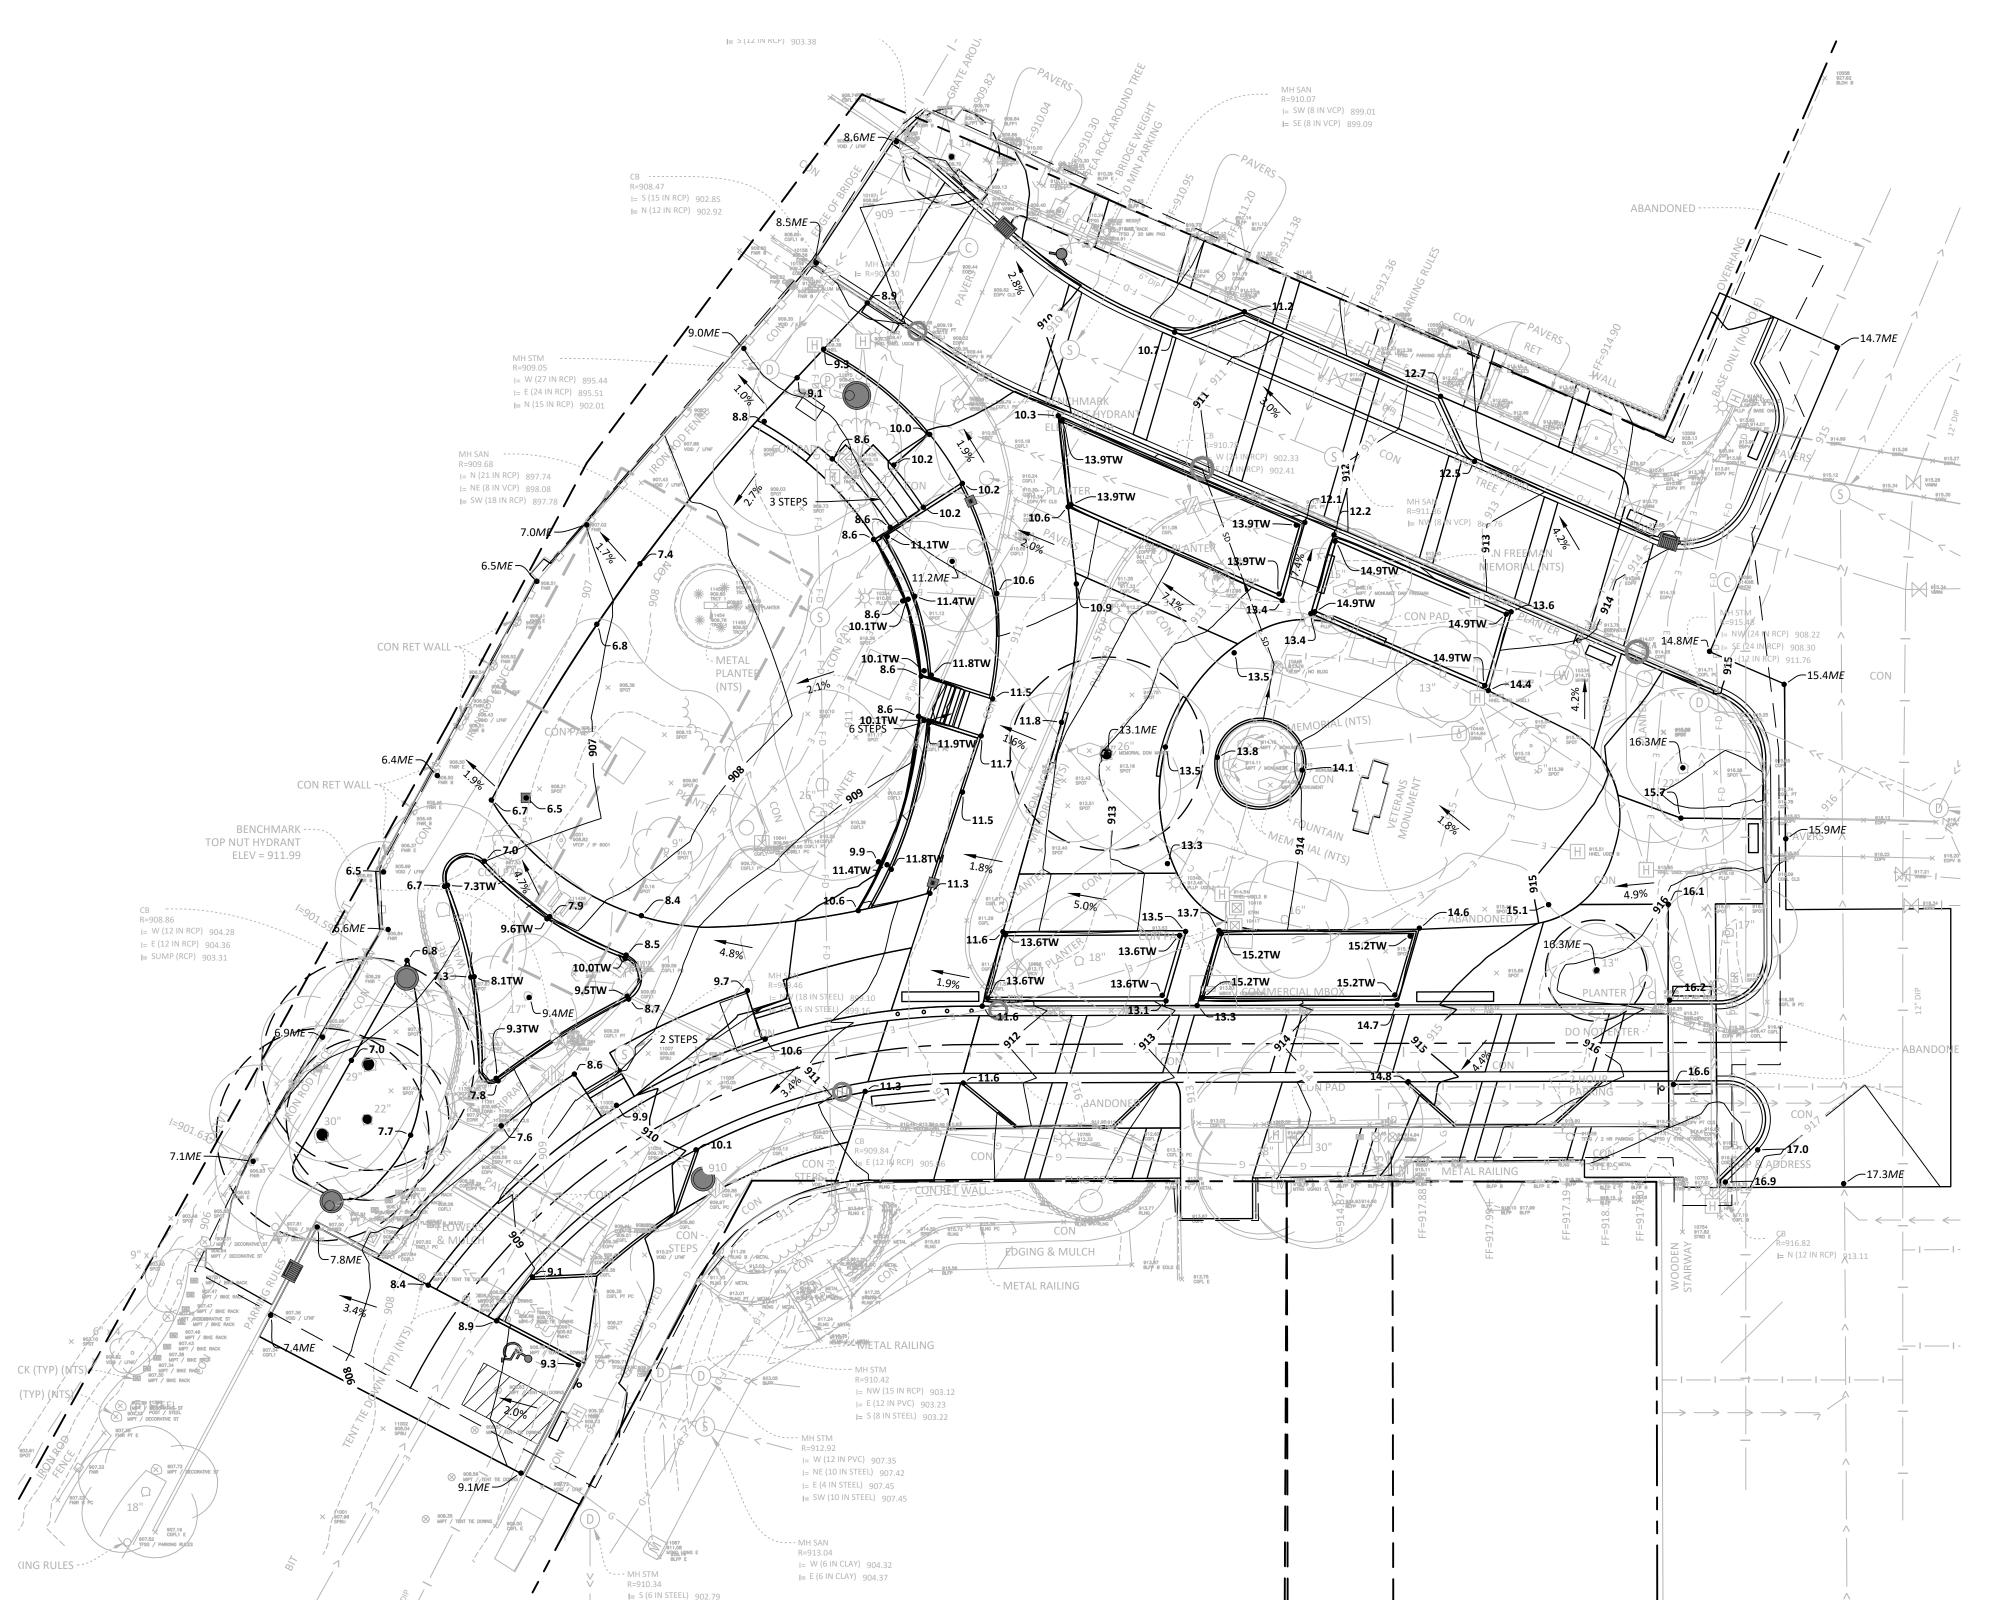

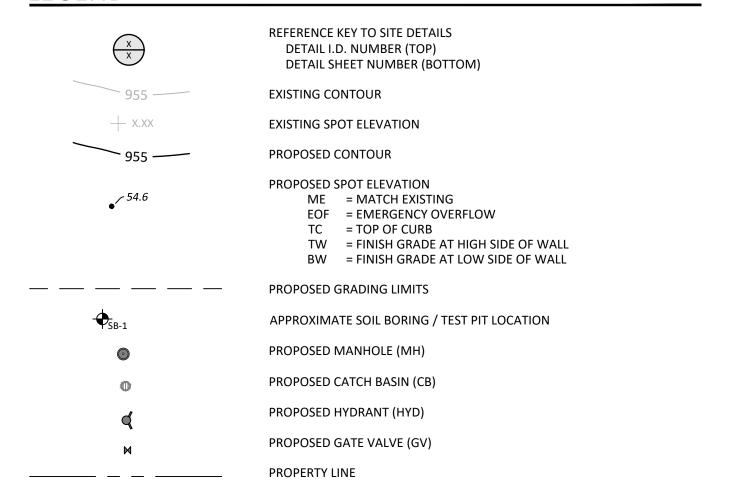


GENERAL NOTES

- 1. ALL CONSTRUCTION SHALL COMPLY WITH APPLICABLE STATE AND LOCAL ORDINANCES.
- 2. THE CONTRACTOR WILL BE RESPONSIBLE FOR AND SHALL PAY FOR ALL CONSTRUCTION STAKING / LAYOUT.
- 3. OBTAIN AND PAY FOR ALL RELATED CONSTRUCTION PERMITS, INCLUDING THE NPDES PERMIT FROM THE MPCA. SUBMIT A COPY OF ALL PERMITS TO THE CITY.
- 4. CONTRACTOR SHALL BE RESPONSIBLE FOR ALL TRAFFIC CONTROL SIGNAGE (CONSTRUCTION ZONES) NECESSARY TO CONSTRUCT PROPOSED IMPROVEMENTS. ALL SIGNAGE LAYOUTS MUST BE DESIGNED BY THE CONTRACTOR AND APPROVED BY LOCAL AUTHORITIES.
- 5. INSTALL CONTROL FENCING AND BARRICADING AS NECESSARY TO PROTECT THE PUBLIC.
- 6. INSPECT SITE AND REVIEW SOIL BORINGS TO DETERMINE EXTENT OF WORK AND NATURE OF MATERIALS TO BE HANDLED.
- 7. REFER TO SPECIFICATIONS FOR DEWATERING REQUIREMENTS.
- 8. CHECK ALL PLAN AND DETAIL DIMENSIONS AND VERIFY SAME BEFORE FIELD LAYOUT.
- 9. REFER TO ARCHITECTURAL PLANS FOR BUILDING AND STOOP DIMENSIONS AND LAYOUT.
- 10. REFER TO THE STORM WATER POLLUTION PREVENTION PLAN (SWPPP) NARRATIVE, SHEET XXX, FOR EROSION CONTROL REQUIREMENTS. SECTION 31 00 00 SHALL BE RESPONSIBLE FOR FULL IMPLEMENTATION OF THE SWPPP.
- 11. MAINTAIN ADJACENT PROPERTY AND PUBLIC STREETS CLEAN FROM CONSTRUCTION CAUSED DIRT AND DEBRIS ON A DAILY BASIS. PROTECT DRAINAGE SYSTEMS FROM SEDIMENTATION AS A RESULT OF CONSTRUCTION RELATED DIRT AND DEBRIS.
- 12. MAINTAIN DUST CONTROL DURING GRADING OPERATIONS.
- 13. ALL EROSION CONTROL METHODS SHALL COMPLY WITH MPCA AND LOCAL REGULATIONS.
- 14. MINIMIZE DISTURBANCE TO SITE AND PROTECT EXISTING SITE FEATURES (INCLUDING TURF AND VEGETATION) WHICH ARE TO REMAIN.
- 15. PROPOSED CONTOURS AND SPOT ELEVATIONS ARE SHOWN TO FINISH GRADE UNLESS OTHERWISE NOTED.
- 16. PROPOSED ELEVATIONS SHOWN TYPICALLY AS 10.1 OR 10 SHALL BE UNDERSTOOD TO MEAN 910.1 OR 910.
- 17. SPOT ELEVATIONS SHOWN IN PARKING LOTS, DRIVES AND ROADS INDICATE GUTTER GRADES, UNLESS NOTED OTHERWISE. SPOT ELEVATIONS WITH LABELS OUTSIDE THE BUILDING PERIMETER INDICATE PROPOSED GRADES OUTSIDE THE BUILDING. SPOT ELEVATIONS WITH LABELS INSIDE THE BUILDING PERIMETER INDICATE PROPOSED FINISH FLOOR ELEVATIONS.
- 18. THE CONTRACTOR WILL BE SOLELY RESPONSIBLE FOR DETERMINING QUANTITIES OF CUT, FILL AND WASTE MATERIALS TO BE HANDLED, AND FOR AMOUNT OF GRADING TO BE DONE IN ORDER TO COMPLETELY PERFORM ALL WORK INDICATED ON THE DRAWINGS. IMPORT SUITABLE MATERIAL AND EXPORT UNSUITABLE / EXCESS / WASTE MATERIAL, AS REQUIRED, AT NO ADDITIONAL COST TO THE OWNER.
- 19. NO FINISHED SLOPES SHALL EXCEED 4' HORIZONTAL TO 1' VERTICAL (4:1), UNLESS OTHERWISE NOTED.
- 20. ALL DISTURBED AREAS OUTSIDE WHICH ARE NOT DESIGNATED TO BE PAVED SHALL RECEIVE AT LEAST 6" OF TOPSOIL AND SHALL BE SODDED OR SEEDED.
- 21. WHERE NEW SOD MEETS EXISTING SOD, CUT A CLEAN, SHARP EDGE TO ALLOW FOR A CONSISTENT, UNIFORM, AND STRAIGHT JOINT BETWEEN NEW SOD AND EXISTING TURFGRASS. JAGGED OR UNEVEN JOINTS WILL NOT BE ACCEPTED. REMOVE TOPSOIL AT THE JOINT BETWEEN NEW SOD AND EXISTING TURFGRASS, AS REQUIRED, TO ALLOW NEW SOD SURFACE TO BE FLUSH WITH EXISTING TURFGRASS SURFACE.
- 22. FAILURE OF TURF DEVELOPMENT: IN THE EVENT THE CONTRACTOR FAILS TO PROVIDE AN ACCEPTABLE TURF, RE-SEED OR RE-SOD ALL APPLICABLE AREAS, AT NO ADDITIONAL COST TO THE OWNER, TO THE SATISFACTION OF THE ENGINEER OR LANDSCAPE ARCHITECT.
- 23. ALL WATERMAIN SHALL BE AWWA C900, CAST IRON OD, DR 18, PVC PIPE INSTALLED IN ACCORDANCE WITH ASTM D2321. ALL WATERMAIN SHALL HAVE MINIMUM 8'-0" BURY (TOP OF PIPE TO FINISH GRADE).

BENCHMARKS (FIELD VERIFY BEFORE USING)

- 1. TOP NUT OF HYDRANT LOCATED EAST OF DIVISION ST & SOUTH OF E 4TH ST. ELEV: 919.22
- TOP NUT OF HYDRANT LOCATED AT THE SW CORNER OF WATER ST S AND E 4TH ST. ELEV: 913.49
- 3. TOP NUT OF HYDRANT LOCATED WEST OF WATER ST S AND NW OF THE UNITED STATES POSTAL SERVICE BUILDING 75' (+/-)
 ELEV: 911.99

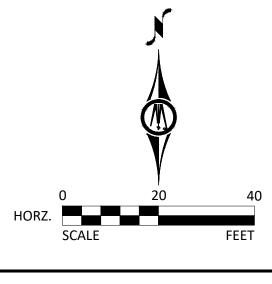

Vorthfield

CITY OF NORTHFIELD

Minnesota

801 WASHINGTON STREET
NORTHFIELD, MINNESOTA 55057
DAVID.BENNETT@CI.NORTHFIELD.MN.US

DAMON FARBER
LANDSCAPE ARCHITECTS

310 S 4TH AVE
MINNEAPOLIS, MN 55415
RBLASEG@DAMONFARBER.COM
612.332.7522

BOLTON & MENK

7575 GOLDEN VALLEY ROAD SUITE 200 MINNEAPOLIS, MN 55427 BRADLEY.FISHER@BOLTON-MENK.COM 612.759.7240

NELSON-RUDIE & ASSOCIATES, 9100 49TH AVE N, MINNEAPOLIS, MN 55428

SARAH.GREFF@NELSONRUDIE.COM 763.367.7600

SCHULER & SHOOK 219 SE MAIN ST

MINNEAPOLIS, MN 55414 PWHITAKER@SCHULERSHOOK.COM 612.339.5958

60% PRICING SET

NORTHFIELD BRIDGE SQUARE

NORTHFIELD, MN

I hereby certify that this document was prepared by me or under my direct supervision and that I am a duly licensed Landscape Architect under the laws of the

State of Minnesota.

Name Tom Whitlock
Registration# 26292

Signature Date

09/26/2023


DF/ Project # 22-184


Scale AS SHOWN
Drawn/Checked RP/AG/BE/RB

REVISION

GRADING AND DRAINAGE PLAN


C3.01

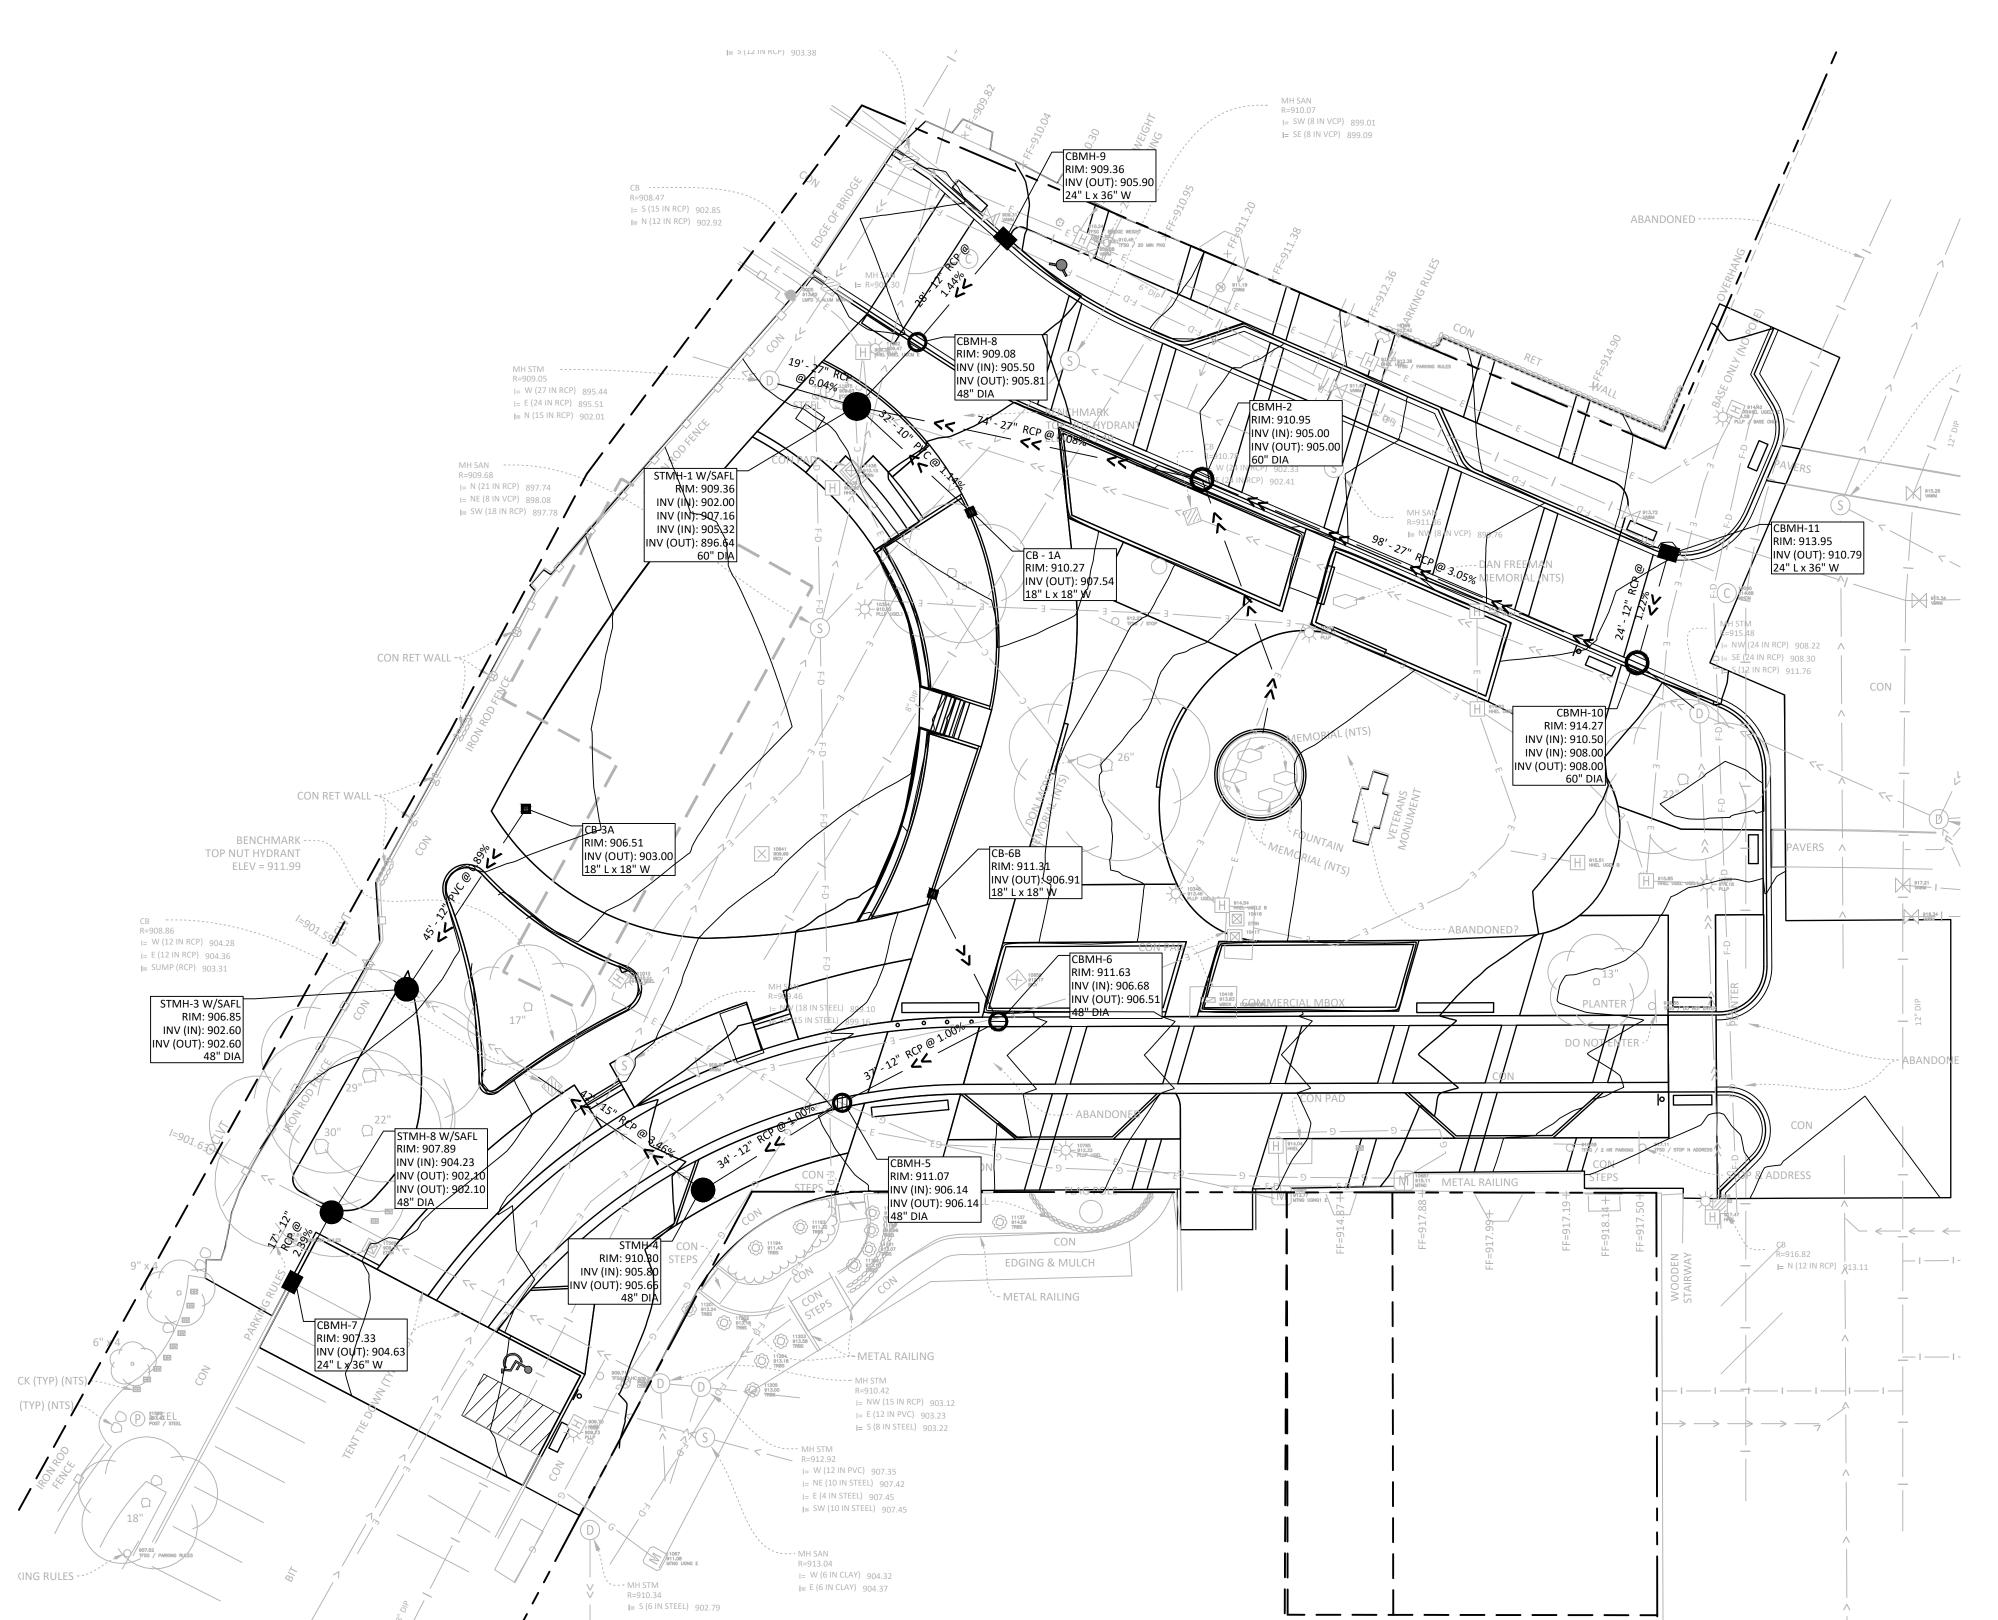

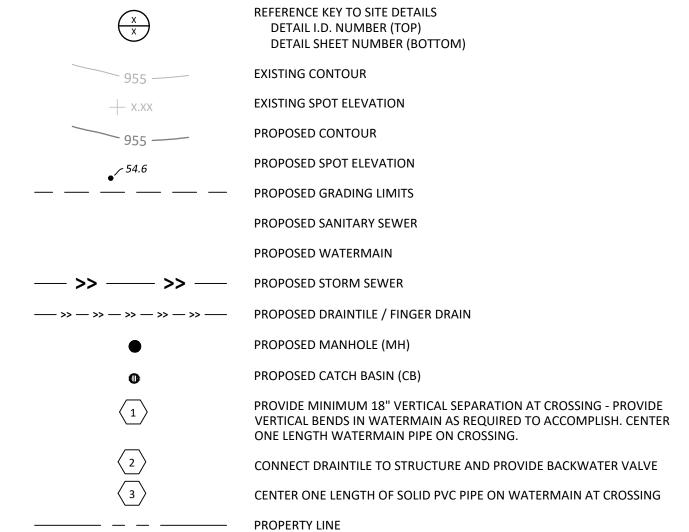

NOT

- 1. REFER TO SHEET C3.01, GRADING AND DRAINAGE PLAN, FOR GENERAL NOTES.
- 2. ALL WATERMAIN SHALL BE AWWA C900, CAST IRON OD, DR 18, PVC PIPE INSTALLED IN ACCORDANCE WITH ASTM D2321. ALL WATERMAIN SHALL HAVE MINIMUM 8'-0" BURY (TOP OF PIPE TO FINISH GRADE).
- 3. ALL SANITARY SEWER PIPE SHALL BE PVC PIPE (ASTM D 3034, SDR 26), UNLESS OTHERWISE NOTED. SANITARY SEWER INSTALLATION SHALL BE IN ACCORDANCE WITH ASTM D2321.
- 4. ALL SANITARY SEWER PIPE CROSSING WATERMAIN, OUTSIDE OF THE PUBLIC RIGHT-OF-WAY, SHALL BE ASTM D2665, SCHEDULE 40 PVC WITH SOLVENT WELD JOINTS.
- 5. ALL STORM SEWER PIPE SHALL BE RCP, CLASS III (MIN.), WITH FLEXIBLE WATERTIGHT JOINTS IN ACCORDANCE WITH ASTM C-361 OR PVC PIPE (ASTM D3034, SDR 35) INSTALLED IN ACCORDANCE WITH ASTM D2321, UNLESS OTHERWISE NOTED.
- 6. ALL STORM SEWER PIPE CROSSING WATERMAIN, OUTSIDE OF THE PUBLIC RIGHT-OF-WAY, SHALL BE ASTM D2665, SCHEDULE 40 PVC WITH SOLVENT WELD JOINTS.
- 7. FLEXIBLE JOINTS AT STORM SEWER PIPE CONNECTIONS TO STRUCTURES:
- a. IN ACCORDANCE WITH MINNESOTA PLUMBING CODE, PROVIDE FLEXIBLE JOINTS AT ALL PIPE CONNECTIONS TO ALL
- STORM SEWER STRUCTURES.
- b. ACCEPTABLE MANUFACTURERS / PRODUCTS:
 i. FERNCO, "CONCRETE MANHOLE ADAPTORS" OR "LARGE-DIAMETER WATERSTOPS"
 :: PRESS SEAL WATERSTOP CROUTING PINCS"
- ii. PRESS-SEAL, WATERSTOP GROUTING RINGS"
- iii. OR APPROVED EQUAL.
- 9. INSTALL WATERMAIN AT LEAST 10 FEET HORIZONTALLY FROM ANY MANHOLE, CATCH BASIN, STORM SEWER, SANITARY SEWER, DRAINTILE, OR OTHER POTENTIAL SOURCE FOR CONTAMINATION PER MN PLUMBING CODE. THIS ISOLATION DISTANCE IS MEASURED FROM THE OUTER EDGE OF THE PIPE TO THE OUTER EDGE OF THE CONTAMINATION SOURCE (OUTER EDGE OF STRUCTURES OR SIMILAR).
- 10. INSTALL MANOLES, CATCH BASINS, STORM SEWER, SANITARY SEWER, DRAINTILE, AND OTHER POTENTIAL SOURCES OF CONTAMINATION AT LEAST 10 FEET HORIZONTALLY FROM ANY WATERMAIN PER MN PLUMBING CODE. THIS ISOLATION DISTANCE IS MEASURED FROM THE OUTER EDGE OF THE PIPE TO THE OUTER EDGE OF THE CONTAMINATION SOURCE (OUTER EDGE OF STRUCTURES OR SIMILAR).
- 11. LOCATE ALL EXISTING UTILITIES. VERIFY LOCATION, SIZE AND INVERT ELEVATION OF ALL EXISTING UTILITIES BEFORE BEGINNING CONSTRUCTION.
- 12. PRIOR TO CONSTRUCTION OF PROPOSED BUILDING UTILITY SERVICES (STORM, SANITARY SEWER, WATERMAIN), VERIFY ALL PROPOSED BUILDING UTILITY SERVICE PIPE SIZES, LOCATIONS AND ELEVATIONS WITH MECHANICAL PLANS. COORDINATE CONSTRUCTION AND CONNECTIONS WITH MECHANICAL CONTRACTOR.
- 13. MAINTAIN DRAINAGE FROM EXISTING BUILDING AT ALL TIMES. PROVIDE TEMPORARY STORM SEWER, INCLUDING, BUT NOT LIMITED TO, CATCH BASINS, MANHOLES, PIPING, AND SIMILAR. DO NOT REMOVE EXISTING STORM SEWER UNTIL TEMPORARY OR PERMANENT STORM SEWER IS INSTALLED AND FUNCTIONAL. COORDINATE ALL REMOVALS WITH APPROPRIATE TRADES (SITE UTILITY CONTRACTOR, MECHANICAL CONTRACTOR, ETC.) AS REQUIRED.
- 14. STAKE LIMITS OF WALKS AND CURBING PRIOR TO INSTALLATION OF GATE VALVES, CATCH BASINS, AND MANHOLES. ADJUST GATE VALVE AND MANHOLE LOCATIONS TO AVOID PLACEMENT OF THESE STRUCTURES IN WALKS AND CURB AND GUTTER. STAKE CURB AND GUTTER ALIGNMENTS TO ALLOW CURB INLET TYPE CATCH BASINS TO PROPERLY ALIGN WITH CURB AND

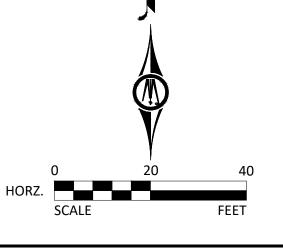

Vorthfield

CITY OF NORTHFIELD

Minnesota

801 WASHINGTON STREET
NORTHFIELD, MINNESOTA 55057
DAVID.BENNETT@CI.NORTHFIELD.MN.US

DAMON FARBER
LANDSCAPE ARCHITECTS

310 S 4TH AVE
MINNEAPOLIS, MN 55415
RBLASEG@DAMONFARBER.COM
612.332.7522

BOLTON & MENK

7575 GOLDEN VALLEY ROAD SUITE 200 MINNEAPOLIS, MN 55427 BRADLEY.FISHER@BOLTON-MENK.COM 612.759.7240

NELSON-RUDIE & ASSOCIATES, 9100 49TH AVE N, MINNEAPOLIS, MN 55428

MINNEAPOLIS, MN 55428 SARAH.GREFF@NELSONRUDIE.COM 763.367.7600

SCHULER & SHOOK

219 SE MAIN ST MINNEAPOLIS, MN 55414 PWHITAKER@SCHULERSHOOK.COM 612.339.5958

60% PRICING SET

NORTHFIELD BRIDGE SQUARE

NORTHFIELD, MN

I hereby certify that this document was prepared by me or under my direct supervision and that I am a duly licensed Landscape Architect under the laws of the

State of Minnesota.

Name Tom Whitlock
Registration# 26292

Signature Date

09/26/2023

DF/ Project # 22-184

Scale AS SHOWN

Drawn/Checked RP/AG/BE/RB

LITILITY PLAN.

UTILITY PLAN -STORM SEWER

C4.01

1 EA HYDRANT -- MH SAN R=915.13 MH STM --R=909.05 |= N (18 IN RCP) 903.36 |= S (15 IN RCP) 903.43 I= W (27 IN RCP) 895.44 |= E (24 IN RCP) 895.5 I= E (8 IN PVC) OUTSIDE DROP 906.45 |= N (15 IN RCP) 902 R=909.68 I= N (21 IN RCP) 893 I= NE (8 IN VCP) 8 |= SW (18 IN RCP) **END INSULATION** 65 SY 4" POLYSTYRENE INSULATION 1 EA 1" CORPORATION STOP — 19 LF 1" TYPE K COPPER PIPE 1 EA 1" CURB STOP & BOX (FIELD VERIFY IRRIGATION 1 EA 1" CORPORATION STOP LOCATION WITH ENGINEER) 72 LF 1" TYPE K COPPER PIPE CUN KEI WALL 1 EA 1" CURB STOP & BOX STA 1+00 1 EA 8" X 8" TEE 2 EA CONNECT TO EXISTING WM _{I=} E (24 IN RCP) 910.71 38 LF 8" DIP WATERMAIN TOP NUT HYDRANT I= NE (12 IN RCP) 910.72 2 EA 8" GV & BOX - 2 EA CONNECT TO EXISTING 910.77 _{I=} E (12 IN RCP) 904.36 SANITARY SEWER |= SUMP (RCP) 903.31 1 EA 8" X 6" TEE 6 LF 6" DIP WATERMAIN 1 EA 6" GV & BOX 1 EA HYDRANT 1=90 A BEGIN INSULATION STA 3+47.13 2 EA CONNECT TO EXISTING WM 1 EA 12" X 8" TEE - ← ← ← ← 12 LF 12" DIP WATERMAIN STA: 1+22.74 2 EA 8" 45° BEND (VERTICAL) 1 EA 8" GV & BOX 1 EA 8" GV & BOX STA 2+37.94 1 EA 8" X 6" TEE STA 1+45.17 1 EA 6" GV & BOX 1 EA 8" 22.5° BEND - 1 EA 8"X6" PVC WYE 1 EA 6" X 1" TAPPED CAP -- METAL RAILING 30 LF 6" PVC SANITARY SERVICE PIPE 11 LF 6" DIP WATERMAIN CONNECT TO EXISTING 4" CIP (INCIDENTAL) |= NW (15 IN RCP) 903.12 1 EA 1" CORPORATION STOP |= E(12 IN PVC) 903.23 9 LF 1" TYPE K COPPER PIPE 1 EA 1" CURB STOP & BOX 935 935 930 930 925 925 MH-2 3+34.98, 10.00' LT R=916.80, BLD=11.52 (MH - 1) I=905.29 15" S 920 920 2+27.94, 10.00' LT I=905.39 8" W R=914.33, BLD=8.11' I=905.28 15" N I=905.82 8" E 915 915 32 SY 4" POLYSTYRENE INSULATION 910 910 EX 12" DIP - CONNECT TO EX WM (FIELD VERIFY) 8" DIP WM 905 905 107' - 8" PVC @ 0.40% 900 900 EX 8" DIP MAINTAIN 18" SEPARATION -CONNECT TO EX WM — FOR SERVICE CROSSING (FIELD VERIFY) 895 895 913.1 913.25 915.0 916.0 915.74 912. 912. 4 4 890

0+75


1+00

- 1 EA CONNECT TO EXISTING WM

10 LF 6" DIP WATERMAIN

1 EA 6" GV & BOX

LEGEND

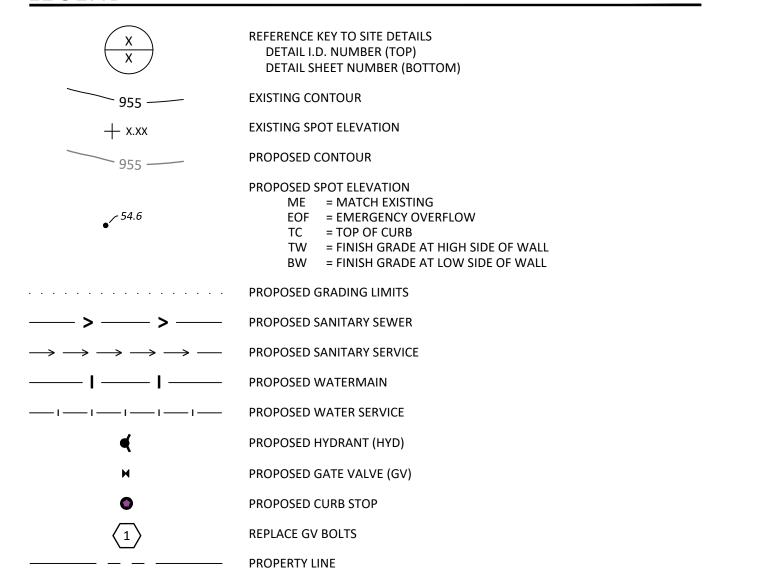


NOTES

3+75

1. REFER TO SHEET C3.01, GRADING AND DRAINAGE PLAN, FOR GENERAL NOTES.

PVC WITH SOLVENT WELD JOINTS.

- 2. ALL WATERMAIN SHALL BE AWWA C900, CAST IRON OD, DR 18, PVC PIPE INSTALLED IN ACCORDANCE WITH ASTM D2321. ALL WATERMAIN SHALL HAVE MINIMUM 8'-0" BURY (TOP OF PIPE TO FINISH GRADE).
- ALL SANITARY SEWER PIPE SHALL BE PVC PIPE (ASTM D 3034, SDR 26), UNLESS OTHERWISE NOTED. SANITARY SEWER INSTALLATION SHALL BE IN ACCORDANCE WITH ASTM D2321.
- 4. ALL SANITARY SEWER PIPE CROSSING WATERMAIN, OUTSIDE OF THE PUBLIC RIGHT-OF-WAY, SHALL BE ASTM D2665, SCHEDULE 40 PVC WITH SOLVENT WELD JOINTS.
- ALL STORM SEWER PIPE SHALL BE RCP, CLASS III (MIN.), WITH FLEXIBLE WATERTIGHT JOINTS IN ACCORDANCE WITH ASTM C-361 OR PVC PIPE (ASTM D3034, SDR 35) INSTALLED IN ACCORDANCE WITH ASTM D2321, UNLESS OTHERWISE NOTED.
- 6. ALL STORM SEWER PIPE CROSSING WATERMAIN, OUTSIDE OF THE PUBLIC RIGHT-OF-WAY, SHALL BE ASTM D2665, SCHEDULE 40
- 7. FLEXIBLE JOINTS AT STORM SEWER PIPE CONNECTIONS TO STRUCTURES:
- IN ACCORDANCE WITH MINNESOTA PLUMBING CODE, PROVIDE FLEXIBLE JOINTS AT ALL PIPE CONNECTIONS TO ALL STORM SEWER STRUCTURES.
- ACCEPTABLE MANUFACTURERS / PRODUCTS:
- i. FERNCO, "CONCRETE MANHOLE ADAPTORS" OR "LARGE-DIAMETER WATERSTOPS"
- ii. PRESS-SEAL, WATERSTOP GROUTING RINGS" iii. OR APPROVED EQUAL.
- INSTALL WATERMAIN AT LEAST 10 FEET HORIZONTALLY FROM ANY MANHOLE, CATCH BASIN, STORM SEWER, SANITARY SEWER, DRAINTILE, OR OTHER POTENTIAL SOURCE FOR CONTAMINATION PER MN PLUMBING CODE. THIS ISOLATION DISTANCE IS
- MEASURED FROM THE OUTER EDGE OF THE PIPE TO THE OUTER EDGE OF THE CONTAMINATION SOURCE (OUTER EDGE OF STRUCTURES OR SIMILAR).
- 10. INSTALL MANOLES, CATCH BASINS, STORM SEWER, SANITARY SEWER, DRAINTILE, AND OTHER POTENTIAL SOURCES OF CONTAMINATION AT LEAST 10 FEET HORIZONTALLY FROM ANY WATERMAIN PER MN PLUMBING CODE. THIS ISOLATION DISTANCE IS MEASURED FROM THE OUTER EDGE OF THE PIPE TO THE OUTER EDGE OF THE CONTAMINATION SOURCE (OUTER EDGE OF STRUCTURES OR SIMILAR).
- 11. LOCATE ALL EXISTING UTILITIES. VERIFY LOCATION, SIZE AND INVERT ELEVATION OF ALL EXISTING UTILITIES BEFORE BEGINNING
- 12. PRIOR TO CONSTRUCTION OF PROPOSED BUILDING UTILITY SERVICES (STORM, SANITARY SEWER, WATERMAIN), VERIFY ALL PROPOSED BUILDING UTILITY SERVICE PIPE SIZES, LOCATIONS AND ELEVATIONS WITH MECHANICAL PLANS. COORDINATE CONSTRUCTION AND CONNECTIONS WITH MECHANICAL CONTRACTOR.
- 13. MAINTAIN DRAINAGE FROM EXISTING BUILDING AT ALL TIMES. PROVIDE TEMPORARY STORM SEWER, INCLUDING, BUT NOT LIMITED TO, CATCH BASINS, MANHOLES, PIPING, AND SIMILAR. DO NOT REMOVE EXISTING STORM SEWER UNTIL TEMPORARY OR PERMANENT STORM SEWER IS INSTALLED AND FUNCTIONAL. COORDINATE ALL REMOVALS WITH APPROPRIATE TRADES (SITE UTILITY CONTRACTOR, MECHANICAL CONTRACTOR, ETC.) AS REQUIRED.
- 14. STAKE LIMITS OF WALKS AND CURBING PRIOR TO INSTALLATION OF GATE VALVES, CATCH BASINS, AND MANHOLES. ADJUST GATE VALVE AND MANHOLE LOCATIONS TO AVOID PLACEMENT OF THESE STRUCTURES IN WALKS AND CURB AND GUTTER. STAKE CURB AND GUTTER ALIGNMENTS TO ALLOW CURB INLET TYPE CATCH BASINS TO PROPERLY ALIGN WITH CURB AND

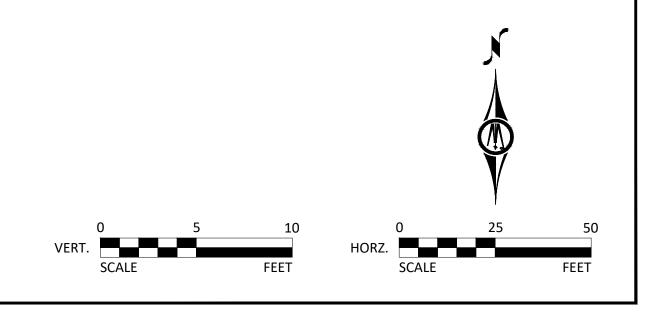

CITY OF NORTHFIELD

Minnesota

801 WASHINGTON STREET NORTHFIELD, MINNESOTA 55057 DAVID.BENNETT@CI.NORTHFIELD.MN.US

DAMON FARBER LANDSCAPE ARCHITECTS

310 S 4TH AVE MINNEAPOLIS, MN 55415 RBLASEG@DAMONFARBER.COM 612.332.7522

BOLTON & MENK 7575 GOLDEN VALLEY ROAD

SUITE 200 MINNEAPOLIS, MN 55427 BRADLEY.FISHER@BOLTON-MENK.COM 612.759.7240

NELSON-RUDIE & ASSOCIATES. 9100 49TH AVE N,

MINNEAPOLIS, MN 55428 SARAH.GREFF@NELSONRUDIE.COM 763.367.7600

SCHULER & SHOOK

219 SE MAIN ST MINNEAPOLIS, MN 55414 PWHITAKER@SCHULERSHOOK.COM 612.339.5958

60% PRICING SET


NORTHFIELD BRIDGE **SQUARE**


NORTHFIELD, MN

I hereby certify that this document was prepared by me or under my direct supervision and that I am a duly licensed Landscape Architect under the laws of the State of Minnesota.

Tom Whitlock 26292 Registration# Date Signature 09/26/2023 22-184 DF/ Project # AS SHOWN RP/AG/BE/RB Drawn/Checked

> UTILITY PLAN -**SANITARY &** WATER

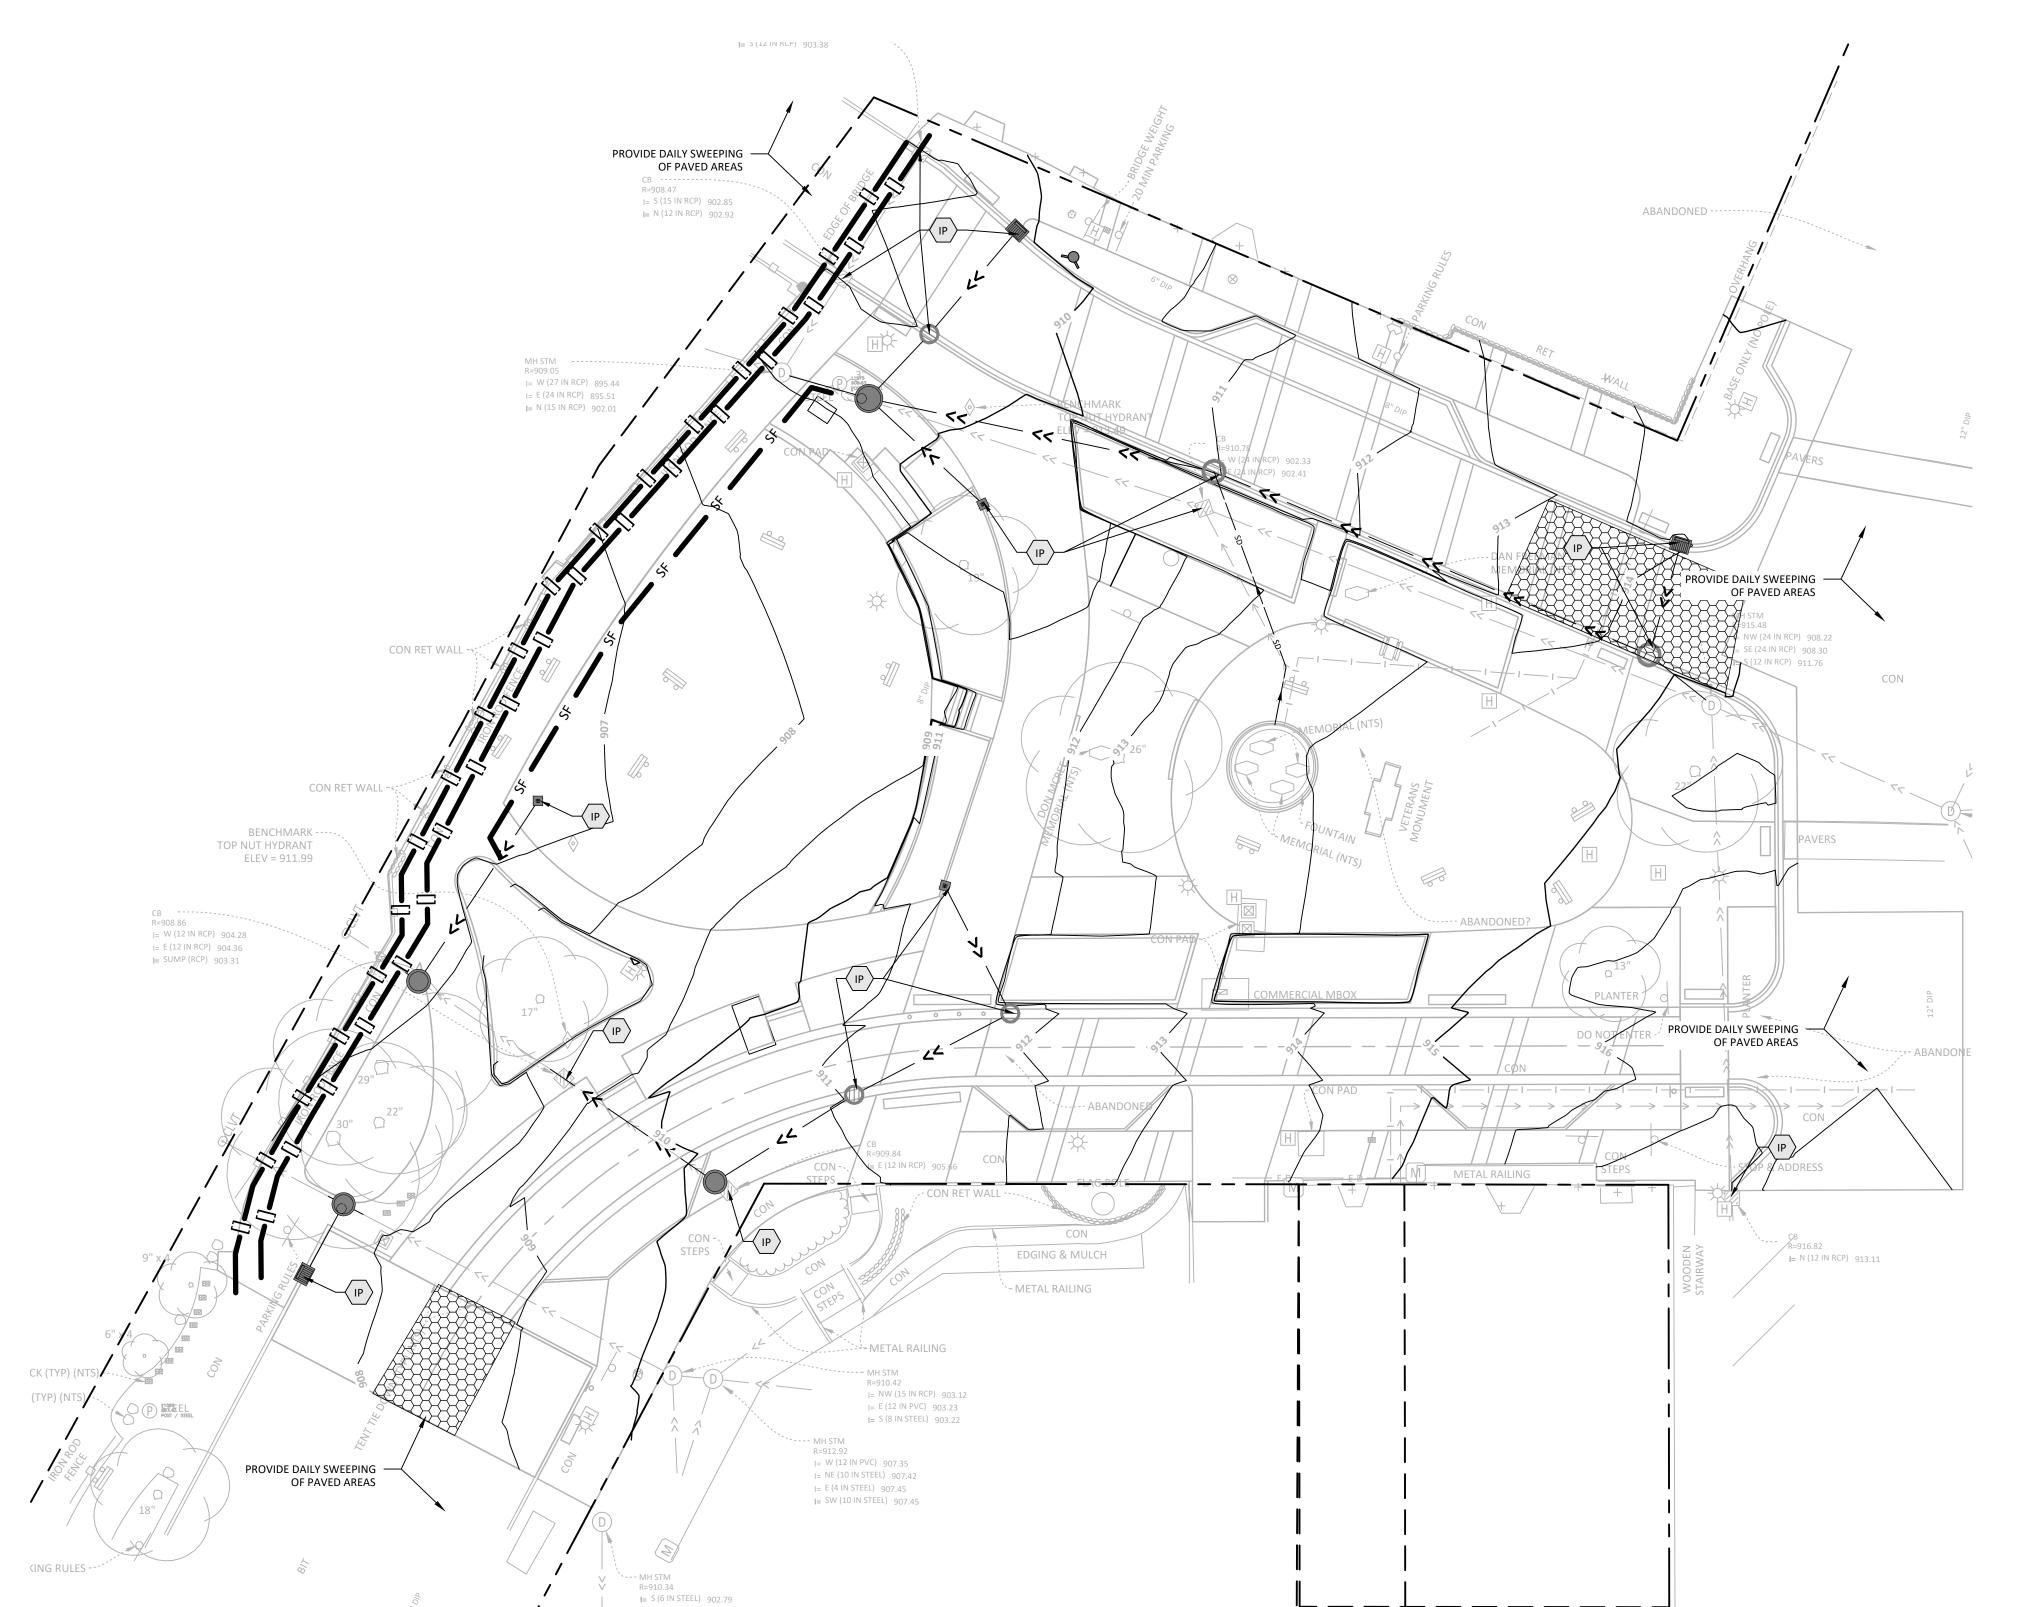

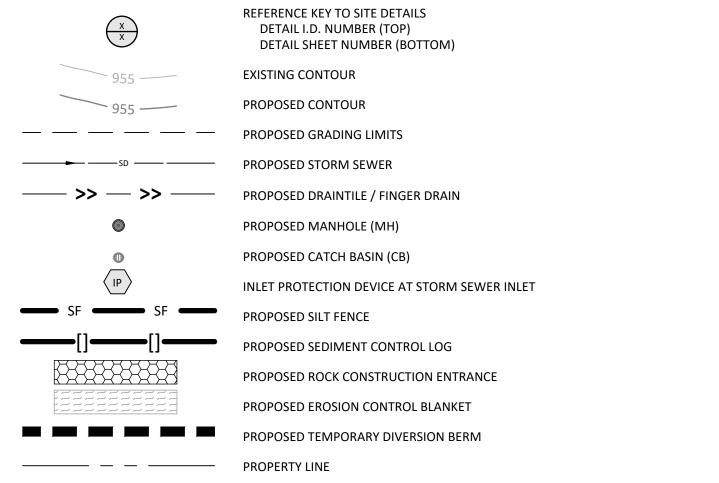

NOTES

- 1. REFER TO SHEET C3.01, GRADING AND DRAINAGE PLAN, FOR GENERAL NOTES.
- 2. REFER TO SWPPP NARRATIVE, SHEET XXX, FOR CONSTRUCTION SEQUENCING AND EROSION CONTROL REQUIREMENTS.
- 3. MAINTAIN ADJACENT PROPERTY AND PUBLIC STREETS CLEAN FROM CONSTRUCTION CAUSED DIRT AND DEBRIS ON A DAILY BASIS. PROTECT DRAINAGE SYSTEMS FROM SEDIMENTATION AS A RESULT OF CONSTRUCTION RELATED DIRT AND DEBRIS.
- 4. MAINTAIN DUST CONTROL DURING GRADING OPERATIONS.
- 5. ALL EROSION CONTROL METHODS SHALL COMPLY WITH MPCA AND OTHER LOCAL REGULATIONS.
- 6. IF EROSION AND SEDIMENT CONTROL MEASURES TAKEN ARE NOT ADEQUATE AND RESULT IN DOWNSTREAM SEDIMENTATION, CLEAN OUT DOWNSTREAM STORM SEWERS AND OTHER CONVEYANCE DEVICES AS NECESSARY, INCLUDING ASSOCIATED RESTORATION.
- 7. INLET PROTECTION DEVICE AT STORM SEWER INLETS. AT THE INLETS TO ALL STORM SEWER STRUCTURES, PROVIDE A PRODUCT FROM THE FOLLOWING LIST OF APPROVED PRODUCTS:
- a. ROAD DRAIN "TOP SLAB", MANUFACTURED BY WIMCO
- b. ROAD DRAIN "CURB & GUTTER", MANUFACTURED BY WIMCO
- c. INFRASAFE "SEDIMENT CONTROL BARRIER", MANUFACTURED BY ROYAL ENVIRONMENTAL SYSTEMS, INC.
- d. INFRASAFE "DEBRIS COLLECTION DEVICE", MANUFACTURED BY ROYAL ENVIRONMENTAL SYSTEMS, INC. e. INFRASAFE "CULVERT INLET PROTECTOR", MANUFACTURED BY ROYAL ENVIRONMENTAL SYSTEMS, INC.
- f. DANDY SACK, MANUFACTURED BY DANDY PRODUCTS, INC.
- g. DANDY CURB SACK, MANUFACTURED BY DANDY PRODUCTS, INC. h. OR APPROVED EQUAL.
- h. OR APPROVED E
- 8. PRIOR TO CONSTRUCTION, DELINEATE TURF AND VEGETATED AREAS NOT TO BE DISTURBED WITH ORANGE SNOW FENCE. DO NOT ALLOW CONSTRUCTION TRAFFIC, EQUIPMENT, OR MATERIALS TO UTILIZE, ACCESS, OR OTHERWISE ENTER THE DELINEATED AREAS. MINIMIZE SOIL COMPACTION AND DISRUPTION OF TOPSOIL IN AREAS OUTSIDE THE CONSTRUCTION LIMITS TO COMPLY WITH THE MN CONSTRUCTION STORMWATER PERMIT.



Minnesota

CITY OF NORTHFIELD

801 WASHINGTON STREET
NORTHFIELD, MINNESOTA 55057
DAVID.BENNETT@CI.NORTHFIELD.MN.US

DAMON FARBER
LANDSCAPE ARCHITECTS
310 S 4TH AVE

MINNEAPOLIS, MN 55415 RBLASEG@DAMONFARBER.COM 612.332.7522

BOLTON & MENK
7575 GOLDEN VALLEY ROAD

SUITE 200
MINNEAPOLIS, MN 55427
BRADLEY.FISHER@BOLTON-MENK.COM
612.759.7240

NELSON-RUDIE & ASSOCIATES, 9100 49TH AVE N, MINNEAPOLIS, MN 55428

MINNEAPOLIS, MN 55428 SARAH.GREFF@NELSONRUDIE.COM 763.367.7600

SCHULER & SHOOK

219 SE MAIN ST MINNEAPOLIS, MN 55414 PWHITAKER@SCHULERSHOOK.COM 612.339.5958

60% PRICING SET

NORTHFIELD BRIDGE SQUARE

NORTHFIELD, MN

I hereby certify that this document was prepared by me or under my direct supervision and that I am a duly licensed Landscape Architect under the laws of the State of Minnesota.

Tom Whitlock

Registration# 26292

Signature Date

09/26/2023

DF/ Project # 22-184


Scale AS SHOWN


Drawn/Checked RP/AG/BE/RB

REVISION ---

SEDIMENT AND EROSION CONTROL PLAN

C5.01

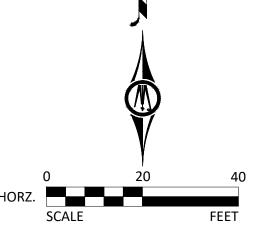

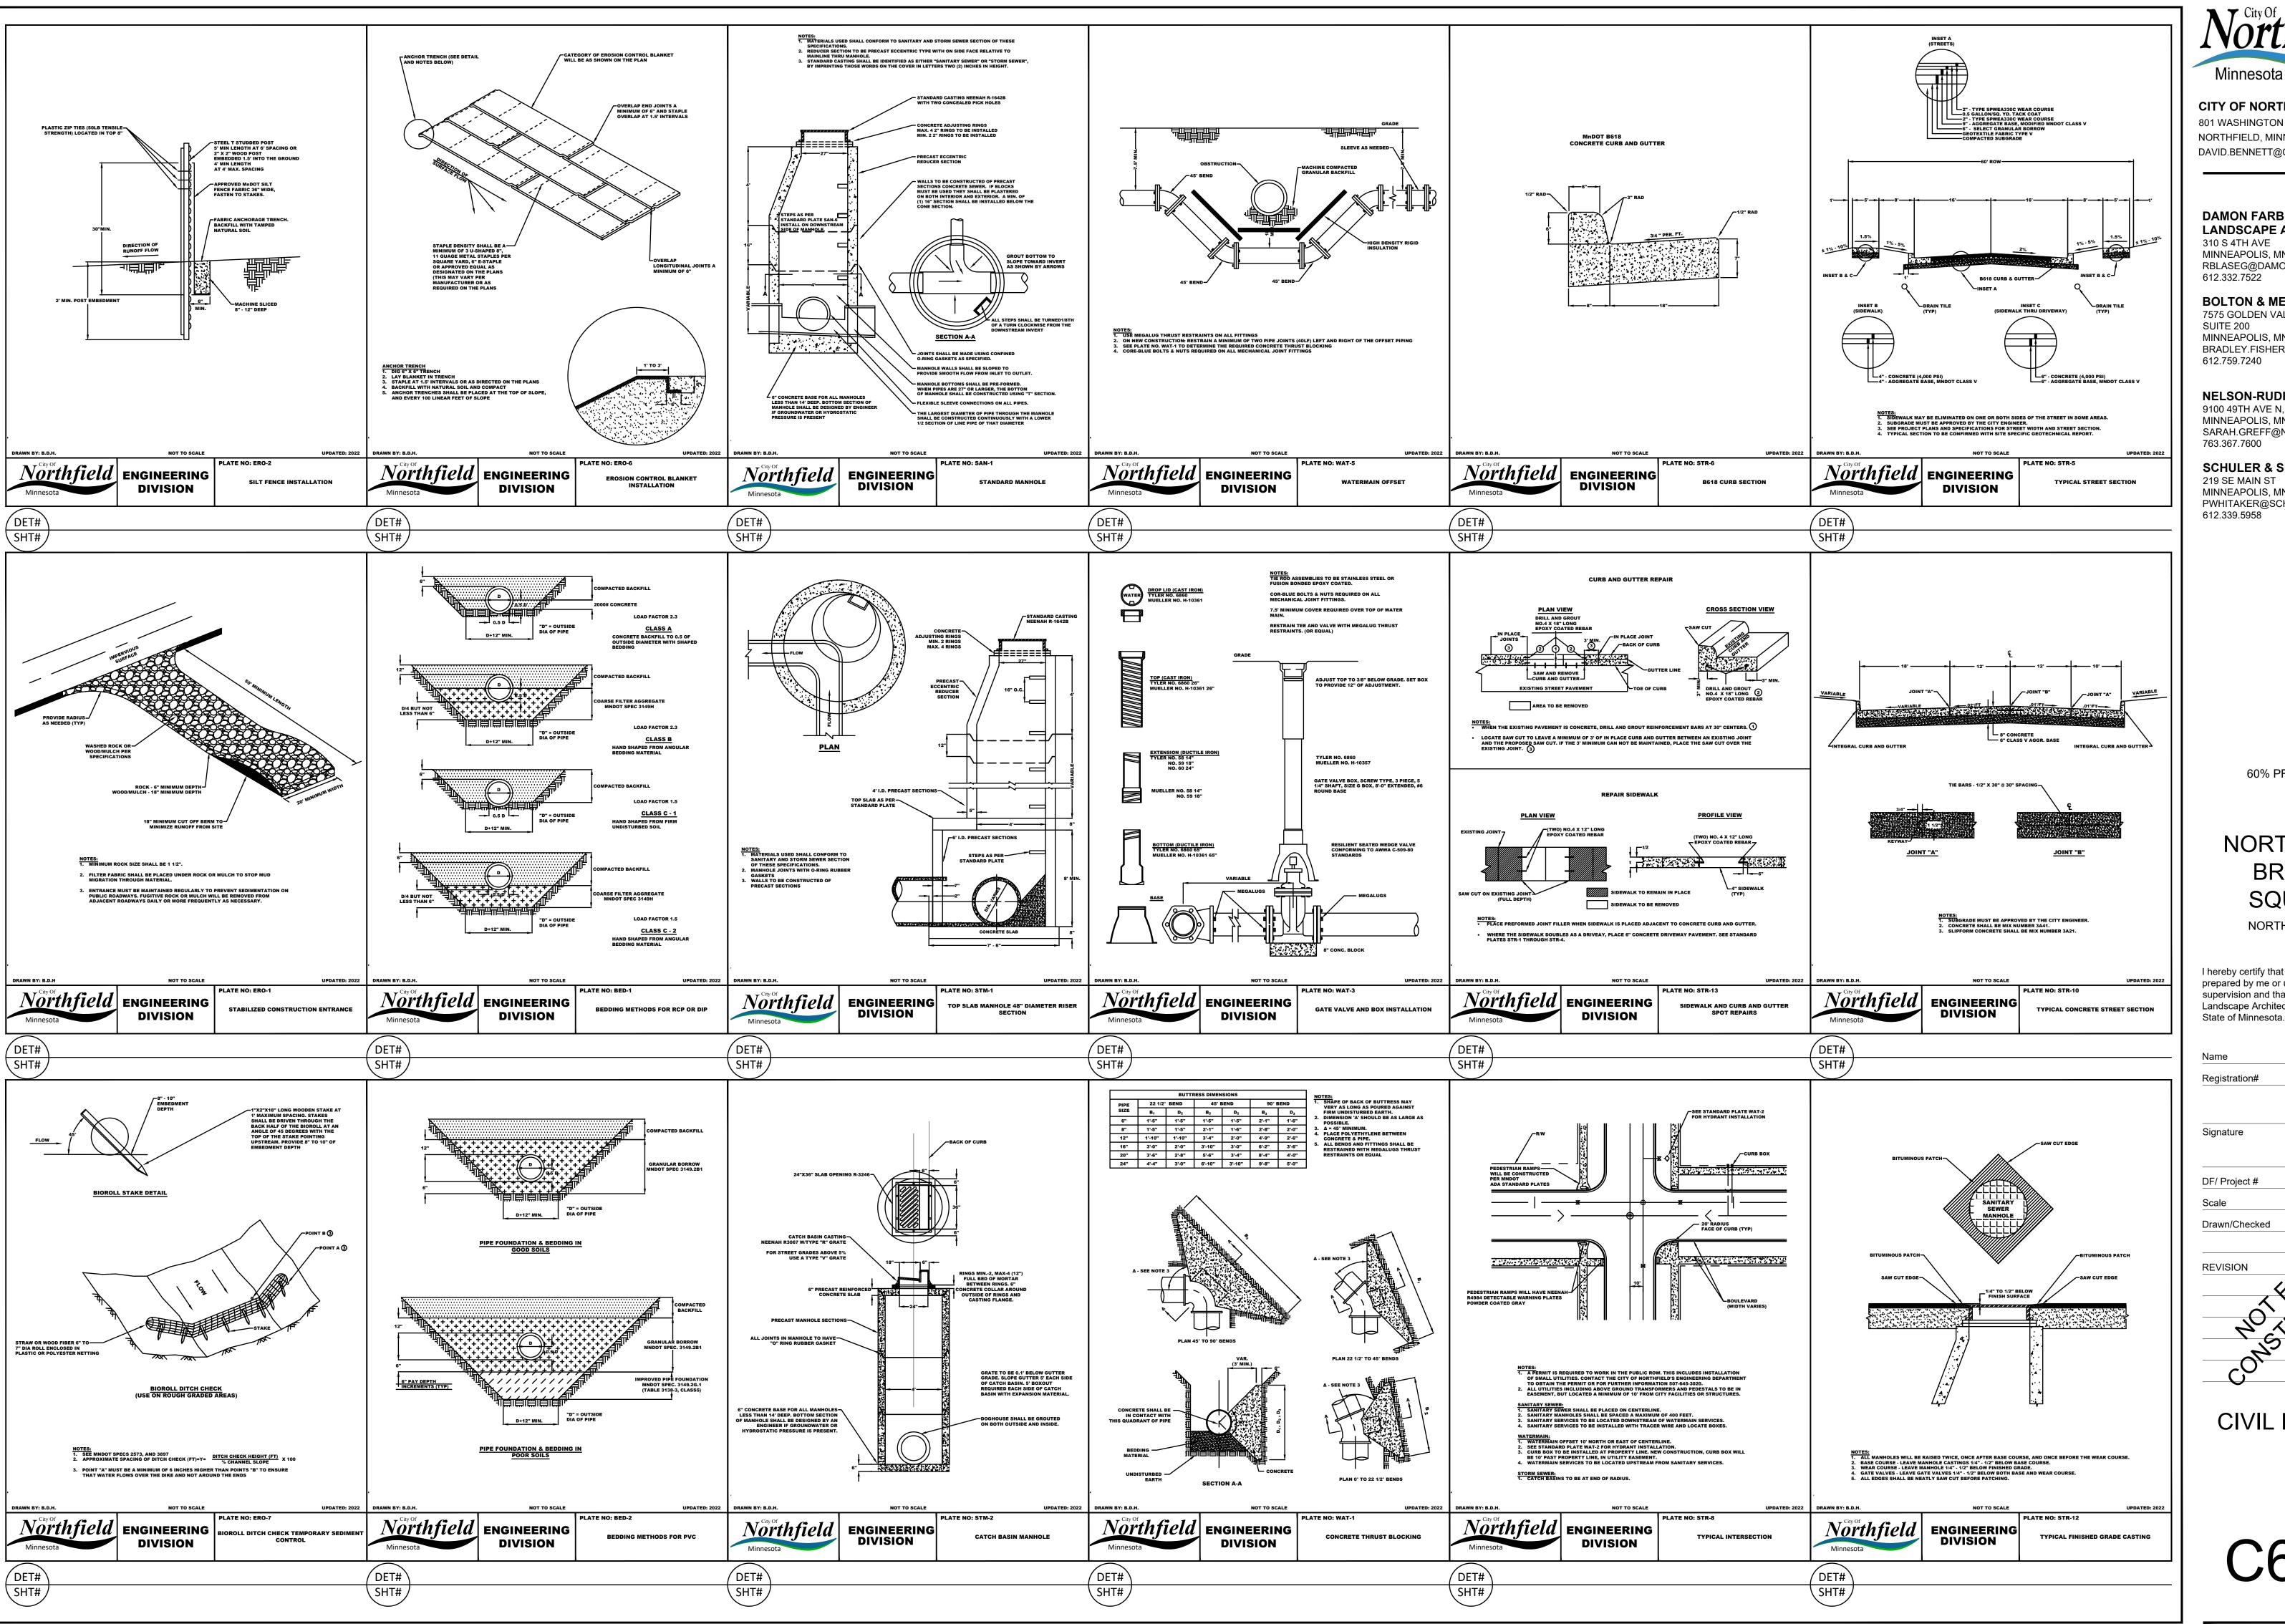

CITY OF NORTHFIELD

Minnesota

801 WASHINGTON STREET NORTHFIELD, MINNESOTA 55057 DAVID.BENNETT@CI.NORTHFIELD.MN.US

DAMON FARBER LANDSCAPE ARCHITECTS

310 S 4TH AVE MINNEAPOLIS. MN 55415 RBLASEG@DAMONFARBER.COM

BOLTON & MENK 7575 GOLDEN VALLEY ROAD

SUITE 200 MINNEAPOLIS, MN 55427 BRADLEY.FISHER@BOLTON-MENK.COM 612.759.7240

NELSON-RUDIE & ASSOCIATES, 9100 49TH AVE N, MINNEAPOLIS, MN 55428 SARAH.GREFF@NELSONRUDIE.COM

763.367.7600 **SCHULER & SHOOK**

219 SE MAIN ST MINNEAPOLIS, MN 55414 PWHITAKER@SCHULERSHOOK.COM 612.339.5958

60% PRICING SET

NORTHFIELD **BRIDGE SQUARE**

NORTHFIELD, MN

I hereby certify that this document was prepared by me or under my direct supervision and that I am a duly licensed Landscape Architect under the laws of the


Tom Whitlock Name 26292 Registration#

09/26/2023 22-184 DF/ Project # AS SHOWN Scale RP/AG/BE/RB Drawn/Checked REVISION

Date

CIVIL DETAILS

C6.01

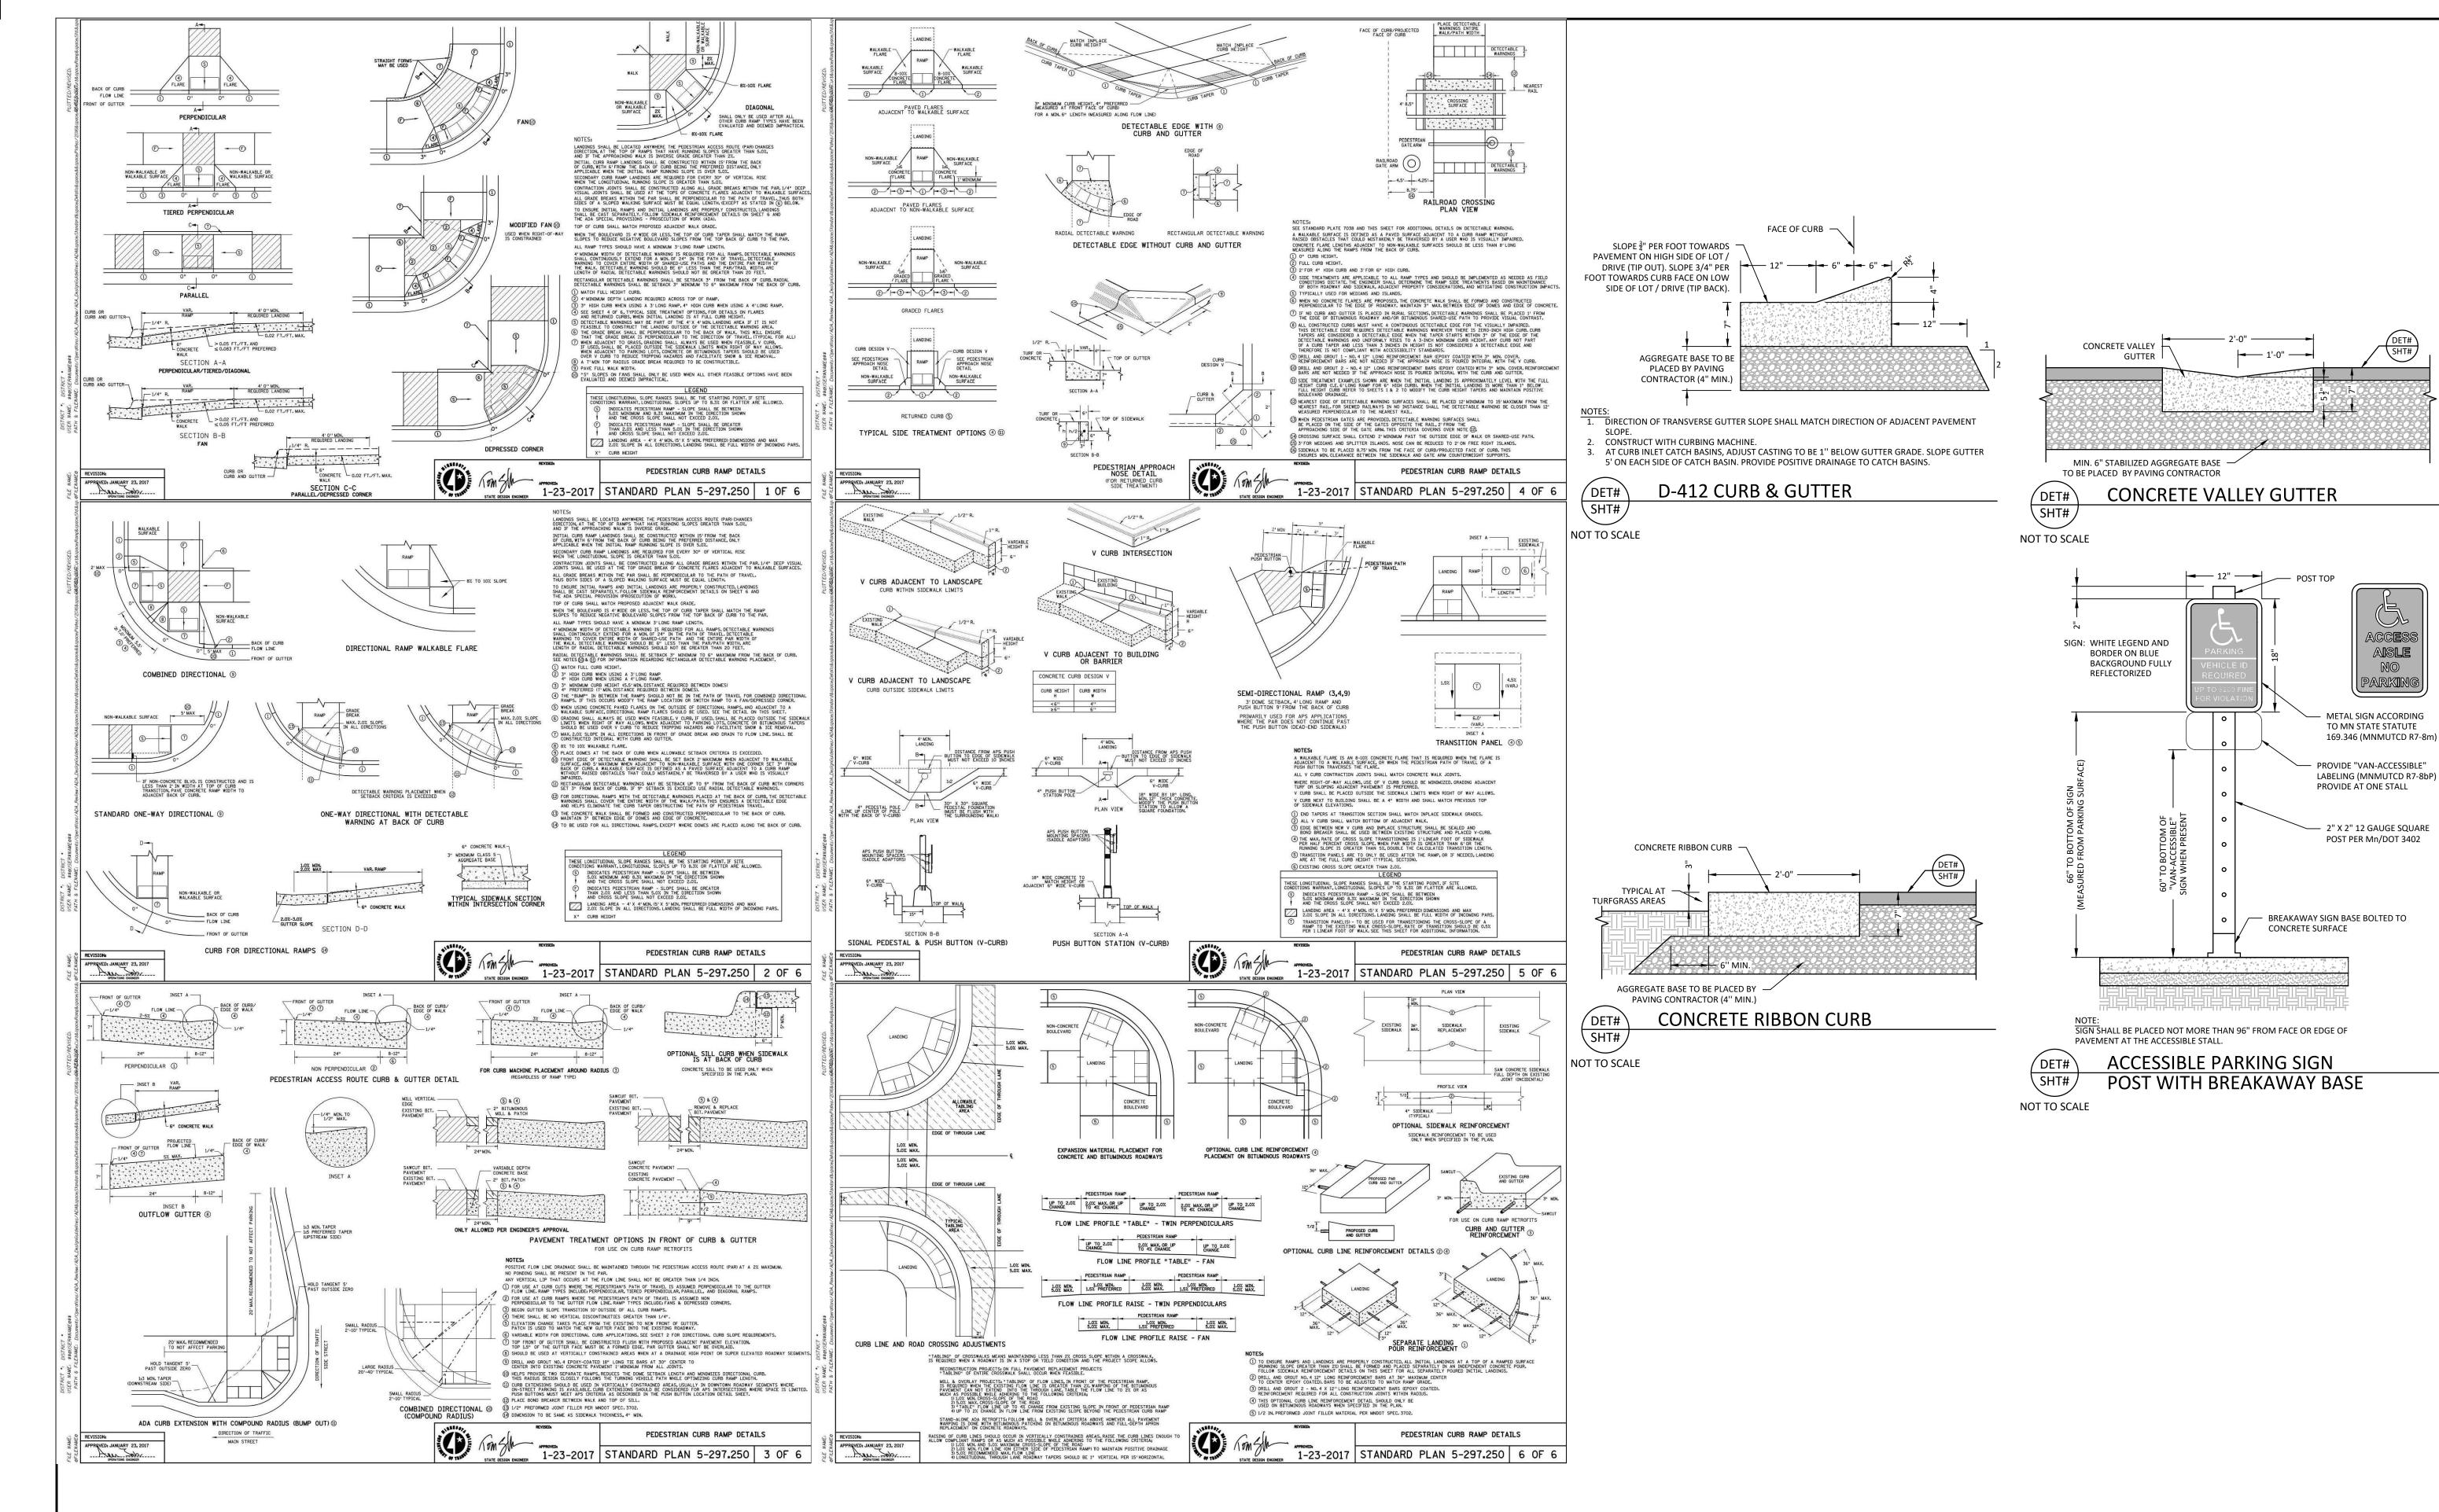

Northfield

Minnesota

CITY OF NORTHFIELD
801 WASHINGTON STREET

NORTHFIELD, MINNESOTA 55057
DAVID.BENNETT@CI.NORTHFIELD.MN.US

DAMON FARBER LANDSCAPE ARCHITECTS 310 S 4TH AVE

MINNEAPOLIS, MN 55415 RBLASEG@DAMONFARBER.COM 612.332.7522

BOLTON & MENK
7575 GOLDEN VALLEY ROAD
SUITE 200
MINNEAPOLIS, MN 55427

BRADLEY.FISHER@BOLTON-MENK.COM 612.759.7240

NELSON-RUDIE & ASSOCIATES,

9100 49TH AVE N, MINNEAPOLIS, MN 55428 SARAH.GREFF@NELSONRUDIE.COM 763.367.7600

SCHULER & SHOOK 219 SE MAIN ST

MINNEAPOLIS, MN 55414 PWHITAKER@SCHULERSHOOK.COM 612.339.5958

60% PRICING SET

NORTHFIELD BRIDGE SQUARE

NORTHFIELD, MN

I hereby certify that this document was prepared by me or under my direct supervision and that I am a duly licensed Landscape Architect under the laws of the

State of Minnesota.

Name Tom Whitlock
Registration# 26292

Signature Date

09/26/2023

DF/ Project # 22-184

Scale AS SHOWN

Drawn/Checked RP/AG/BE/RB

REVISION ---

CIVIL DETAILS

C6.02

GENERAL PROJECT NOTES

CONTRACT DOCUMENTS

- 1. THE WORK SHALL CONFORM TO THE CONTRACT DOCUMENTS.
- 2. THE CONTRACT DOCUMENTS ARE COMPLEMENTARY. READ THE DRAWINGS IN CONJUNCTION WITH THE SPECIFICATIONS AND EXECUTE THE WORK.
- 3. THE WORK IS DEPENDENT ON SEVERAL DISCIPLINES. READ THE DRAWINGS BY CROSS-REFERENCING BETWEEN DISCIPLINES.
- I. REPORT DISCREPANCIES IMMEDIATELY TO THE OWNER'S REPRESENTATIVE FOR DIRECTION BEFORE PROCEEDING WITH THE WORK.

SITE ACCESS & PROTECTION

- 1. STAGING AREA IS WITHIN THE CONSTRUCTION LIMITS LINE. STAGING AREA DOES NOT INCLUDE ACCESS ROUTES TO THE SITE. THE CONSTRUCTION (AND SUBSEQUENT REMOVAL & RESTORATION) OF TEMPORARY STAGING AREAS AND/OR ACCESS ROUTES SHALL BE THE CONTRACTOR'S SOLE RESPONSIBILITY AND EXPENSE.
- 2. CONSTRUCTION RELATED VEHICLES REQUIRED FOR THE WORK EXITING AND/OR ENTERING THE SITE SHALL NOT DEPOSIT DIRT, MUD, OR OTHER DELETERIOUS MATERIALS THAT WOULD PRESENT A NUISANCE OR HAZARD TO THE PUBLIC TRAVELING ON RIGHT OF WAYS. PREVENTION AND CLEANING SHALL BE THE CONTRACTOR'S SOLE RESPONSIBILITY AND EXPENSE.
- 3. NO WORK, EQUIPMENT OR STAGING IS PERMITTED OUTSIDE THE CONSTRUCTION LIMITS UNLESS THE CONTRACTOR HAS APPROVAL FROM AUTHORITIES. COORDINATION PERMITS AND TRAFFIC CONTROL REQUIRED SHALL BE THE CONTRACTOR'S SOLE RESPONSIBILITY AND EXPENSE.
- 4. THE DOCUMENTS DO NOT SPECIFY SAFETY MATERIALS, EQUIPMENT, METHODS OR SEQUENCING TO PROTECT PERSONS AND PROPERTY. IT SHALL BE THE CONTRACTOR'S SOLE RESPONSIBILITY AND EXPENSE TO DIRECT AND IMPLEMENT SAFETY OPERATIONS TO PROTECT PERSONS AND PROPERTY.
- 5. DAMAGE TO EXISTING PAVEMENT OR TURF FROM CONSTRUCTION RELATED TRAFFIC TO AND FROM THE CONSTRUCTION LIMITS SHALL BE REPAIRED TO EQUAL OR BETTER CONDITION AT NO ADDITIONAL COST TO THE OWNER.
- 6. ENTRY SIGNS AND BARRICADES AT SITE ENTRANCES ARE INCIDENTAL TO TRAFFIC CONTROL. REFER TO CIVIL.

QUALITY ASSURANCE

- EXECUTE THE WORK AND SCHEDULE INSPECTIONS IN ACCORDANCE WITH APPLICABLE FEDERAL, STATE, AND LOCAL STANDARDS, LAWS AND REGULATIONS.
- 2. ENSURE SUBCONTRACTORS, MANUFACTURERS AND SUPPLIERS HAVE THE LATEST CONTRACT DOCUMENTS PRIOR TO THE SUBMITTAL OF THEIR SHOP DRAWINGS AND/OR DELEGATED DESIGN DRAWINGS.
- 3. REFER TO THE SPECIFICATIONS FOR REQUIRED SUBMITTALS, INSPECTIONS AND NOTICE TO PROCEED.

EXISTING CONDITIONS SURVEY

- 1. THE DOCUMENTS ARE BASED ON THE FOLLOWING TOPOGRAPHIC AND UTILITY SURVEY:
- SITE BASE CAD FILES SUPPLIED BY THE OWNER.
- 2. UNDERGROUND UTILITY INFORMATION SHOULD BE VERIFIED BY THE CONTRACTOR AND MARKED PRIOR TO CONSTRUCTION.

UTILITIES

- 1. THE LOCATIONS AND SIZES OF EXISTING UTILITIES (IF SHOWN) ARE APPROXIMATE ONLY. IDENTIFY, LOCATE AND PROTECT UNDERGROUND AND OVERHEAD UTILITIES TO REMAIN.
- 2. COORDINATE WITH THE LOCAL UTILITY COMPANIES AND/OR AGENCIES. CALL LOCAL '811' OR REQUEST LOCATES ONLINE NO LESS THAN 48 HOURS PRIOR TO DIGGING TO LOCATE UNDERGROUND UTILITIES OR AS REQUIRED BY LOCAL REGULATIONS.
- 3. BE FULLY RESPONSIBLE FOR THE COST OF DAMAGES WHICH OCCUR AS A RESULT OF A FAILURE TO ACCURATELY LOCATE AND/OR RETAIN UTILITIES TO REMAIN.

LAYOUT

- 1. SURVEY COORDINATE BASIS: SCOTT COUNTY COORDINATES (NAD 88--1996).
- 2. VERIFY THE LOCATION OF EXISTING FEATURES TO REMAIN THAT CONNECT TO NEW WORK, DIMENSIONAL CLEARANCES, SETBACKS AND OFFSETS AND VERTICAL DATUM. REPORT DISCREPANCIES IMMEDIATELY TO THE OWNER'S REPRESENTATIVE FOR DIRECTION BEFORE PROCEEDING WITH THAT PORTION OF THE WORK.
- 3. VERIFY PREVIOUS UNDERLYING TRADEWORK CONFORMS TO THE DOCUMENTS PRIOR TO PROCEEDING WITH OVERLYING TRADEWORK. REPORT DISCREPANCIES IMMEDIATELY TO THE OWNER'S REPRESENTATIVE FOR DIRECTION BEFORE PROCEEDING WITH THAT PORTION OF THE WORK.
- GENERAL CONTRACTOR SHALL RETAIN SURVEY CONTROL FOR LAYOUT OF THE WORKS AND AS-BUILT SURVEYS.
- 5. COORDINATE AND COLLATE SUBCONTRACTOR'S SURVEYS. IT IS THE CONTRACTOR'S RESPONSIBILITY TO FIELD VERIFY EXISTING SITE CONDITIONS AND EVOLVING SITE CONDITIONS PRIOR TO THE START OF SITE WORK. DISCREPANCY AND/OR UNFORESEEN CONDITIONS FOUND SHALL BE BROUGHT TO THE IMMEDIATE ATTENTION OF THE OWNER'S REPRESENTATIVE PRIOR TO STARTING THE SITE WORK. DO NOT BEGIN WORK IN SUCH AFFECTED AREA UNTIL THE DISCREPANCY HAS BEEN RESOLVED.
- 6. ERECT AND INSTALL ALL WORK LEVEL, PLUMB, SQUARE, TRUE, STRAIGHT AND IN PROPER ALIGNMENT.

- 7. DO NOT RELY SOLELY ON SCALE FROM DRAWINGS. USE DIMENSIONS SHOWN AND/OR SUPPLIED CAD DRAWING FILE AND SURVEY INTERPOLATION.
- 3. DIMENSIONS NOTED "CLR" OR "CLEAR" MUST BE STRICTLY MAINTAINED ALLOWING FOR THICKNESS OF FINISHES. FIELD VERIFY PRIOR TO CONSTRUCTION.
- 9. ANGLES ARE 90 DEGREES UNLESS NOTED OTHERWISE.
- 10. CURVES FOR PAVING, BANDS, PATHS, EDGING AND HEADER BOARDS SHALL BE SMOOTH AND CONTINUOUS WITHOUT ABRUPT CHANGES, OBVIOUS TANGENTS OR BENDS.
- 11. PITCH EVENLY BETWEEN SPOT GRADES AND CONTOUR LINES UNLESS GRADE BREAKS, RIDGELINES, SWALES ARE INDICATED OR OTHERWISE NOTED. PAVED AREAS SHALL PITCH AT A MINIMUM OF 1% UNLESS OTHERWISE NOTED ON DRAWINGS. DISCREPANCIES OR CONDITIONS NOT ALLOWING THIS TO OCCUR SHALL BE REPORTED TO THE OWNER'S REPRESENTATIVE FOR RESOLUTIONS PRIOR TO CONTINUING WORK.
- 12. PEDESTRIAN SIDEWALKS AND PAVING SHALL HAVE A CROSS PITCH LESS THAN 2% UNLESS OTHERWISE NOTED TO MEET ADA REQUIREMENTS.
- 13. REQUEST A FIELD REVIEW BY THE LANDSCAPE ARCHITECT OF THE LAYOUT OF ELEMENTS AS SHOWN.

WORK BY OTHERS

- COOPERATE AND COORDINATE WITH OTHER CONTRACTORS
 WORKING CONCURRENTLY SO AS TO NOT VIOLATE EACH OTHER'S
 PERMITS AND TO AVOID DAMAGE TO EACH OTHER'S WORK.
- 2. EACH CONTRACTOR SHALL PROTECT AND MAINTAIN THEIR OWN WORK FOR THE DURATION OF THEIR CONTRACTS.

CODE COMPLIANCE

- 1. WORK SHALL BE IN ACCORDANCE WITH APPLICABLE LAWS, CODES AND REQUIREMENTS OF REGULATORY AGENCIES HAVING JURISDICTION.
- 2. NOTIFY THE OWNER'S REPRESENTATIVE OF DISCREPANCIES BETWEEN THE WORK AND APPLICABLE CODES. DO NOT WORK IN AN AFFECTED AREA UNTIL THE DISCREPANCY HAS BEEN RESOLVED.
- 3. VERIFY CODES IN EFFECT AT THE TIME OF THE NOTICE TO PROCEED AND STAY CURRENT WITH CODE CHANGES WHICH AFFECT THE WORK UNTIL SUBSTANTIAL COMPLETION.
- 4. IT IS THE SOLE RESPONSIBILITY OF THE CONTRACTOR TO OBTAIN AND PAY FOR CONSTRUCTION RELATED PERMITS.

CODES IN EFFECT

- 1. THE FOLLOWING CODES ARE APPLICABLE AND IN EFFECT:
 - MINNESOTA STATE BUILDING CODE 2020
- AMERICAN SOCIETY FOR TESTING AND MATERIALS (ASTM)
- REVISIONS TO THE APPROVED AND PERMITTED DRAWINGS OR DOCUMENTS SHALL BE SUBMITTED TO THE CODE AUTHORITIES FOR REVIEW. NOTIFY THE OWNER'S REPRESENTATIVE OF THE PROCESSING TIME FOR EACH REVISION SUBMITTED FOR PLAN CHECK.

COPYRIGHT AND REPRODUCTION

- 1. THE USE OF REPRODUCTIONS OF THE CONTRACT DOCUMENTS OR ELECTRONIC FILES AS SHOP DRAWING DOCUMENTS BY THE CONTRACTOR IS AT THEIR OWN RISK. THE DESIGN CONSULTANTS ASSUME NO LIABILITY AS A RESULT OF THE USE OF REPRODUCTIONS OF THE CONTRACT DOCUMENTS FOR SHOP DRAWINGS AND/OR DELEGATED DESIGN DRAWINGS.
- 2. THE ENTIRE CONTRACT DOCUMENT PACKAGE HEREIN IS THE ORIGINAL AND UNPUBLISHED PROPERTY OF THE OWNER AND MAY NOT BE DUPLICATED, USED OR DISCLOSED WITHOUT THE PRIOR EXPLICIT WRITTEN CONSENT.
- 3. THE USE OF DIGITAL DESIGN FILES SHALL REQUIRE THE CONTRACTOR TO AGREE TO PRIME CONSULTANT'S LICENSE CONDITIONS BEFORE USE.


CONSTRUCTION LOADS. DAMAGES & REPAIRS


- 1. THE CONTRACTOR IS SOLELY RESPONSIBLE FOR SLOPE STABILITY AND DE-WATERING DURING THE WORKS UNLESS UNKNOWN CONDITIONS ARE ENCOUNTERED.
- 2. THE CONTRACTOR IS SOLELY RESPONSIBLE FOR PROTECTING THE WORKS FROM CONSTRUCTION LOADS AND DAMAGES TO EXISTING STRUCTURES TO REMAIN, NEW STRUCTURES AND NEW PAVEMENTS DURING THE WORKS.
- 3. BE FULLY RESPONSIBLE FOR THE COST OF DAMAGES WHICH OCCUR AS A RESULT OF A FAILURE TO MITIGATE CONSTRUCTION LOADS AND/OR PROTECT THE WORKS FROM CONSTRUCTION RELATED IMPACTS. REPAIRS SHALL BE TO A NEW OR BETTER CONDITION COMPARED TO THE EXISTING CONDITION BEFORE DAMAGE, AND AS APPROVED BY THE OWNER'S REPRESENTATIVE.
- 4. CONFIRM ON-STRUCTURE UNIFORM AND POINT LOAD LIMITS WITH ENGINEER PRIOR TO IMPORTING AND HANDLING LANDSCAPE MATERIALS OVER VAULTS, AND/OR TUNNELS, INCLUDING UTILITY STRUCTURES, AND FLOOD CONTROL STRUCTURES.

CONSTRUCTION WASTE MANAGEMENT

1. REMOVE FROM THE SITE EXCESS MATERIAL AND/OR DEBRIS.
DISPOSAL OF MATERIALS IS THE RESPONSIBILITY OF THE
CONTRACTOR. EXCESS MATERIAL AND/OR DEBRIS UNABLE TO BE
RECYCLED OR REUSED SHALL BE DISPOSED OF OFF THE PROJECT
SITE IN A PERMITTED LANDFILL.

SYMBOLS

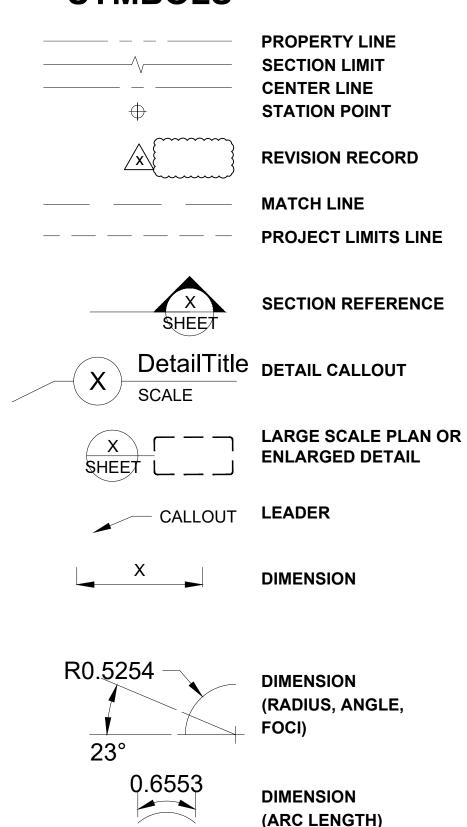

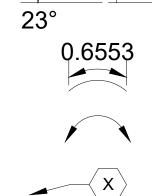

ALIGN

KEY NOTE

ABBREVIATIONS

ABBRE	VIATIONS	РВ	PULL BOX
APPROX	APPROXIMATE	PC	POINT OF CURVE
AVG	AVERAGE	PCC	PRECAST CONCRETE
BLDG	BUILDING	PERF PERP	PERFORATED PERPENDICULAR
BM	BENCHMARK	pH	ACID/ALKALINE SCALE
BOS	BOTTOM OF STAIR	PH	PHASE
ВОТ	BOTTOM	PI	POINT OF INTERSECTION
BOC	BOTTOM OF CURB	PKG	PACKAGE
BOW	BOTTOM OF WALK	PL PLBG	PROPERTY LINE PLUMBING
С	CHILLER	PRCST	PRECAST
CAL	CALIPER	PREFAB	PREFABRICATE
СВ	CATCH BASIN	PROV	PROVISIONAL
CIP	CAST-IN-PLACE	PVC	POLYVINYL CHLORIDE
CJ CL	CONTROL JOINT CENTER LINE	PWR	POWER
CLR	CLEAR	QTR	QUARTER
CLL	CONTRACT LIMIT LINE	QTY	QUANTITY
CMU	CONCRETE MASONRY UNIT		
CONC	CONCRETE	R	RADIUS
CTR	CENTER	RCP RECIRC	REINFORCED CONCRETE PIPE RECIRCULATE
DAT	DATUM	RECPT	RECEPTACLE
DEG	DEGREE	REINF	REINFORCE
DIA	DIAMETER	REQD	REQUIRED
DIM	DIMENSION	REV	REVISION
DIST DIV	DISTANCE DIVISION	RLG ROW	RAILING RIGHT OF WAY
DWG	DRAWING	KOW	Monitor WAT
		S	SOUTH
E	EAST	SALV	SALVAGE
EA	EACH EXPANSION JOINT	SEG	SEGMENT
EJ EL	EXPANSION JOINT ELEVATION	SHT SIM	SHEET SIMILAR
EP	EDGE OF PAVEMENT	SPEC	SPECIFICATION
EQ	EQUAL	SQ	SQUARE
EQSP	EQUAL SPACING	SSD	SUBSOIL DRAIN
EQUIV	EQUIVALENT	SST	STAINLESS STEEL
EX	EXISTING	STA	STATION
F	FAHRENHEIT	STD SUCT	STANDARD SUCTION
FC	FOOTCANDLE	0001	
FFE	FINISH FLOOR ELEVATION	Т	TRANSFORMER
FF&E	FURNITURE, FIXTURE, AND EQUIPMENT	TAN	TANGENT
FG	FINISHED GRADE FACE OF CURB	TBD	TO BE DETERMINED
FOC FOW	FACE OF WALL	TB-XX TD	TEST BORING TRENCH DRAIN
FV	FIELD VERIFY	TEMP	TEMPORARY
		THK	THICKNESS
GALV	GALVANIZED	THRU	THROUGH
GDR	GUARDRAIL	TO_	TOP OF _
н	HIGH	TOC TOL	TOP OF CURB TOLERANCE
HB	HOSE BIBB	TOS	TOP OF SLOPE
HDPE	HIGH DENSITY POLYETHYLENE	TOW	TOP OF WALL
нн	HAND HOLE	TR	TRASH
HDR	HANDRAIL	TS	TOP OF STAIR
HORIZ HT	HORIZONTAL HEIGHT	TYP	TYPICAL
HV	HIGH VOLTAGE	UGND	UNDERGROUND
		UNIF	UNIFORM
ID	INSIDE DIMENSION	UP	UTILITY POLE
INV.EL	INVERT ELEVATION	UV	ULTRAVIOLET
KW	KILOWATT	VAR	VADIES
	REOWATT	VERT	VARIES VERTICAL
LDPE	LOW DENSITY POLYETHYLENE	VRFY	VERIFY
LED	LIGHT EMITTING DIODE		
LF	LINEAR FEET	W	WEST
LPT LTD	LOW POINT LIMITED	W/	WITH
LV	LOW VOLTAGE	W/O WL	WITHOUT WATERLINE
LW	LOW WATER	WLD	WELDED
		WT.EL	WATER ELEVATION
MAX	MAXIMUM		
MFR.REC MH	MANUFACTURER'S RECOMMENDATIONS MANHOLE	XFMR	TRANSFORMER
MID	MIDDLE	YR	YEAR
MIN	MINIMUM		-
		@	AT
N	NORTH NOT ARRUS	&	AND
NA NIC	NOT APPLICABLE NOT IN CONTRACT	-/+	DIMENSION TOLERANCE
NO NO	NUMBER	IJ	ISOLATION JOINT
NOM	NOMINAL	HW	HIGH WATER
NTS	NOT TO SCALE	NP	NORMAL POOL
00	ON CENTER	GB	GRADE BREAK
OC OD	ON CENTER OUTSIDE DIAMETER		
ОН	OVERHANG		



CITY OF NORTHFIELD

801 WASHINGTON STREET

NORTHFIELD, MINNESOTA 55057

Minnesota

DAVID.BENNETT@CI.NORTHFIELD.MN.US

DAMON FARBER
LANDSCAPE ARCHITECTS
310 S 4TH AVE
MINNEAPOLIS, MN 55415
RBLASEG@DAMONFARBER.COM

BOLTON & MENK
7575 GOLDEN VALLEY ROAD
SUITE 200
MINNEAPOLIS, MN 55427
BRADLEY.FISHER@BOLTON-MENK.COM
612.759.7240

NELSON-RUDIE & ASSOCIATES, 9100 49TH AVE N, MINNEAPOLIS, MN 55428 SARAH.GREFF@NELSONRUDIE.COM 763.367.7600

SCHULER & SHOOK
219 SE MAIN ST
MINNEAPOLIS, MN 55414
PWHITAKER@SCHULERSHOOK.COM
612.339.5958

60% PRICING SET

NORTHFIELD BRIDGE SQUARE

NORTHFIELD, MN

I hereby certify that this document was prepared by me or under my direct supervision and that I am a duly licensed Landscape Architect under the laws of the State of Minnesota.

Tom Whitlock

RP/AG/BE/RB

 Registration#
 26292

 Signature
 Date

 09/26/2023

 DF/ Project #
 22-184

 Scale
 AS SHOWN

Drawn/Checked

REVISION

GENERAL NOTES, ABBREVIATIONS & SYMBOLS

EXISTING CONDITIONS & SITE REMOVAL NOTES

SITE REMOVAL NOTES

- EXISTING SITE INFORMATION WAS PROVIDED BY OTHERS. ACTUAL FIELD CONDITIONS MAY VARY. FIELD VERIFY UTILITY LOCATIONS AND ELEVATIONS PRIOR TO CONSTRUCTION.
- 2. THE LOCATIONS OF EXISTING UTILITIES SHOWN ON THIS PLAN HAVE BEEN DETERMINED FROM THE BEST INFORMATION AVAILABLE AND ARE GIVEN FOR THE CONVENIENCE OF THE CONTRACTOR. THE LANDSCAPE ARCHITECT ASSUMES NO RESPONSIBILITY FOR THEIR ACCURACY. PRIOR TO THE START OF DEMOLITION ACTIVITY, THE CONTRACTOR SHALL NOTIFY THE UTILITY COMPANIES FOR ONSITE LOCATIONS OF EXISTING UTILITIES. THE CONTRACTOR IS REQUIRED TO TAKE DUE PRECAUTIONARY MEASURES TO PROTECT EXISTING UTILITIES OR STRUCTURES LOCATED AT THE WORK SITE.
- 3. CONTRACTOR TO VERIFY THE LOCATION OF UNDERGROUND UTILITIES PRIOR TO BEGINNING ANY CONSTRUCTION BY CALLING GOPHER STATE ONE-CALL AT 651-454-0002 (METRO) OR 1-800-252-1166 (OUT-STATE).
- 4. THE CONTRACTOR SHALL COORDINATE WITH RESPECTIVE UTILITY COMPANIES PRIOR TO THE REMOVAL AND/OR RELOCATION OF UTILITIES. THE CONTRACTOR SHALL COORDINATE WITH THE UTILITY COMPANY CONCERNING PORTIONS OF WORK WHICH MAY BE PERFORMED BY UTILITY COMPANY'S FORCES AND FEES WHICH ARE TO BE PAID TO THE UTILITY COMPANY FOR THEIR SERVICES. THE CONTRACTOR IS RESPONSIBLE FOR PAYING FEES AND CHARGES.
- ALWAYS VERIFY BENCHMARK ELEVATIONS BETWEEN TWO BENCHMARKS.
- REMOVAL ITEMS BECOME THE PROPERTY OF THE CONTRACTOR UNLESS SPECIFIED OTHERWISE. THE CONTRACTOR IS RESPONSIBLE FOR REMOVING DEBRIS FROM THE SITE AND DISPOSING THE DEBRIS IN A LAWFUL MANNER PER LOCAL GOVERNING AGENCIES. THE CONTRACTOR IS RESPONSIBLE FOR OBTAINING PERMITS REQUIRED FOR DEMOLITION AND DISPOSAL. FACILITIES TO BE REMOVED SHALL BE UNDERCUT TO SUITABLE MATERIAL AND BROUGHT TO GRADE WITH SUITABLE COMPACTED FILL MATERIAL PER THE SPECIFICATIONS.
- 7. PRIOR TO DEMOLITION, EROSION CONTROL DEVICES ARE TO BE INSTALLED WHERE NECESSARY AND OBTAIN AN NPDES STORM WATER PERMIT. REFER TO CIVIL FOR EROSION CONTROL.
- 8. DAMAGE TO REMAINING EXISTING CONDITIONS WILL BE REPLACED AT CONTRACTOR'S EXPENSE AND SHALL BE EQUAL TO OR EXCEED THE QUALITY OF CONSTRUCTION PRIOR TO DAMAGE.
- 9. CONCRETE PAVEMENT, SIDEWALKS, CURB AND GUTTER, AND OTHER POURED CONCRETE ITEMS ARE TO BE REMOVED TO AN EXISTING EXPANSION OR CONTRACTION JOINT.
- 10. CONTRACTOR SHALL LIMIT SAW-CUT AND PAVEMENT REMOVAL TO ONLY THOSE AREAS WHERE IT IS REQUIRED AS SHOWN ON THESE CONSTRUCTION PLANS. IF DAMAGE IS INCURRED ON THE SURROUNDING PAVEMENT, ETC. THE CONTRACTOR SHALL BE RESPONSIBLE FOR ITS REMOVAL AND REPAIR AT NO ADDITIONAL COST TO THE OWNER. BITUMINOUS PAVEMENT REMOVALS ARE TO BE MADE WITH A VERTICAL SAW CUT OR TO A NEAT MILLED EDGE.
- 11. CONTRACTOR SHALL PRESERVE VEGETATION NOT TO BE REMOVED BY CONSTRUCTION. CONTRACTOR SHALL BE RESPONSIBLE FOR RE-SEEDING OR SODDING AREAS DISTURBED BY CONSTRUCTION.
- 12. LOCATION AND ELEVATIONS OF IMPROVEMENTS TO BE MET (OR AVOIDED) SHALL BE CONFIRMED BY THE CONTRACTOR THROUGH FIELD EXPLORATIONS PRIOR TO CONSTRUCTION. CONTRACTOR SHALL REPORT TO THE LANDSCAPE ARCHITECT DISCREPANCIES BETWEEN THEIR MEASUREMENTS AND THESE PLANS. CONTRACTOR SHALL ALSO MAKE EXPLORATION EXCAVATIONS AND LOCATE EXISTING UNDERGROUND UTILITIES SUFFICIENTLY AHEAD OF CONSTRUCTION TO PERMIT REVISIONS TO PLANS IF REVISIONS ARE NECESSARY BECAUSE OF ACTUAL LOCATION OF EXISTING FACILITIES. CONTRACTOR IS REQUIRED TO TAKE PRECAUTIONARY MEASURES TO PROTECT THE UTILITY LINES SHOWN AND OTHER EXISTING LINES NOT OF RECORD OR NOT SHOWN ON THESE PLANS.
- 13. EXISTING UTILITIES TO REMAIN IN PLACE UNLESS SPECIFICALLY MARKED ON THIS SHEET.

SITE AND LANDSCAPE NOTES

SITE PREPARATION NOTES

- CONTRACTOR SHALL INSPECT THE SITE AND BECOME FAMILIAR
 WITH EXISTING CONDITIONS RELATING TO THE NATURE AND SCOPE
 OF WORK.
- CONTRACTOR SHALL VERIFY PLAN LAYOUT AND BRING TO THE ATTENTION OF THE LANDSCAPE ARCHITECT DISCREPANCIES WHICH MAY COMPROMISE THE DESIGN OR INTENT OF THE LAYOUT.
- 3. CONTRACTOR SHALL ASSURE COMPLIANCE WITH APPLICABLE CODES AND REGULATIONS GOVERNING THE WORK AND MATERIALS SUPPLIED.
- 4. CONTRACTOR SHALL PROTECT EXISTING ROADS, CURBS/GUTTERS, TRAILS, TREES, LAWNS AND SITE ELEMENTS DURING CONSTRUCTION OPERATIONS. DAMAGE TO SAME SHALL BE REPAIRED AT NO ADDITIONAL COST TO THE OWNER.
- 5. CONTRACTOR SHALL VERIFY ALIGNMENT AND LOCATION OF UNDERGROUND AND ABOVE GRADE UTILITIES AND PROVIDE THE NECESSARY PROTECTION FOR SAME BEFORE CONSTRUCTION BEGINS (MINIMUM 10' CLEARANCE).
- CONTRACTOR SHALL COORDINATE THE PHASES OF CONSTRUCTION AND PLANTING INSTALLATION WITH OTHER CONTRACTORS WORKING ON SITE.
- 7. UNDERGROUND UTILITIES SHALL BE INSTALLED SO THAT TRENCHES DO NOT CUT THROUGH ROOT SYSTEMS OF EXISTING TREES TO REMAIN.
- 8. EXISTING CONTOURS, TRAILS, VEGETATION, CURB/GUTTER AND OTHER ELEMENTS ARE BASED UPON INFORMATION SUPPLIED TO THE LANDSCAPE ARCHITECT BY OTHERS. CONTRACTOR SHALL VERIFY DISCREPANCIES PRIOR TO CONSTRUCTION AND NOTIFY LANDSCAPE ARCHITECT OF SAME.
- 9. HORIZONTAL AND VERTICAL ALIGNMENT OF PROPOSED WALKS, TRAILS OR ROADWAYS ARE SUBJECT TO FIELD ADJUSTMENT REQUIRED TO CONFORM TO LOCALIZED TOPOGRAPHIC CONDITIONS AND TO MINIMIZE TREE REMOVAL AND GRADING. CHANGES IN ALIGNMENT AND GRADES MUST BE APPROVED BY THE LANDSCAPE ARCHITECT PRIOR TO IMPLEMENTATION.
- 10. CONTRACTOR SHALL REVIEW THE SITE FOR DEFICIENCIES IN SITE CONDITIONS WHICH MIGHT NEGATIVELY AFFECT PLANT ESTABLISHMENT, SURVIVAL OR WARRANTY. UNDESIRABLE SITE CONDITIONS SHALL BE BROUGHT TO THE ATTENTION OF THE LANDSCAPE ARCHITECT PRIOR TO COMMENCEMENT OF WORK.
- 11. CONTRACTOR IS RESPONSIBLE FOR ONGOING MAINTENANCE OF NEWLY INSTALLED MATERIALS UNTIL TIME OF SUBSTANTIAL COMPLETION. REPAIR OF ACTS OF VANDALISM OR DAMAGE WHICH MAY OCCUR PRIOR TO SUBSTANTIAL COMPLETION SHALL BE THE RESPONSIBILITY OF THE LANDSCAPE CONTRACTOR.
- 12. EXISTING TREES OR SIGNIFICANT SHRUB MASSINGS FOUND ON SITE SHALL BE PROTECTED AND SAVED UNLESS NOTED TO BE REMOVED OR ARE LOCATED IN AN AREA TO BE GRADED. QUESTIONS REGARDING EXISTING PLANT MATERIAL SHALL BE BROUGHT TO THE ATTENTION OF THE LANDSCAPE ARCHITECT PRIOR TO REMOVAL.
- 13. EXISTING TREES TO REMAIN, UPON DIRECTION OF LANDSCAPE ARCHITECT, SHALL BE FERTILIZED AND PRUNED TO REMOVE DEAD WOOD, DAMAGED AND RUBBING BRANCHES.
- 14. CONTRACTOR SHALL PREPARE AND SUBMIT A WRITTEN REQUEST FOR THE SUBSTANTIAL COMPLETION INSPECTION OF LANDSCAPE AND SITE IMPROVEMENTS PRIOR TO SUBMITTING FINAL PAY REQUEST.
- 15. CONTRACTOR SHALL PREPARE AND SUBMIT REPRODUCIBLE AS-BUILT DRAWING(S) OF LANDSCAPE INSTALLATION, IRRIGATION AND SITE IMPROVEMENTS UPON COMPLETION OF CONSTRUCTION INSTALLATION AND PRIOR TO SUBSTANTIAL COMPLETION.
- 16. SYMBOLS ON PLAN DRAWING TAKE PRECEDENCE OVER SCHEDULES IF DISCREPANCIES IN QUANTITIES EXIST. SPECIFICATIONS AND DETAILS TAKE PRECEDENCE OVER NOTES.

SOIL TESTING

- 1. CONTRACTOR SHALL OBTAIN A SOIL SAMPLE(S) FROM PROJECT SITE AND/OR SALVAGED TOPSOIL STOCKPILE AND SUBMIT TO INDEPENDENT TESTING AGENCY. ANALYSIS AND RECOMMENDATIONS FOR (INCLUDING BUT NOT LIMITED TO) MACRONUTRIENTS, MICRONUTRIENTS, COMPOSITION AND SOLUBLE SALTS SHALL BE PROVIDED.
- CONTRACTOR SHALL PROVIDE TWO SERIES OF TESTS: FIRST, PRIOR TO CONSTRUCTION; SECOND, AFTER SOIL IS AMENDED, PRIOR TO PLANTING.
- 3. CONTRACTOR SHALL PROVIDE ANALYSIS RESULTS AND RECOMMENDATIONS TO THE LANDSCAPE ARCHITECT FOR REVIEW AND APPROVAL PRIOR TO SOIL AMENDMENT AND PRIOR TO PLANTING.

GRADING

- 1. ROUGH GRADING AND FINISHED GRADING TO BE DONE BY OTHERS EXCEPT WHERE NOTED.
- 2. GRADING LIMITS ARE DEFINED AS THE JUNCTURE OF PROPOSED GRADE WITH EXISTING GRADE UNLESS NOTED OTHERWISE.
- 3. GRADING LIMITS AND LIMITS OF WORK SHOWN ON PLAN ARE ONLY APPROXIMATE AND MAY BE ADJUSTED IN FIELD BY LANDSCAPE ARCHITECT. WORK OUTSIDE OF THESE LIMITS WILL BE DONE AT LANDSCAPE CONTRACTORS EXPENSE UNLESS DIRECTED BY LANDSCAPE ARCHITECT OR OWNER IN WRITING.

- 4. FILL/CUT AS NECESSARY TO PROVIDE A 1% MINIMUM GRADE AWAY FROM BUILDINGS WITHIN LIMITS OF CONSTRUCTION.
- 5. SALVAGE TOPSOIL FROM THE EARTHWORK AREAS AS APPROPRIATE OR AS INDICATED ON PLANS AND STOCKPILE FOR REUSE.
- 6. MAINTAIN A UNIFORM GRADE BETWEEN CONTOURS IN AREAS TO BE GRADED UNLESS NOTED OTHERWISE.
- 7. ELEVATIONS, IF SHOWN ARE FINISHED ELEVATIONS. SPOT ELEVATIONS TAKE PRECEDENCE OVER CONTOURS.
- 8. ADD EROSION CONTROL MEASURES IF GRADES GREATER THAN 3:1 OR IF CONDITIONS WARRANT. REFER TO MNDOT SPECIFICATIONS FOR EROSION CONTROL.
- 9. CONTRACTOR SHALL CONTACT PUBLIC UTILITIES FOR LOCATION OF UNDERGROUND WIRES, CABLES, CONDUITS, PIPES, MANHOLES, VALVES OR OTHER BURIED STRUCTURES BEFORE DIGGING. LANDSCAPE CONTRACTOR SHALL REPAIR OR REPLACE THE ABOVE IF DAMAGED DURING CONSTRUCTION AT NO ADDITIONAL COST TO THE OWNER.
- 10. CONTRACTOR SHALL PROVIDE PROPER EROSION CONTROL
 MEASURES AS REQUIRED TO ENSURE THAT EROSION IS KEPT TO AN
 ABSOLUTE MINIMUM.
- 11. PROVIDE TEMPORARY COVERING FOR CATCH BASINS AND MAN HOLES UNTIL FINISHED GRADING IS COMPLETE.
- 12. CONTRACTOR SHALL CONSTRUCT DRAINAGE BASINS AS NEEDED
- 13. PERIMETER SILT FENCE AND ROCK CONSTRUCTION ENTRANCES SHALL BE INSTALLED PRIOR TO CONSTRUCTION. REFER TO STATE SPECIFICATIONS FOR AGGREGATE BASE AND SILT FENCE.
- CONTRACTOR SHALL INSTALL CATCH BASIN EROSION CONTROL MEASURES PER LOCAL POLLUTION CONTROL AGENCY AND SPECIFICATIONS.
- 15. WITHIN TWO WEEKS OF FINISHED SITE GRADING, DISTURBED AREAS SHALL BE STABILIZED WITH SEED, SOD, MULCH OR ROCK BASE.
- 16. CONTRACTOR SHALL MAINTAIN EROSION CONTROL MEASURES, INCLUDING THE REMOVAL OF ACCUMULATED SILT IN FRONT OF SILT FENCES AND EXCESS SEDIMENT IN PROPOSED CATCH BASINS, FOR THE DURATION OF CONSTRUCTION.
- 17. CONTRACTOR SHALL REMOVE EROSION CONTROL MEASURES AFTER VEGETATION IS ESTABLISHED AND DISPOSE OF OFF SITE.
- 18. CONTRACTOR SHALL ENSURE THAT SOIL CONDITIONS AND COMPACTION ARE ADEQUATE TO ALLOW FOR PROPER DRAINAGE AROUND THE CONSTRUCTION SITE. UNDESIRABLE CONDITIONS SHALL BE BROUGHT TO THE ATTENTION OF THE LANDSCAPE ARCHITECT PRIOR TO BEGINNING OF WORK. IT SHALL BE THE LANDSCAPE CONTRACTOR'S RESPONSIBILITY TO ENSURE PROPER SURFACE AND SUBSURFACE DRAINAGE IN PLANTING AREAS.

PLANTING

- SPRING PLANT MATERIAL INSTALLATION IS FROM APRIL 15 TO JUNE
 15.
- 2. FALL CONIFEROUS PLANTING IS ACCEPTABLE FROM AUGUST 21 TO SEPTEMBER 30.
- 3. FALL DECIDUOUS PLANTING IS ACCEPTABLE FROM AUGUST 15 UNTIL NOVEMBER 15.
- 4. ADJUSTMENTS TO PLANTING DATES MUST BE APPROVED IN WRITING BY THE LANDSCAPE ARCHITECT.

5. STAKE PROPOSED PLANTING LOCATIONS PER PLAN FOR REVIEW

AND APPROVAL BY LANDSCAPE ARCHITECT PRIOR TO INSTALL.

- 6. PLANT MATERIAL SHALL COMPLY WITH THE CURRENT EDITION OF THE AMERICAN STANDARD FOR NURSERY STOCK, ANSI Z60.1. UNLESS NOTED OTHERWISE, DECIDUOUS SHRUBS SHALL HAVE AT LEAST 5 CANES AT THE SPECIFIED HEIGHT. ORNAMENTAL TREES SHALL HAVE NO 'V' CROTCHES AND SHALL BEGIN BRANCHING NO LOWER THAN 3' FEET ABOVE THE ROOT BALL. STREET AND BOULEVARD TREES SHALL BEGIN BRANCHING NO LOWER THAN 6'
- 7. INSTALL PLANT MATERIAL AFTER FINAL GRADING AND CONSTRUCTION HAS BEEN COMPLETED IN THE IMMEDIATE AREA.
- 8. INSTALL PLANT MATERIALS PER PLANTING DETAILS.

ABOVE PAVED SURFACE.

- 9. SUBSTITUTION REQUESTS FOR PLANT MATERIAL TYPE & SIZE SHALL BE SUBMITTED TO THE LANDSCAPE ARCHITECT FOR CONSIDERATION PRIOR TO BIDDING. SUBSTITUTIONS AFTER BIDDING MUST BE APPROVED BY LANDSCAPE ARCHITECT AND ARE SUBJECT TO CONTRACT ADJUSTMENTS.
- 10. ADJUSTMENTS IN LOCATION OF PROPOSED PLANT MATERIALS MAY BE NEEDED IN FIELD. LANDSCAPE ARCHITECT MUST BE NOTIFIED PRIOR TO ADJUSTMENT OF PLANTS.
- 11. FERTILIZE PLANT MATERIALS IN ACCORDANCE WITH SOIL TEST RECOMMENDATIONS. [FERTILIZE PLANT MATERIAL UPON INSTALLATION WITH DRIED BONE MEAL AND OTHER APPROVED FERTILIZER MIXED IN WITH THE PLANTING SOIL (PER THE MANUFACTURER'S INSTRUCTIONS) OR TREAT FOR SUMMER AND FALL INSTALLATION WITH AN APPLICATION OF GRANULAR 10-0-5 OF 12 OZ. PER 2.5" CALIPER TREE AND 6 OZ. PER SHRUB WITH AN ADDITIONAL APPLICATION OF 10-0-10 THE FOLLOWING SPRING IN THE TREE SAUCER.]
- 12. INSTALL 18" DEPTH OF PLANTING SOIL IN AREAS RECEIVING GROUND COVER, PERENNIALS, AND ANNUALS. PLANTING SOIL SHALL CONSIST OF MnDOT 3877-B MODIFIED TO CONTAIN A MAXIMUM OF 30% SAND, A PH OF 7.1 MAX, OR AS OTHERWISE SPECIFIED IN THE PROJECT SPECIFICATIONS MANUAL.
- 13. [TREE WRAPPING MATERIAL SHALL BE PAPER APPLIED FROM TRUNK FLARE TO FIRST BRANCH. WRAP SMOOTH-BARKED DECIDUOUS TREES PLANTED IN THE FALL PRIOR TO DECEMBER 1 AND REMOVE

WRAPPING AFTER MAY 1.] [DO NOT WRAP TREES.]

14. APPLY PRE-EMERGENT HERBICIDE (PREEN OR APPROVED EQUAL) IN ANNUAL, PERENNIAL, AND SHRUB BEDS FOLLOWED BY SHREDDED HARDWOOD MULCH. REFER TO SPECIFICATIONS FOR ADDITIONAL INFORMATION REGARDING USE OF HERBICIDES.

MULCHING

- INSTALL [4" DEEP FINELY SHREDDED HARDWOOD MULCH] RINGS AT CONIFEROUS & DECIDUOUS TREES WITH NO MULCH IN DIRECT CONTACT WITH TREE TRUNK.
- 2. INSTALL [3" DEEP FINELY SHREDDED HARDWOOD MULCH] RINGS AT SHRUB PLANTING AREAS WITH NO MULCH IN DIRECT CONTACT WITH SHRUB STEMS.
- 3. INSTALL [3" DEEP FINELY SHREDDED MULCH] IN PERENNIAL PLANTING BEDS. REMOVE ALL MULCH FROM STEMS OF PERENNIALS; PLANT STEMS SHOULD NOT BE IN DIRECT CONTACT WITH MULCH.

WATERING

- 1. PLANTED MATERIALS SHALL BE WATERED BY TEMPORARY MEANS UNTIL PLANTS ARE ESTABLISHED.
- 2. TEMPORARY WATERING MEANS, METHODS, AND SCHEDULING SHALL BE THE CONTRACTOR'S RESPONSIBILITY. REMOVE TEMPORARY WATERING EQUIPMENT UPON PLANT ESTABLISHMENT.

WARRANTY

1. WARRANTY NEW PLANT MATERIAL THROUGH ONE CALENDAR YEAR FROM THE DATE OF SUBSTANTIAL COMPLETION. NO PARTIAL ACCEPTANCE WILL BE CONSIDERED.

TURF NOTES

- 1. SOD AREAS DISTURBED DUE TO GRADING UNLESS NOTED OTHERWISE.
- 2. WHERE SOD ABUTS PAVED SURFACES, FINISHED GRADE OF SOD/SEED SHALL BE HELD 1" BELOW SURFACE ELEVATION OF TRAIL, SLAB, CURB, ETC.
- 3. SOD SHALL BE LAID PARALLEL TO THE CONTOURS AND SHALL HAVE STAGGERED JOINTS. ON SLOPES STEEPER THAN 3:1 OR IN DRAINAGE SWALES, SOD SHALL BE STAKED SECURELY [WITH WOODEN STAKES; NO METAL STAKES ARE ALLOWED].
- 4. UNLESS NOTED OTHERWISE, THE APPROPRIATE DATES FOR SPRING SEED & SOD PLACEMENT IS FROM THE TIME GROUND HAS THAWED TO JUNE 15.
- 5. FALL SODDING IS ACCEPTABLE FROM AUGUST 15 TO NOVEMBER 1. FALL SEEDING IS ACCEPTABLE FROM AUGUST 15 TO SEPTEMBER 15. ADJUSTMENTS TO SOD/SEED PLANTING DATES MUST BE APPROVED IN WRITING BY THE LANDSCAPE ARCHITECT.
- 6. NO SOD NETTING ALLOWED ON SITE.

IRRIGATION NOTES

- 1. CONTRACTOR SHALL BE RESPONSIBLE FOR PROVIDING AN IRRIGATION LAYOUT PLAN AND SPECIFICATION THAT MEETS THE REQUIREMENTS OF THE PROVIDED PERFORMANCE SPECIFICATION AS PART OF THE SCOPE OF WORK. SUBMIT LAYOUT PLAN AND SPECIFICATIONS FOR APPROVAL BY THE LANDSCAPE ARCHITECT PRIOR TO ORDER AND/OR CONSTRUCTION. IT SHALL BE THE CONTRACTOR'S RESPONSIBILITY TO ENSURE THAT SODDED/SEEDED AND PLANTED AREAS ARE IRRIGATED PROPERLY, INCLUDING THOSE AREAS DIRECTLY AROUND AND ABUTTING BUILDING FOUNDATION.
- 2. CONTRACTOR SHALL FIELD VERIFY WATER SUPPLY, VOLUME, PRESSURE AND LOCATION FOR SYSTEM TAP PRIOR TO SYSTEM DESIGN.
- 3. [CONTRACTOR SHALL FIELD VERIFY AND INSPECT EXISTING IRRIGATION SYSTEM LAYOUT, EQUIPMENT, CONDITION AND OPERABILITY PRIOR TO SYSTEM DESIGN.]
- 4. CONTRACTOR SHALL CONFIRM COMPLETE LIMITS OF IRRIGATION WITH LANDSCAPE ARCHITECT PRIOR TO SUPPLYING SHOP DRAWINGS.
- CONTRACTOR SHALL CONTACT LANDSCAPE ARCHITECT FOR INSPECTION AND APPROVAL OF AREAS RECEIVING DRIP IRRIGATION PRIOR TO INSTALLATION OF MULCH.
- 6. CONTRACTOR SHALL PROVIDE THE OWNER AND LANDSCAPE ARCHITECT WITH AS-BUILT DRAWINGS, DETAILED SYSTEM OPERATION INSTRUCTIONS AND AN IRRIGATION SCHEDULE APPROPRIATE TO THE PROJECT SITE CONDITIONS AND PLANTED MATERIAL GROWTH REQUIREMENTS.



CITY OF NORTHFIELD
801 WASHINGTON STREET

Minnesota

NORTHFIELD, MINNESOTA 55057
DAVID.BENNETT@CI.NORTHFIELD.MN.US

DAMON FARBER
LANDSCAPE ARCHITECTS
310 S 4TH AVE
MINNEAPOLIS, MN 55415

RBLASEG@DAMONFARBER.COM 612.332.7522 BOLTON & MENK

7575 GOLDEN VALLEY ROAD SUITE 200 MINNEAPOLIS, MN 55427 BRADLEY.FISHER@BOLTON-MENK.COM 612.759.7240

> NELSON-RUDIE & ASSOCIATES, 9100 49TH AVE N, MINNEAPOLIS, MN 55428

SARAH.GREFF@NELSONRUDIE.COM

SCHULER & SHOOK

763.367.7600

219 SE MAIN ST

MINNEAPOLIS, MN 55414 PWHITAKER@SCHULERSHOOK.COM 612.339.5958

60% PRICING SET

NORTHFIELD BRIDGE SQUARE

NORTHFIELD, MN

I hereby certify that this document was prepared by me or under my direct supervision and that I am a duly licensed Landscape Architect under the laws of the State of Minnesota.

Registration# 26292

Signature Date 09/26/2023

DF/ Project #


Drawn/Checked

Tom Whitlock

22-184

AS SHOWN

RP/AG/BE/RB

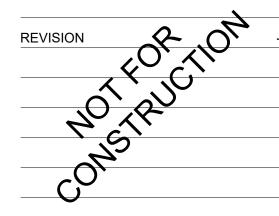

LANDSCAPE NOTES

1002

TREE PRESERVATION NOTES


- 1. REFER TO CIVIL FOR DEMOLITION & REMOVALS PLAN
- 2. EXISTING TREE LOCATIONS & QUANTITIES SHOWN ON PLAN ARE APPROXIMATE & TO BE **VERIFIED IN FIELD.** SURVEYED TREES INCLUDE TREES LARGER THAN 6". SMALLER TREES EXIST ON SITE AND IT SHALL BE THE RESPONSIBILITY OF THE CONTRACTOR TO FAMILIARIZE THEMSELVES WITH EXTENTS OF EXISTING VEGETATION.
- REMOVE DEBRIS FROM TREE PROTECTION ZONES. RESTORE ROOT ZONES WHERE SOIL COMPACTION HAS OCCURRED OUTSIDE OF TREE PROTECTION ZONE BUT WITHIN DRIPLINE OF TREES- USE AIR SPADE TO DECOMPACT. REFER TO SPECIFICATIONS.
- 4. TREE PROTECTION AND EROSION CONTROL MEASURES ARE TO BE INSTALLED PRIOR TO DEMOLITION AND SHALL BE MAINTAINED FOR THE DURATION OF THE CONSTRUCTION PERIOD. MAINTAIN TREE PROTECTION ZONES TO BE FREE OF CONSTRUCTION DEBRIS AND TRASH.
- 5. PROTECT ROOT ZONES FROM COMPACTION DURING CONSTRUCTION ACTIVITIES. RESTORE ROOT ZONES WHERE SOIL COMPACTION HAS OCCURRED OUTSIDE OF TREE PROTECTION ZONE BUT WITHIN DRIPLINE OF TREES- USE AIR SPADE TO DECOMPACT. REFER TO **SPECIFICATIONS**
- 6. **DO NOT DISTURB ROOT ZONES OF TREES TO BE PRESERVED.** WHERE WORK IS TO OCCUR WITHIN DRIPLINE OF TREE. PROVIDE CLEAN ROOT CUTTING & ROOT ZONE PROTECTION.
- FOR TREES DAMAGED DURING CONSTRUCTION, THE OWNER SHALL BE COMPENSATED A MONETARY VALUE AS DETERMINED BY AN ISA CERTIFIED ARBORIST PER "THE GUIDE FOR PLANT APPRAISAL, 10TH EDITION

TREE PROTECTION

- 1. PRESERVE TREES SHOWN IN THE DRAWINGS TO BE PROTECTED AND PRESERVED. INSTALL TREE PROTECTION MEASURES PER DETAILS & SPECIFICATIONS
- 2. INSTALL TREE PROTECTION MEASURES ARE TO BE INSTALLED PRIOR TO DEMOLITION AND SHALL BE MAINTAINED FOR THE DURATION OF THE CONSTRUCTION PERIOD.
- 3. UNAUTHORIZED WORK SHALL OCCUR IN TREE PROTECTION ZONES.
- 4. PROVIDE CLEAN ROOT CUTTING OF ROOTS $\frac{1}{2}$ " DIA OR LARGER ENCOUNTERED DURING EXCAVATION. PROTECT EXPOSED CUT ENDS OF ROOTS USING 4" LAYER OF SHREDDED HARDWOOD MULCH.

- 5. REFER TO PLANS FOR LOCATIONS OF ROOT PRUNING ACTIVITIES. ROOT PRUNING SHALL BE
- 6. TAKE PRECAUTIONS TO MINIMIZE DAMAGE TO TREES WHERE WORK IS DESIGNATED TO OCCUR WITHIN AND ADJACENT TO THE DRIPLINE OF TREES. REFER TO TREE PROTECTION DETAILS FOR TREE PROTECTION FENCE. AND TRUNK PROTECTION.
- BE COMPLETED USING HAND OPERATED EQUIPMENT ONLY TO MINIMIZE DAMAGE TO ROOT SYSTEMS.
- PROTECT TRUNK AND BRANCHES FROM DAMAGE WHERE WORK IS DESIGNATED TO OCCUR WITHIN THE DRIPLINE OF TREES AND USE HAND OPERATED EQUIPMENT ONLY. PROVIDE TRUNK PROTECTION AT SELECTION LOCATIONS PER DETAILS.
- 7. CONTRACTOR SHALL NOT PLACE TEMPORARY STRUCTURES OR STORE MATERIALS IN TREE

- 1. IN AREAS WHERE WORK OCCURS WITHIN DRIPLINE OF TREES AND IDENTIFIED AS ROOT PROTECTION ZONES, CONTRACTOR SHALL USE EXTRA PRECAUTION TO MINIMIZE
- 2. PROVIDE 4" LAYER OF SHREDDED HARDWOOD MULCH IN AREAS IDENTIFIED AS ROOT
- 3. CONTRACTOR SHALL NOT STORE MATERIALS, EQUIPMENT, OR PARK VEHICLES IN ROOT PROTECTION ZONES.

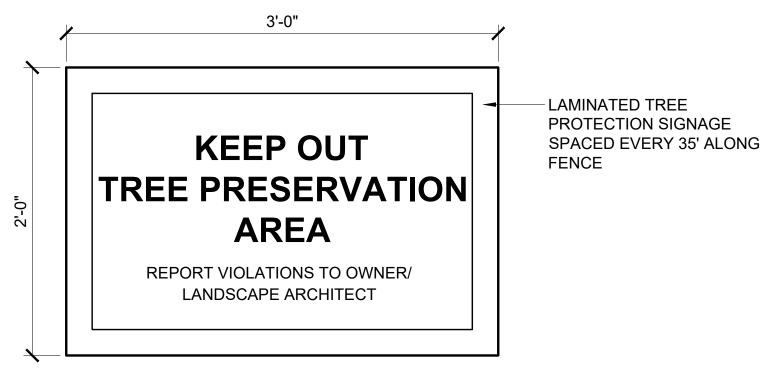

- WHERE WORK IS TO OCCUR WITHIN THE DRIPLINE OF A TREE, CONTRACTOR TO USE AIR EXCAVATOR, DIRECTIONAL BORING. ROOT PRUNING, AND PRECAUTIONARY MEASURES AS DETAILED. ROOT PRUNING TO BE PERFORMED BY ISA CERTIFIED ARBORIST.
- 2. ROOT PRUNING SHALL BE DONE WITH A TRENCHER OR VIBRATORY PLOW TO A DEPTH OF 18". ROOTS OVER 1.5" DIA SHALL HAVE A CLEAN CUT MADE BY A CLEAN SAW ON SURFACE OF THE ROOT. DO NOT PAINT CUT ROOT
- 3. FOR INSTALLATION OF UTILITIES WITHIN DRIPLINE OF TREE, LEAVE ROOTS IN TACT AND UTILIZE DIRECTIONAL BORING TO THREAD UTILITY LINES BENEATH.
- 4. ROOT PRUNING SHALL TAKE PLACE PRIOR TO CLEARING AND GRADING. STAKE LOCATIONS OF TREE PROTECTION PRIOR TO TRENCHING.
- BACKFILL ROOT PRUNING TRENCHES WITH EXCAVATED SOIL AND MULCH. MARK LOCATIONS WITH STAKES FOR FUTURE REFERENCE. SILT FENCE MAY BE INSTALLED IN TRENCH PRIOR TO BACKFILLING AS LONG AS TRENCH IS NOT OPEN LONGER THAN 48HRS WITHOUT WATERING.
- DO NOT PERFORM ROOT PRUNING WHEN SOIL IS WET OR WHEN TOP 1" OR MORE OF SOIL IS FROZEN.
- AVOID DISTURBANCE WITHIN CRITICAL ROOT ZONE. CRITICAL ROOT ZONE SHALL BE MEASURED FROM TRUNK **OUTWARD AND CALCULATED AS FOLLOWS:**
 - DBH < 29.9" USE 1 FOOT RADIUS PER 1 INCH DBH, MIN 3' RADIUS
 - DBH > 30" USE 1.5 FOOT RADIUS PER 1 INCH DBH

- DRIPLINE VARIES

 TREE PROTECTION FENCING & SIGNAGE, REFER TO DETAILS

AVOID DISTURBANCE TO CRITICAL ROOT ZONE. WORK WITHIN THIS ZONE WILL REQUIRE ADDITIONAL MEASURES OF PROTECTION AND RESTORATION, TO BE RECOMMENDED BY ISA CERTIFIED ARBORIST.


ROOT PRUNING TRENCH, PRUNE ON TREE SIDE OF PROTECTION FENCE, 6" WIDE MAX x 18" TYP DEPTH.

DIRECTIONAL BORING PERMITTED AT MIN 4' DEPTH UNDER CROWN DRIPLINE OF TREES. OPEN TRENCHING PERMITTED OUTSIDE DRIPLINE

ROOT PRUNING & DIRECTIONAL BORING DETAIL

CRITICAL ROOT ZONE

1 1/2" = 1'-0"

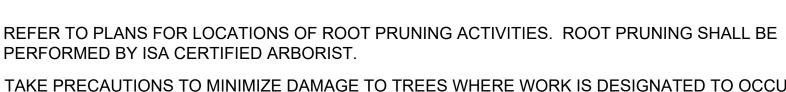



6.1. WORK OUTSIDE OF TREE PROTECTION FENCING BUT WITHIN DRIPLINE OF TREES SHALL

PROTECTION ZONES OR WITHIN THE DRIPLINE OF TREES.

ROOT PROTECTION


- DISTURBANCE TO ROOTS DURING CONSTRUCTION ACTIVITIES.
- PROTECTION ZONES.

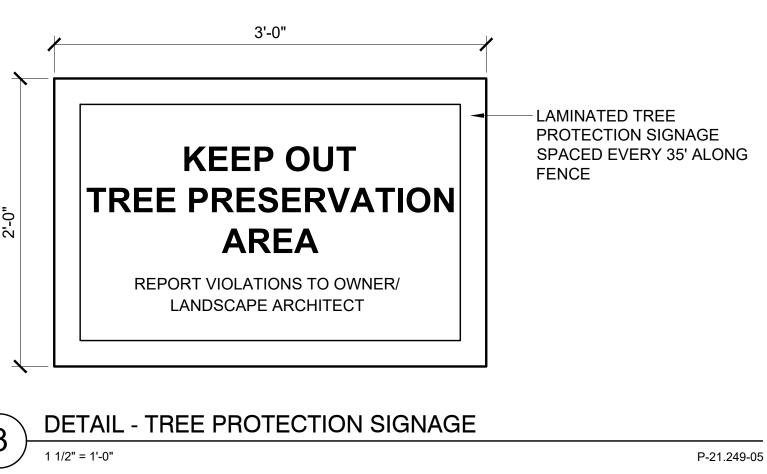

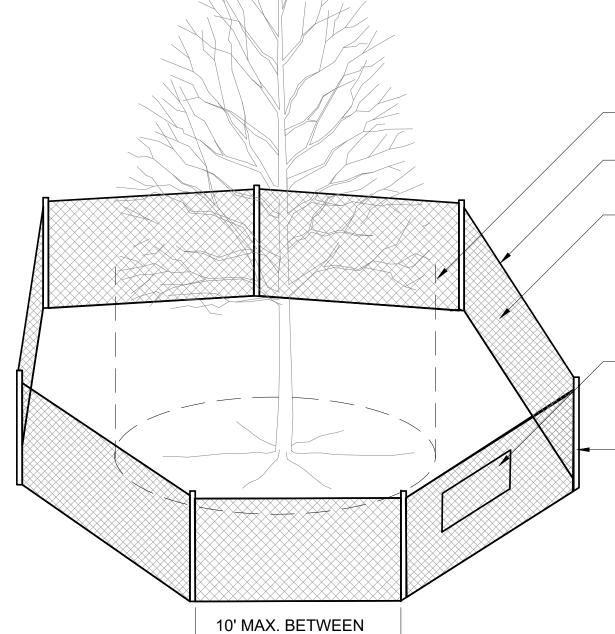

DETAIL - TRUNK PROTECTION

SUPPORTS PERSPECTIVE

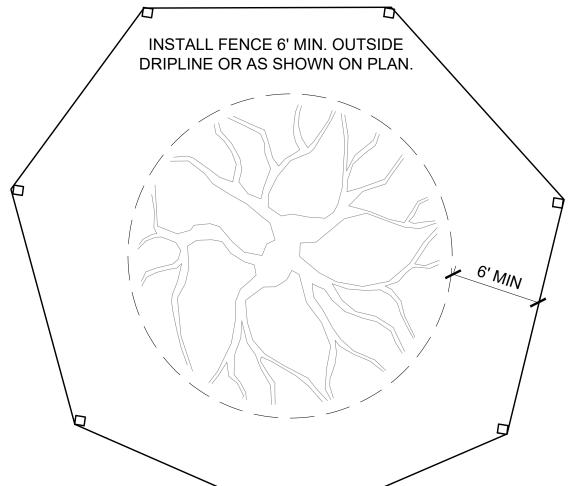

DETAIL - TREE PROTECTION

P-22 184-70

PLAN

1 1/2" = 1'-0"

PRESERVATION 4. PLACE TREE PROTECTION WITHIN DRIPLINE WHEN FULL DRIPLINE PROTECTION IS NOT FEASIBLE DUE TO EXISTING PAVEMENT OR OTHER OBSTACLES.

NOTES:

TO TREE TRUNK.

1. DO NOT FASTEN PLANKING DIRECTLY

2. DO NOT INSTALL PLANKING ON ROOT

PROTECTIVE PLANKING: 2x6x8

AROUND TREE TRUNK.

TREE TRUNK.

MAPLES)

UNTREATED LUMBER, COMPLETELY

- MIN. 1/2" DIAMETER NATURAL ROPE OR

NYLON STRAPS, TIGHTENED AROUND

PREVENT SLIPPAGE. 3 STRAPS PER

WRAP TREE WITH 3-5 LAYERS BURLAP

BOARDS. PROVIDE 5 LAYERS ON THIN-BARKED TREES (E.G. SUGAR

DRIPLINE VARIES

FENCE TAUGHT

OR GALVANIZED

ARCHITECT.

NOTES:

WITH GALVANIZED WIRE TIES

FENCE. REFER TO SIGNAGE DETAIL

COMPLETELY UNDER TREE PROTECTION

P-21.249-04

TENSIONER: COATED WIRE OR NYLONE ROPE TO KEEP

TREE PROTECTION FENCING: 48" ORANGE SNOW FENCING

OR CONSTRUCTION GRADE CHAIN LINK. FASTEN TO POSTS

TREE PROTECTION SIGNAGE SPACED EVERY 50' ALONG

POSTS: 7' U-CHANNEL 1.12 LBS/FOOT STRENGTH PAINTED

INSTALLED PRIOR TO DEMOLITION IN LOCATIONS SHOWN ON PLANS AND SHALL BE MAINTAINED FOR

PROTECTION FENCING MAY BE RELOCATED AS

2. DO NOT STORE MATERIALS, EQUIPMENT OR PARK

SHALL PREVENT TRAFFIC MOVEMENT AND THE

VEGETATION WITHIN THE LIMITS OF PROTECTION.

STOCKPILES AND SUPPLIES FROM HARMING

3. PLACE 4" DEPTH ORGANIC WOOD MULCH WITHIN TREE PROTECTION FENCING FOR MOISTURE

THE DURATION OF THE CONSTRUCTION PERIOD.TREE

NECESSARY WITH APPROVAL FROM THE LANDSCAPE

VEHICLES IN TREE PROTECTION ZONES. THE FENCE

PLACEMENT OF TEMPORARY FACILITIES, EQUIPMENT,

1. INSTALL TREE PROTECTION FENCING SHALL BE

BOARDS. STAPLE TO BOARDS TO

5. INSTSALL TRUNK PROTECTION WHERE TREE PROTECTION OCCURS WITHIN DRIPLINE OF TREE, WRAP TRUNK W/ 2X6 BOARDS SECURED TIGHTLY AROUND TRUNK WITH STRAP BINDINGS.

6. NO PRUNING SHALL BE PERFORMED EXCEPT WHERE APPROVED BY APPROVED LANSDCAPE ARCHITECT AND PERFORMED BY ISA CERTIFIED ARBORIST.

7. PERFORM ROOT PRUNING BY A CERTIFIED ARBORIST IF WORK INVOLVES EXCAVATION OR TRENCHING WITHIN THE DRIPLINE OF A PRESERVATION TREE.

DAMON FARBER LANDSCAPE ARCHITECTS 310 S 4TH AVE MINNEAPOLIS, MN 55415 RBLASEG@DAMONFARBER.COM 612.332.7522

BOLTON & MENK 7575 GOLDEN VALLEY ROAD SUITE 200 MINNEAPOLIS. MN 55427 BRADLEY.FISHER@BOLTON-MENK.COM 612.759.7240

Minnesota

CITY OF NORTHFIELD

801 WASHINGTON STREET

NORTHFIELD, MINNESOTA 55057

DAVID.BENNETT@CI.NORTHFIELD.MN.US

NELSON-RUDIE & ASSOCIATES. 9100 49TH AVE N. MINNEAPOLIS, MN 55428 SARAH.GREFF@NELSONRUDIE.COM 763.367.7600

SCHULER & SHOOK 219 SE MAIN ST MINNEAPOLIS. MN 55414 PWHITAKER@SCHULERSHOOK.COM 612.339.5958

60% PRICING SET

NORTHFIELD **BRIDGE SQUARE**

NORTHFIELD, MN

I hereby certify that this document was prepared by me or under my direct supervision and that I am a duly licensed Landscape Architect under the laws of the State of Minnesota.

Registration#

Tom Whitlock


26292

Date Signature 09/26/2023 DF/ Project # 22-184 AS SHOWN RP/AG/BE/RB Drawn/Checked

REVISION

TREE **PRESERVATION** NOTES & **DETAILS**

P-21.249-23

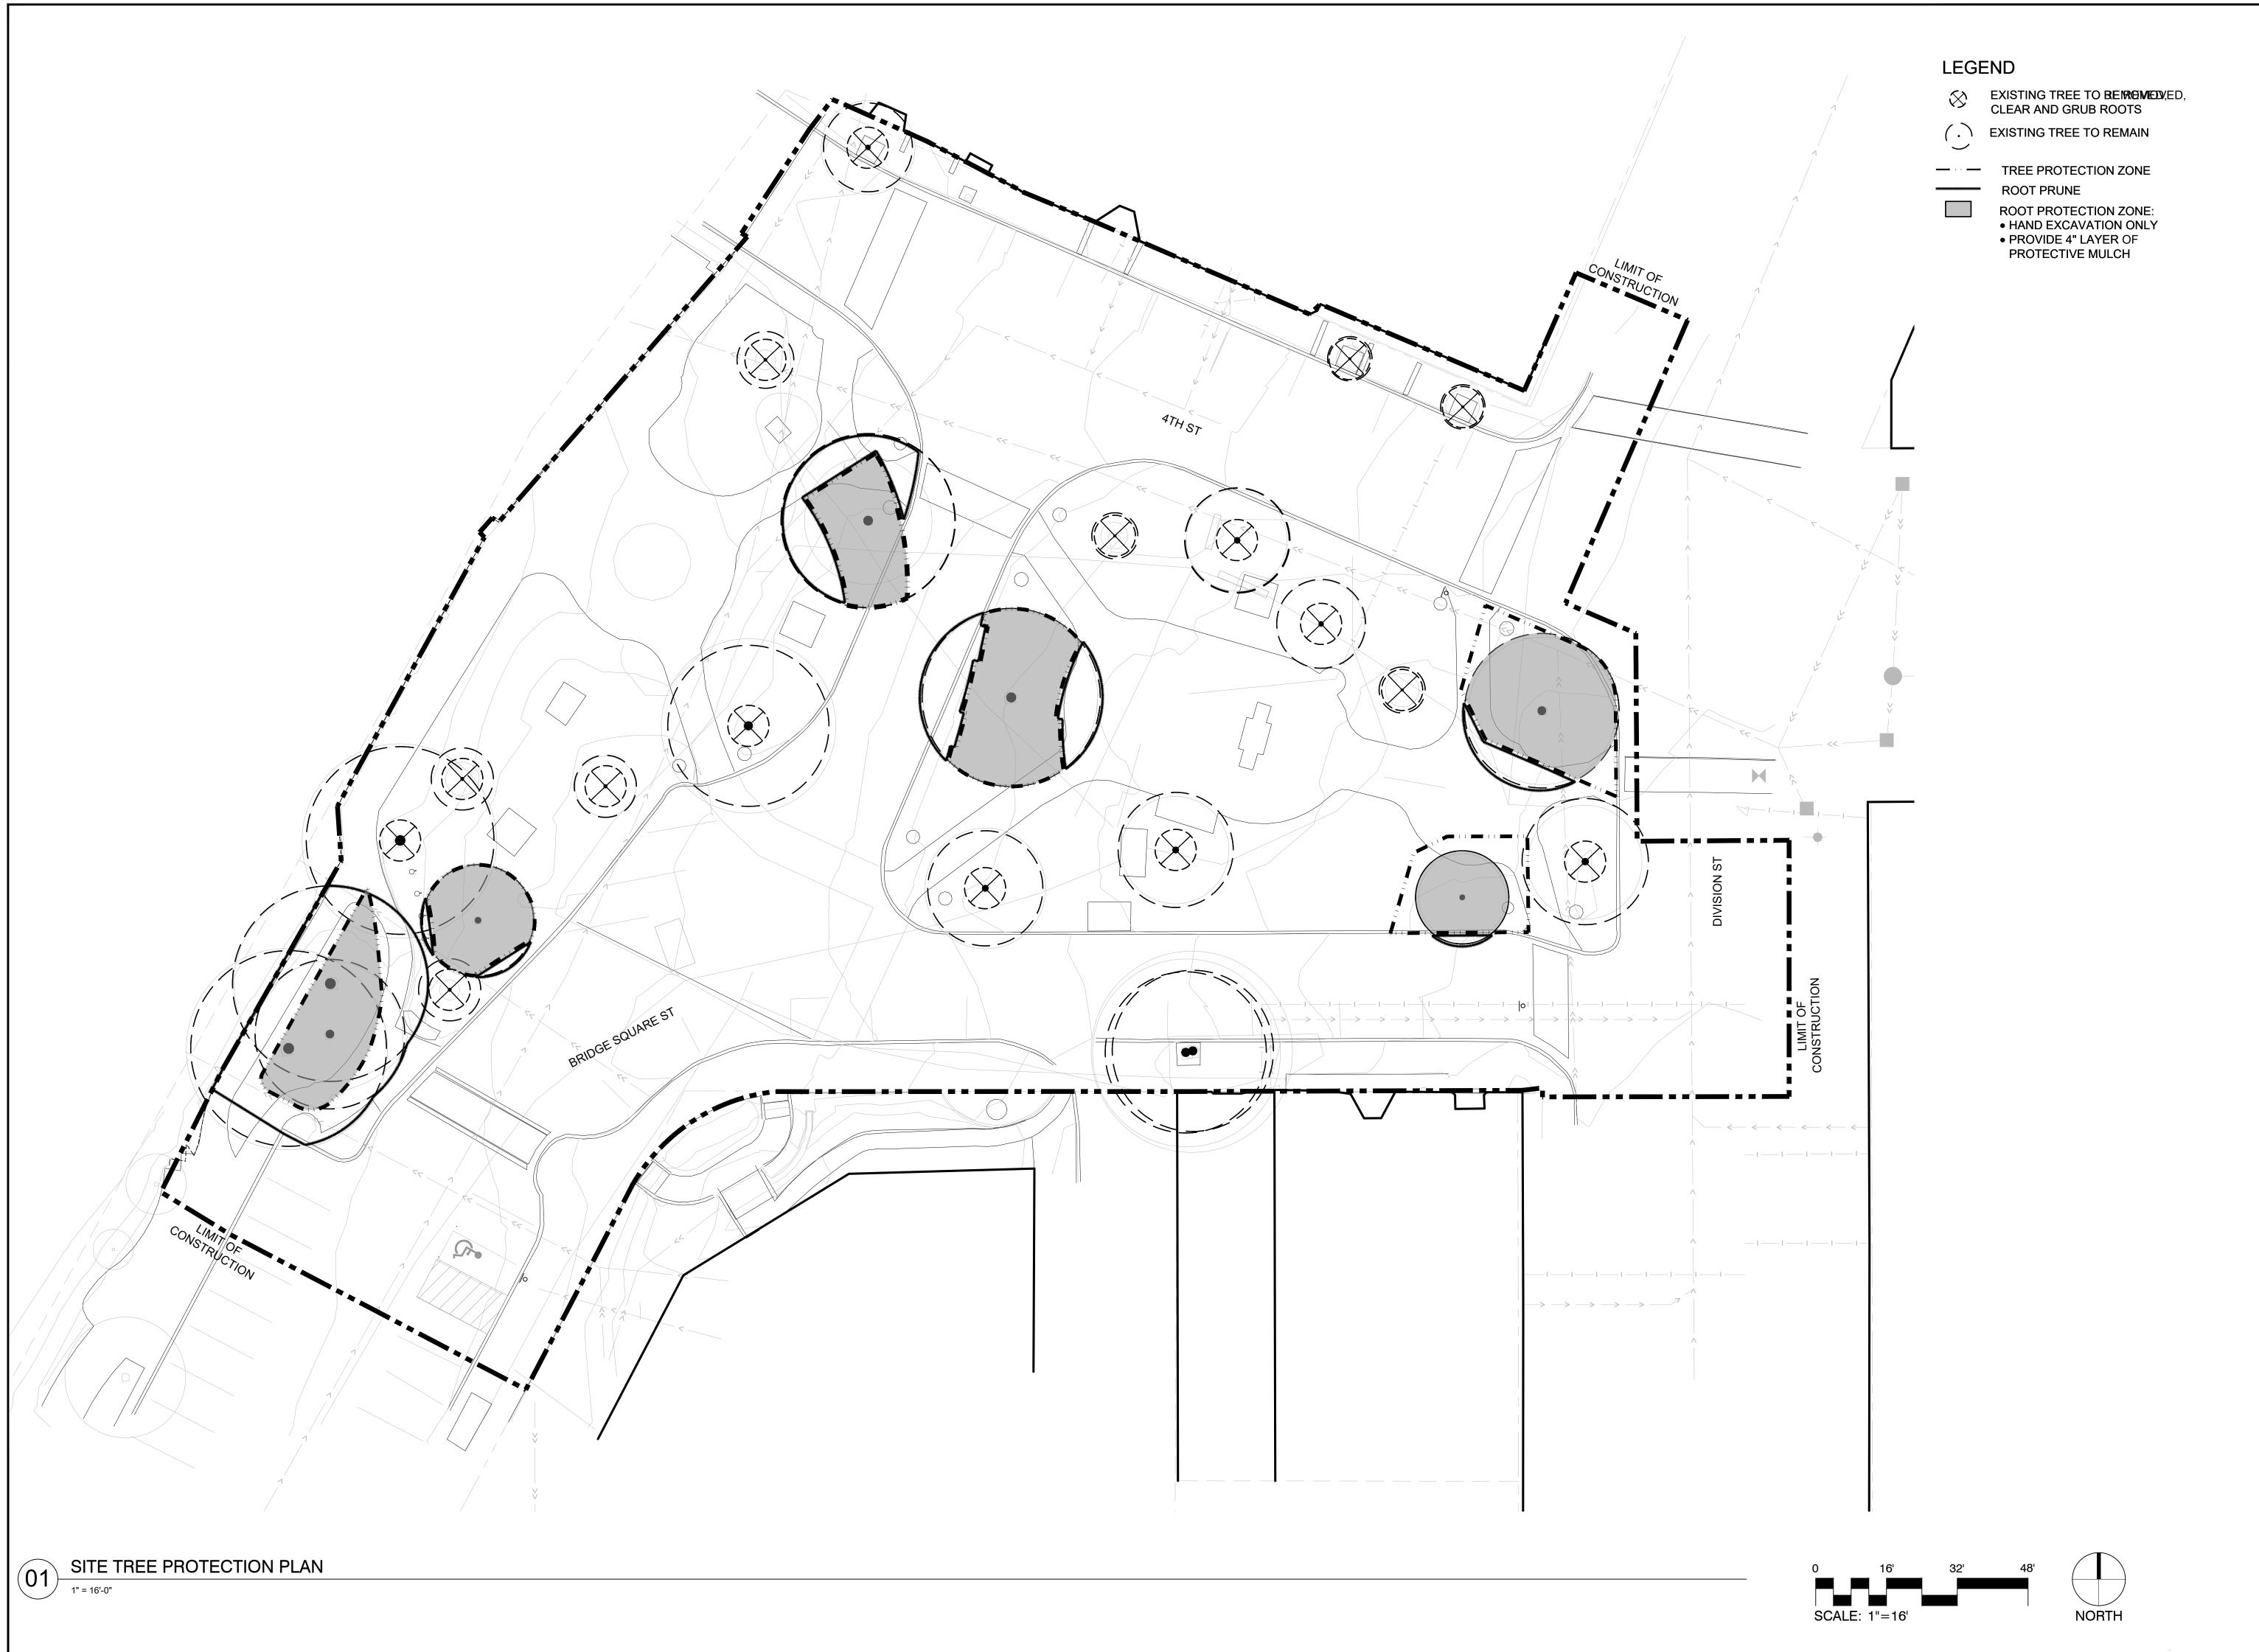



Minnesota

CITY OF NORTHFIELD

801 WASHINGTON STREET NORTHFIELD, MINNESOTA 55057 DAVID.BENNETT@CI.NORTHFIELD.MN.US

DAMON FARBER LANDSCAPE ARCHITECTS 310 S 4TH AVE MINNEAPOLIS, MN 55415 RBLASEG@DAMONFARBER.COM 612.332.7522

BOLTON & MENK

7575 GOLDEN VALLEY ROAD SUITE 200 MINNEAPOLIS, MN 55427 BRADLEY.FISHER@BOLTON-MENK.COM 612.759.7240

NELSON-RUDIE & ASSOCIATES, 9100 49TH AVE N, MINNEAPOLIS, MN 55428 SARAH.GREFF@NELSONRUDIE.COM 763.367.7600

SCHULER & SHOOK 219 SE MAIN ST

MINNEAPOLIS, MN 55414 PWHITAKER@SCHULERSHOOK.COM 612.339.5958

60% PRICING SET

NORTHFIELD BRIDGE SQUARE

NORTHFIELD, MN

I hereby certify that this document was prepared by me or under my direct supervision and that I am a duly licensed Landscape Architect under the laws of the State of Minnesota.

Tom Whitlock

26292 Registration# Date Signature 09/26/2023 22-184 DF/ Project # AS SHOWN RP/AG/BE/RB Drawn/Checked

> SITE TREE PROTECTION PLAN

	RDSCAPE SCHEDULE	07/									
	DGING TYPE 01 - CIP CONCRETE CURB	QTY 279 LF	DETAIL 3/L500	MATERIAL PROFILE/ASSEMBLY 12"W X 6"H FLUSH CONCRETE C	URB EDGE OVER COMPACTE	ED AGGREGATE BASE,	MANUFACTURER	PRODUCT/MODEL	COLOR/FINISH SANDBLASTED		
S	PEC: 32 13 16	2/9 LF	3/L300	COMPACTED SUBGRADE					SANDBLASTED		
	ANDRAIL TYPE 04	QTY	DETAIL	MATERIAL PROFILE/ASSEMBLY	ATED CLIADDDAIL 4"V4" DOC	TC	MANUFACTURER	PRODUCT/MODEL	COMMENTS	DAII LICUTE SEE	
SI	SUARDRAIL TYPE 01 SPEC: 05 50 01	228 LF	1/L502	STAINLESS STEEL POWDER CO. BOTTOM RAIL AND BALLUSTRAT		15, 5°X1/2° TOP RAIL, 1/2°X3°	CUSTOM	STAINLESS STEEL POWDER COATED	LIGHTING	D RAIL LIGHTS, SEE	
	ANDRAIL TYPE 01 PEC: 05 50 01	16 LF	3/L502	2"W X 1/2"H STAINLESS STEEL B	SAR POWDER COATED HAND	RAIL	сиѕтом	STAINLESS STEEL POWDER COATED			
	AVING	QTY	DETAIL	MATERIAL PROFILE/ASSEMBLY			MANUFACTURER	PRODUCT/MODEL	COLOR/FINISH		COMMENTS
	AVING TYPE 01A - DECORATIVE CONCRETE PAVING PEC: 32 13 13	3 13,847	SF SEE CIVIL	6" CONCRETE PAVEMENT OVER	COMPACTED AGGREGATE B	BASE, COMPACTED SUBGRAI	DE		STANDARD GRA	Y, LIGHT BROOM FINISH, S	SEE CIVIL FOR PAVING & SUBBASE THICKNESSES
	AVING TYPE 01B - CONCRETE PAVING - VEHICULAF PEC: 32 13 13	7,043 S	SEE CIVIL	6" REINFORCED VEHICULAR RA' BASE, SELECTED GRANULAR EN			GATE		STANDARD GRA SAW CUT JOINT	Y, LIGHT BROOM FINISH, S	SEE CIVIL FOR PAVING & SUBBASE THICKNESSES
P-02A V	AVING TYPE 02A - DECORATIVE CONCRETE PAVING EHICULAR EPEC: 32 13 16	3,828 S	SEE CIVIL	6" REINFORCED VEHICULAR RA' BASE, SELECT GRANULAR EMPE					SANDBLAST FIN	PR - GRAY FAMILY, ISH, SAW CUT JOINTS	SEE CIVIL FOR PAVING & SUBBASE THICKNESSES
P-UZB	ECORATIVE TYPE 02B - CONCRETE PAVING PEC: 32 13 16	444 SF	SEE CIVIL	6" REINFORCED VEHICULAR RA' BASE, COMPACTED SUBGRADE	•	OVER COMPACTED AGGREC	SATE			R - GRAY FAMILY, RDER FINISH, SAW CUT	SEE CIVIL FOR PAVING & SUBBASE THICKNESSES, MOCKUP REQ.
	AVING TYPE 05A - UNIT PAVING PPEC: 32 14 00	2,988 S	F 1/L500	LINEAR, PLANK PAVERS			UNILOCK	PROMENADE 8X24 A	SANDSTONE		SEE CIVIL FOR ENGINEERED SUBBA
	AVING TYPE 05B - UNIT PAVING PEC: 32 14 00	4,467 S	F 1/L500	LINEAR, PLANK PAVERS.			UNILOCK	PROMENADE 4X16 A	SANDSTONE - R	UNNING BOND PATTERN.	SEE CIVIL FOR ENGINEERED SUBBA
SYMBOL S	TAIRS	QTY	DETAIL	MATERIAL PROFILE/ASSEMBLY			PRODUCT/MODEL	COLOR/FINISH			
ST 01	TAIR TYPE 01 - CIP CONCRETE STAIR	105 LF	3/L502	CIP CONCRETE STAIRS OVER C	IP CONCRETE FOOTING, COM	//PACTED AGGREGATE,	BROOM FINISH CONCRETE				
ST-02 S	PEC: 32 13 13 TAIR TYPE 02 - PRECAST CONCRETE STEP PEC: 03 45 00	60 LF	4/L502	4` TREAD X 6" RISER PRECAST (CONCRETE STAIR			PRECAST CONCRETE			
	VALL TYPE 01 - 10" PRECAST WALL	QTY 503 LF	DETAIL 4/L504	MATERIAL PROFILE/ASSEMBLY PRECAST CONCRETE PLANTER	WALL, OVER COMPACTED AC	GGREGATE, COMPACTED	MANUFACTURER AMERICAN ARTSTONE, WAUSAU	PRODUCT/MODEL PRECAST CONCRETE, ADD	COLOR/FINISH	ACID ETCH SIDES	COMMENTS
Si	PEC: 03 45 00 VALL TYPE 02 - 8" CIP WALL			SUBGRADE CIP CONCRETE CHEEK WALL. S	IZE VARIES. OVER COMPACT	ED AGGREGATE. COMPACTE	TILE, OR APPROVED EQUAL	DIMENSIONS	,	ACID ETCH SIDES	
S/	PPEC: 32 13 13 VALL TYPE 03 - PRECAST CURVED SEAT WALL - LAV	62 LF	4/L500	SUBGRADE 3` W X 1`-3" H PRECAST CONCRI	, 		AMERICAN ARTSTONE, WAUSAU		ACID WASH		
WL-03	PEC: 03 45 00 VALL TYPE 04 - PRECAST CURVED SEAT WALL -	74 LF	1/L505	COMPACTED AGGREGATE, COM	IPACTED SUBGRADE	,	TILE, OR APPROVED EQUAL		ACID WASH		
WL-04	ROMENADE PEC: 03 45 00	26 LF	4/L501	15.75" W X 1`-4" H PRECAST SEA AGGREGATE, COMPACTED SUB	•	SUBSLAB, COMPACTED	AMERICAN ARTSTONE, WAUSAU TILE, OR APPROVED EQUAL	PRECAST CONCRETE, ADD DIMENSIONS	ACID ETCHED A	LL SIDES	
1 1 1 1 1 1 1 1 1 1 1 1 1 1 1 1 1 1 1 1	VALL TYPE 05- PRECAST CURVED WALL - PLAZA PPEC: 03 45 00	17 LF	1/L501	15.75` W X 1`-4" H PRECAST CON COMPACTED AGGREGATE, COM	,	ONCRETE SUBSLAB, OVER	ARTSTONE, WAUSAU TILE, OR APPROVED EQUAL		ACID ETCHED A	LL SIDES	SET HAND TIGHT
SITE FUR	RNISHINGS SCHEDULE	Y DETAIL	MATERIAL PRO	DFILE/ASSEMBLY	MANUFACTURER	PRODUCT/MODEL	COLOR/FINISH			COMMENTS	
BO 01 BOI	LLARD TYPE 01 - REMOVABLE	3/L503		VABLE BOLLARD	RELIANCE FOUNDRY	R-8464-RA	ANNODIZED SILVER / WHITE TAPE			EMBEDDED MOUNT	
SPE	EC: 32 33 00										
SYMBOL HAI	NDRAIL QT VARDRAIL TYPE 01B - BAR HEIGHT TABLE				MANUFACTURER	PRODUCT/MODEL	COLOR/FINISH HOT-DIP GALVANISED AND POWDER-COA	TED WITH LINSEED OIL PROOF	ED NORDIC PINE	COMMENTS CUSTOMIZED CANTILEVE	R MOUNTING
HR-UIR	EC: 05 50 01	2/L502	CUSTOMIZED	APRIL BAR TABLE	VESTRE	741-900A	(STANDARD)	TED WITH EINGELD GIET NOOI	EB NONBIOT INC	OPTION	TO MODIVINO
SYMBOL LIG	GHTING	Y DETAIL	MATERIAL PRO	DFILE/ASSEMBLY	MANUFACTURER	PRODUCT/MODEL	COLOR/FINISH				
	GHT TYPE 01 - TREE MOUNTED FLOOD LIGHT 44			PLAN: AL 101, FIXTURE CODE SB	BK LIGHTING SCHEDULE	SEE LIGHTING SCHEDULE					
	GHT TYPE 02 - CITY STANDARD STREET POLE 11 GHT TYPE 03 - POLE WITH MULTIPLE HEADS 12			PLAN: AL 101, FIXTURE CODE SC PLAN: AL 101, FIXTURE CODE SC1		SEE LIGHTING SCHEDULE SEE LIGHTING SCHEDULE					
	6HT TYPE 04 - DECORATIVE POLE TBD 8			PLAN: AL 101, FIXTURE CODE SC2		SEE LIGHTING SCHEDULE					
LT-06 LIG	GHT TYPE 06 - INGRADE UPLIGHT 4		SEE LIGHTING	PLAN: AL 101, FIXTURE CODE SD	BK LIGHTING	SEE LIGHTING SCHEDULE	SEE LIGHTING SCHEDULE				
	E FURNITURE QT	Y DETAIL	MATERIAL PRO	OFILE/ASSEMBLY	MANUFACTURER	PRODUCT/MODEL	COLOR/FINISH			COMMENTS	TDAOTOD
SF-01 SPE	STRO CHAIR EC: 32 33 00	1	APRIL GO CHA	AIR	VESTRE	7013-930	HOT-DIP GALVANISED AND POWDER-COA	TED IN COLOR TBD		OWNER FURNISHED CON INSTALLED	
SF-02 SPL	EC: 32 33 00	1	APRIL ROUND	TABLE	VESTRE	738-900	HOT-DIP GALVANISED AND POWDER-COA	TED IN COLOR TBD		OWNER FURNISHED CON INSTALLED	IRACIUR
SF-03	EC: 32 33 00	1/L503	VROOM BICYC	CLE RACK	VESTRE	696-904C	POWDER-COATED ALUMINUM WITH COLO		INI KEDONY	ANCHOR USING TYPE C -	
SF-04 SPE	NCH TYPE 1 - BACKLESS WALL MOUNT BENCH 4 EC: 32 33 00 NCH TYPE 2 - BACKED SEATWALL BENCH	2/L501		MOUNT WOOD SEAT	VESTRE	620-901MKL2	HOT-DIP GALVANISED AND POWDER-COA CLEAR WOOD SEAT MATERIAL		, 	MKL (WALL-MOUNT LOW)	BRACKETS
SF-05 WIT	TH ARMRESTS EC: 32 33 00	2/L504	VESTRE VROC	OM WALL MOUNT WITH ARMRESTS	VESTRE	620-901MKLS28	HOT-DIP GALVANISED AND POWDER-COA CLEAR WOOD SEAT MATERIAL	TED STEEL MOUNTING MATER	IAL, KEBONY	MKL (WALL-MOUNT LOW)	BRACKETS
	NCH TYPE 3 - CURVED BENCH IN SQUARE EC: 32 33 00	1/L501	CUSTOM CUR	VED BENCH	VESTRE	630MKL D4	HOT-DIP GALVANISED AND POWDER-COA CLEAR WOOD SEAT MATERIAL	TED STEEL MOUNTING MATER	IAL, KEBONY	MKL (WALL-MOUNT LOW)	BRACKETS
SE-U/	NCH TYPE 4 - FREESTANDING BENCH EC: 32 33 00	5/L503	VESTRE VROC ARMRESTS AN	OM FREESTANDING BENCH WITH ND BACK	VESTRE	617	HOT-DIP GALVANISED AND POWDER-COA CLEAR WOOD SEAT MATERIAL	TED STEEL MOUNTING MATER	IAL, KEBONY		
SF-08 WA	NCH TYPE 5 - PROMENADE CUSTOM CURVED ALL MOUNT BENCH EC: 32 33 00	1	CUSTOM CUR	VED SEATWALL BENCH	VESTRE	620-901MKL2	HOT-DIP GALVANISED AND POWDER-COA (STANDARD)	TED, LINSEED OIL PROOFED N	ORDIC PINE	MKL (WALL-MOUNT LOW)	BRACKETS
	OMENADE BAR STOOL EC: 32 33 00	4/L503	APRIL BAR CH	AIR	VESTRE	78-900C	HOT-DIP GALVANISED AND POWDER-COA LINSEED OIL PROOFED NORDIC PINE SEA		COLOR TBD AND	ANCHORING USING TYPE	C - CONCRETING
SE-10	IRONDACK CHAIRS EC: 32 33 00	1	ADIRONDACK	CHAIR WITH CUSTOM LOCKING	LOLL	ADIRONDACK (FLAT)	COLOR TBD			OWNER FURNISHED CON	TRACTOR
SF-10 SPE		2/L503	VROOM LITTE	R BIN	VESTRE	644-900	HOT-DIP GALVANISED AND POWDER-COA	TED COLOR TBD		OWNER FURNISHED CON	TRACTOR
SF-10 SPE SF-11 ADI SPE TRA	ASH RECEPTACLE FC: 32 33 00	2/1505			VESTRE	686-904A	POWDER-COATED ALUMINUM, COLOR TBI)		OWNER FURNISHED CON	TRACTOR
SF-10 SPE SF-11 ADI SPE SF-12 TRA SPE SF-13 REG	EC: 32 33 00 CYCLING RECEPTACLE 5	/	VROOM BICYC	CLE RACK	1-3		i			INSTALLED	
SF-10 SPE SF-11 SPE SF-12 TRA SPE SF-13 REG SPE SF-14 BEN	EC: 32 33 00 CYCLING RECEPTACLE EC: 32 33 00 NCH TABLES MODULE	/		OM COFEE TABLE MODULE	VESTRE	639	HOT-DIP GALVANISED STEEL, COLOR TBD			OWNER FURNISHED CON	TRACTOR
SF-10 SPE SF-11 SPE SF-12 TRA SPE SF-13 REG SPE SF-14 SPE	EC: 32 33 00 CYCLING RECEPTACLE EC: 32 33 00 NCH TABLES MODULE EC: 32 33 00 4	1	CUSTOM VRO	OM COFEE TABLE MODULE	VESTRE	639	HOT-DIP GALVANISED STEEL, COLOR TBD				TRACTOR
SF-10 SPE SF-11 SPE SF-12 TRA SPE SF-13 REG SPE SF-14 SPE SYMBOL SIG	EC: 32 33 00 CYCLING RECEPTACLE EC: 32 33 00 NCH TABLES MODULE EC: 32 33 00 4	<i>I I</i>	CUSTOM VROO	OM COFEE TABLE MODULE DFILE/ASSEMBLY		639	HOT-DIP GALVANISED STEEL, COLOR TBD			OWNER FURNISHED CON	TRACTOR

North field

CITY OF NORTHFIELD

Minnesota

801 WASHINGTON STREET
NORTHFIELD, MINNESOTA 55057
DAVID.BENNETT@CI.NORTHFIELD.MN.US

DAMON FARBER LANDSCAPE ARCHITECTS 310 S 4TH AVE MINNEAPOLIS, MN 55415 RBLASEG@DAMONFARBER.COM 612.332.7522

BOLTON & MENK
7575 GOLDEN VALLEY ROAD
SUITE 200
MINNEAPOLIS, MN 55427
BRADLEY.FISHER@BOLTON-MENK.COM
612.759.7240

NELSON-RUDIE & ASSOCIATES, 9100 49TH AVE N, MINNEAPOLIS, MN 55428 SARAH.GREFF@NELSONRUDIE.COM

SCHULER & SHOOK
219 SE MAIN ST
MINNEAPOLIS, MN 55414
PWHITAKER@SCHULERSHOOK.COM
612.339.5958

763.367.7600

60% PRICING SET

NORTHFIELD BRIDGE SQUARE

NORTHFIELD, MN

I hereby certify that this document was prepared by me or under my direct supervision and that I am a duly licensed Landscape Architect under the laws of the State of Minnesota.

Tom Whitlock

AS SHOWN

RP/AG/BE/RB

26292

 Signature
 Date

 09/26/2023

 DF/ Project #
 22-184

Registration#

Drawn/Checked

REVISION

SITE MATERIALS SCHEDULE

SITE TREE SCHEDULE

TREES	CODE	QTY	BOTANICAL / COMMON NAME	SIZE	CONT.	DETAIL	REMARKS
•	PS2	5	PINUS SYLVESTRIS SCOTCH PINE	12` HEIGHT	CONT.		
	PT2	11	POPULUS TREMULOIDES QUAKING ASPEN	4" CAL.	B&B		
	QR	4	QUERCUS RUBRA RED OAK	5" CAL.	B&B		
Service of the servic	ТВ	4	TILIA AMERICANA `BOULEVARD` BOULEVARD LINDEN	5" CAL.	B&B		
DECIDUOUS TREES	CODE	QTY	BOTANICAL / COMMON NAME	SIZE	CONT.	DETAIL	REMARKS
	GI	9	GLEDITSIA TRIACANTHOS INERMIS `SKYCOLE` TM SKYLINE THORNLESS HONEY LOCUST	5" CAL.	B&B		

SITE UNDERSTORY PLANTING SCHEDULE

DITE ONDERSTORT FEARTING SCHEDOLE											
SHRUBS	CODE	QTY	BOTANICAL / COMMON NAME	SIZE	CONT.	SPACING	DETAIL	REMARKS			
\odot	ВІ	29	BAPTISIA X 'INDIGO SPIRES' INDIGO SPIRES WILD INDIGO	#1	CONT.	36" o.c.					
GROUND COVERS	CODE	QTY	BOTANICAL / COMMON NAME	SIZE	CONT.	SPACING	REMARKS				
		3,684 SF	SHADE TOLERANT LAWN								
		1,938 SF	STREETSCAPE PLANTERS								
	EP	101	ECHINACEA PURPUREA CONEFLOWER	#1	CONT.	20% @ 24" o.c.					
	LA3	101	LIATRIS ASPERA ROUGH BLAZING STAR	#1	CONT.	20% @ 24" o.c.					
	NW2	101	NEPETA X 'WALKER'S LOW' WALKER'S LOW CATMINT	#1	CONT.	20% @ 24" o.c.					
	RB	101	RUDBECKIA FULGIDA CONEFLOWER	#1	CONT.	20% @ 24" o.c.					
	SH3	101	SPOROBOLUS HETEROLEPIS PRAIRIE DROPSEED	#1	CONT.	20% @ 24" o.c.					
		5,716 SF	PERENNIAL MIX								
	AM3	529	ALLIUM X `MILLENIUM` MILLENIUM ORNAMENTAL ONION	#1	CONT.	20% @ 18" o.c.					
	CP2	298	CAREX PENSYLVANICA PENNSYLVANIA SEDGE	#1	CONT.	20% @ 24" o.c.					
	GT2	223	GEUM TRIFLORUM PRAIRIE SMOKE	#1	CONT.	15% @ 24" o.c.					
	MD	143	MONARDA DIDYMA BEE BALM	#1	CONT.	15% @ 30" o.c.					
	NW3	223	NEPETA X 'WALKER'S LOW' WALKER'S LOW CATMINT	#1	CONT.	15% @ 24" o.c.					
	ZA2	223	ZIZIA AUREA GOLDEN ALEXANDER	#1	CONT.	15% @ 24" o.c.					
* * * * * * * * * * * * * * * * * * *	TD2	6,158 SF	TURF SEED DROUGHT TOLERANT DWARF FESCUE BLEND	SEED & PLUG	SEED						



Minnesota

CITY OF NORTHFIELD

801 WASHINGTON STREET
NORTHFIELD, MINNESOTA 55057
DAVID.BENNETT@CI.NORTHFIELD.MN.US

DAMON FARBER
LANDSCAPE ARCHITECTS
310 S 4TH AVE

310 S 4TH AVE
MINNEAPOLIS, MN 55415
RBLASEG@DAMONFARBER.COM
612.332.7522

BOLTON & MENK
7575 GOLDEN VALLEY ROAD
SUITE 200
MINNEAPOLIS, MN 55427
BRADLEY.FISHER@BOLTON-MENK.COM
612.759.7240

NELSON-RUDIE & ASSOCIATES, 9100 49TH AVE N, MINNEAPOLIS, MN 55428 SARAH.GREFF@NELSONRUDIE.COM 763.367.7600

SCHULER & SHOOK
219 SE MAIN ST
MINNEAPOLIS, MN 55414
PWHITAKER@SCHULERSHOOK.COM

612.339.5958

60% PRICING SET

NORTHFIELD BRIDGE SQUARE

NORTHFIELD, MN

I hereby certify that this document was prepared by me or under my direct supervision and that I am a duly licensed Landscape Architect under the laws of the State of Minnesota.

Name Tom Whitlock
Registration# 26292

Date

RP/AG/BE/RB

 DF/ Project #
 22-184

 Scale
 AS SHOWN

Drawn/Checked

Signature

REVISION PORTON

SITE LANDSCAPE SCHEDULE

SITE SOIL SCHEDULE

	DESCRIPTION	QTY	DEPTH	COMPOSITION	IRRIGATION	NOTES	SUBGRADE PREPARATION
SP-01	SOIL TYPE 01 - HIGH USE LAWN MIX	499.51 CY	6"	60% COARSE SAND, 30% LOAM TOPSOIL, 10% COMPOST	SPRAY		DEEP TILL, AMEND W/ 1" ORGANIC COMPOST
SP-02	SOIL TYPE 02 - 18" DEPTH PLANTING SOIL	309.34 CY	18"	60% COARSE SAND, 25-30% LOAM, 10-15% COMPOST	DRIP	3" THK FINELY SHREDDED HARDWOOD MULCH, JUTE ECB ON SLOPES 3:1 OR STEEPER	DEEP TILL, AMEND W/ 1" ORGANIC COMPOST
SP-03	SOIL TYPE 03 - 36" DEPTH PLANTING SOIL	319.39 CY	36"	60% COARSE SAND, 25-30% LOAM, 10-15% COMPOST	DRIP	3" THK FINELY SHREDDED HARDWOOD MULCH, JUTE ECB ON SLOPES 3:1 OR STEEPER	DEEP TILL, AMEND W/ 1" ORGANIC COMPOST
SP-04	SOIL TYPE 04 - SOIL PREP BELOW EXISTING TREES	10.59 CY		AMEND INSITU SOILS - HAND WORK BELOW TREES, TOP DRESS 1/2" OF COMPOST AND BIOCHAR (50/50)		WHERE PLANTING IS TO OCCUR BELOW DRIPLINES, PREPARE SOILS WITH PNUEMATIC SOIL TOOL/AIR SPADE	NONE- DO NOT DISTURB
SP-05	SOIL TYPE 05 - SAND-BASED STRUCTURAL SOIL	146.3 CY	36"	91-94% COARSE SAND, 4-5% PEAT, 2-4% PEAT	DRIP	3" THK PINE BARK MULCH BELOW PINE TREES- SEE DETAILS	DEEP TILL, AMEND W/ 1" ORGANIC COMPOST

SITE IRRIGATION SCHEDULE

SYMBOL	DESCRIPTION	QTY	MATERIAL PROFILE	MANUFACTURER	PRODUCT/MODEL	COMMENTS
	SITE IRRIGATION TYPE 01	7,476 SF	DRIP IRRIGATION	PER OWNER	HIGH-EFFCIENCY	PER OWNER
U-02	SITE IRRIGATION TYPE 02	9,729 SF	POP-UP SPRAY IRRIGATION	PER OWNER	HIGH-EFFICIENCY HEADS	PER OWNER
U-03	SITE IRRIGAITON TYPE 03	933 SF	BUBBLER IRRIGATION	PER OWNER	HIGH-EFFICIENCY HEADS	
U-04	SITE IRRIGATION - QUICK COUPLER	6	QUICK COUPLER FOR HOSE HOOK UP	PER OWNER	PER OWNER	



Minnesota CITY OF NORTHFIELD

801 WASHINGTON STREET NORTHFIELD, MINNESOTA 55057 DAVID.BENNETT@CI.NORTHFIELD.MN.US

DAMON FARBER LANDSCAPE ARCHITECTS
310 S 4TH AVE
MINNEAPOLIS, MN 55415
RBLASEG@DAMONFARBER.COM
612.332.7522

BOLTON & MENK
7575 GOLDEN VALLEY ROAD

SUITE 200 MINNEAPOLIS, MN 55427 BRADLEY.FISHER@BOLTON-MENK.COM 612.759.7240

NELSON-RUDIE & ASSOCIATES, 9100 49TH AVE N, MINNEAPOLIS, MN 55428 SARAH.GREFF@NELSONRUDIE.COM 763.367.7600

SCHULER & SHOOK
219 SE MAIN ST
MINNEAPOLIS, MN 55414
PWHITAKER@SCHULERSHOOK.COM 612.339.5958

60% PRICING SET

NORTHFIELD BRIDGE SQUARE

NORTHFIELD, MN


I hereby certify that this document was prepared by me or under my direct supervision and that I am a duly licensed Landscape Architect under the laws of the State of Minnesota.

Tom Whitlock


26292

Date Signature 09/26/2023 22-184 DF/ Project # AS SHOWN RP/AG/BE/RB Drawn/Checked

Registration#

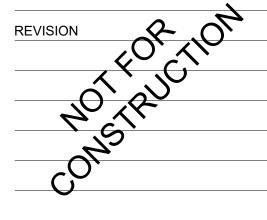

SITE SCHEDULES

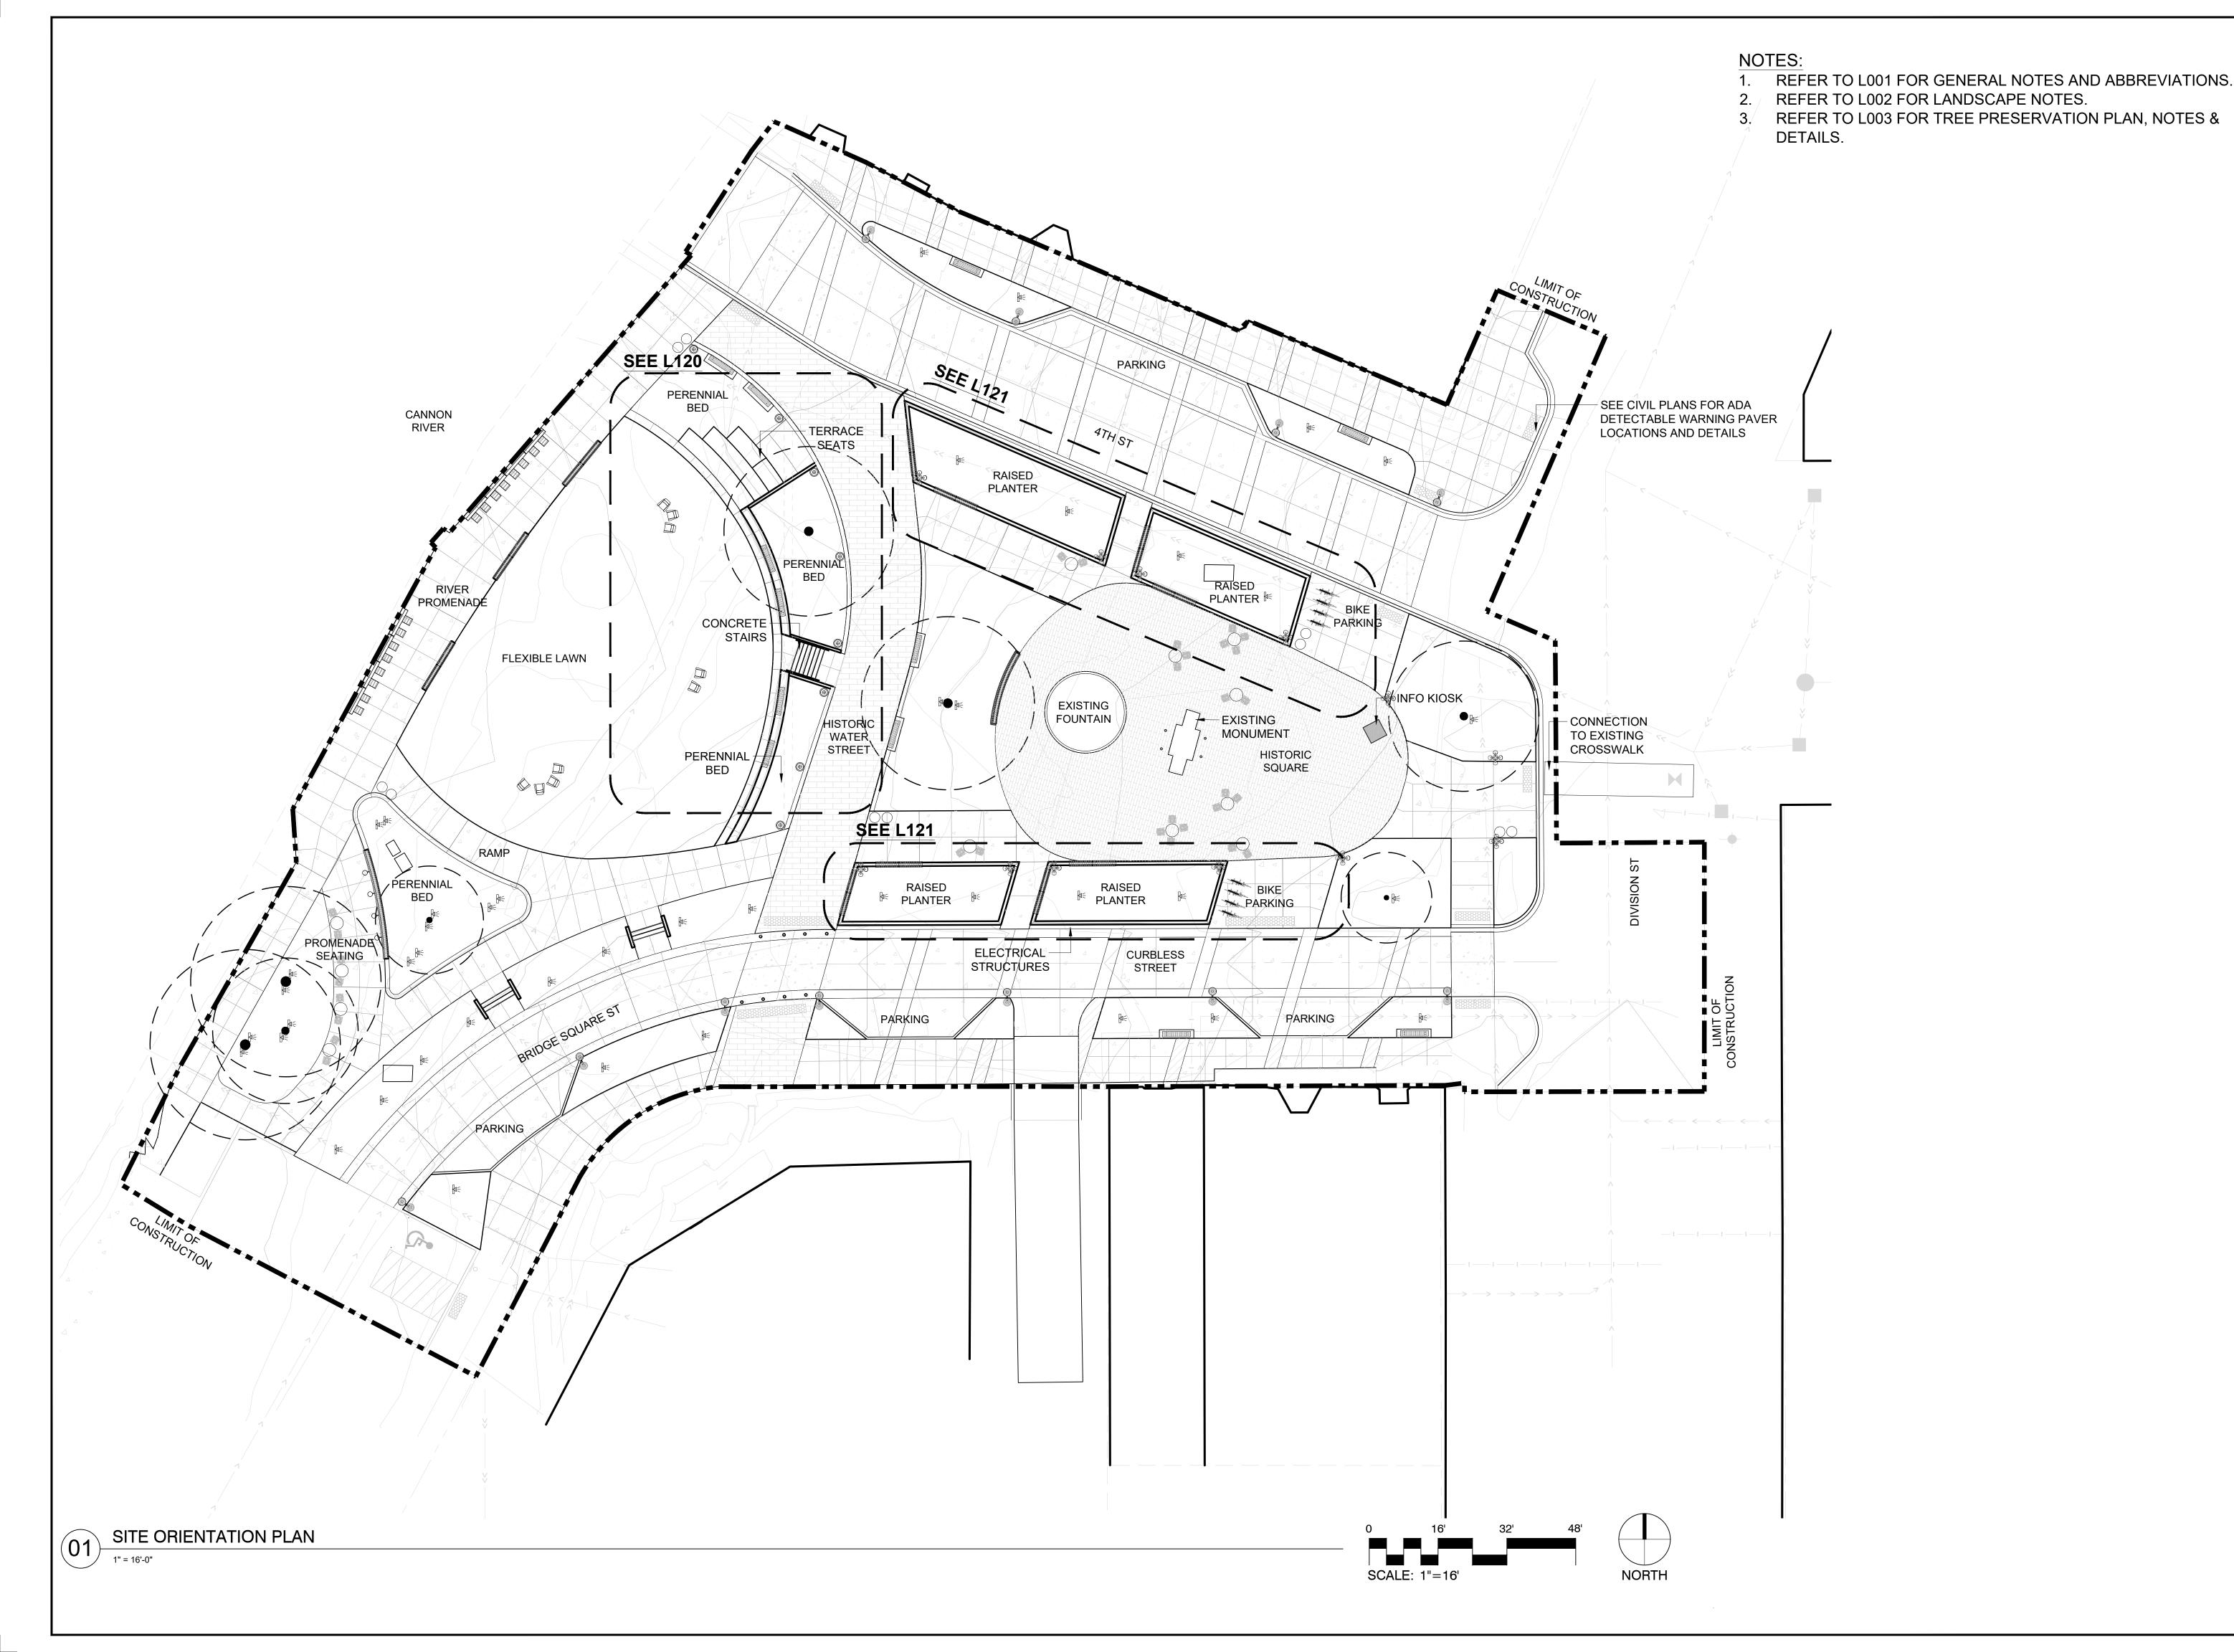

Minnesota

CITY OF NORTHFIELD 801 WASHINGTON STREET

NORTHFIELD, MINNESOTA 55057 DAVID.BENNETT@CI.NORTHFIELD.MN.US

DAMON FARBER LANDSCAPE ARCHITECTS

310 S 4TH AVE
MINNEAPOLIS, MN 55415
RBLASEG@DAMONFARBER.COM
612.332.7522

BOLTON & MENK 7575 GOLDEN VALLEY ROAD

SUITE 200 MINNEAPOLIS, MN 55427 BRADLEY.FISHER@BOLTON-MENK.COM 612.759.7240

NELSON-RUDIE & ASSOCIATES,

9100 49TH AVE N, MINNEAPOLIS, MN 55428 SARAH.GREFF@NELSONRUDIE.COM 763.367.7600

SCHULER & SHOOK 219 SE MAIN ST

MINNEAPOLIS, MN 55414 PWHITAKER@SCHULERSHOOK.COM 612.339.5958

60% PRICING SET

NORTHFIELD BRIDGE SQUARE

NORTHFIELD, MN

I hereby certify that this document was prepared by me or under my direct supervision and that I am a duly licensed Landscape Architect under the laws of the State of Minnesota.


Registration#

Tom Whitlock

26292

Date Signature 09/26/2023 22-184 DF/ Project # AS SHOWN RP/AG/BE/RB Drawn/Checked

SITE ORIENTATION PLAN

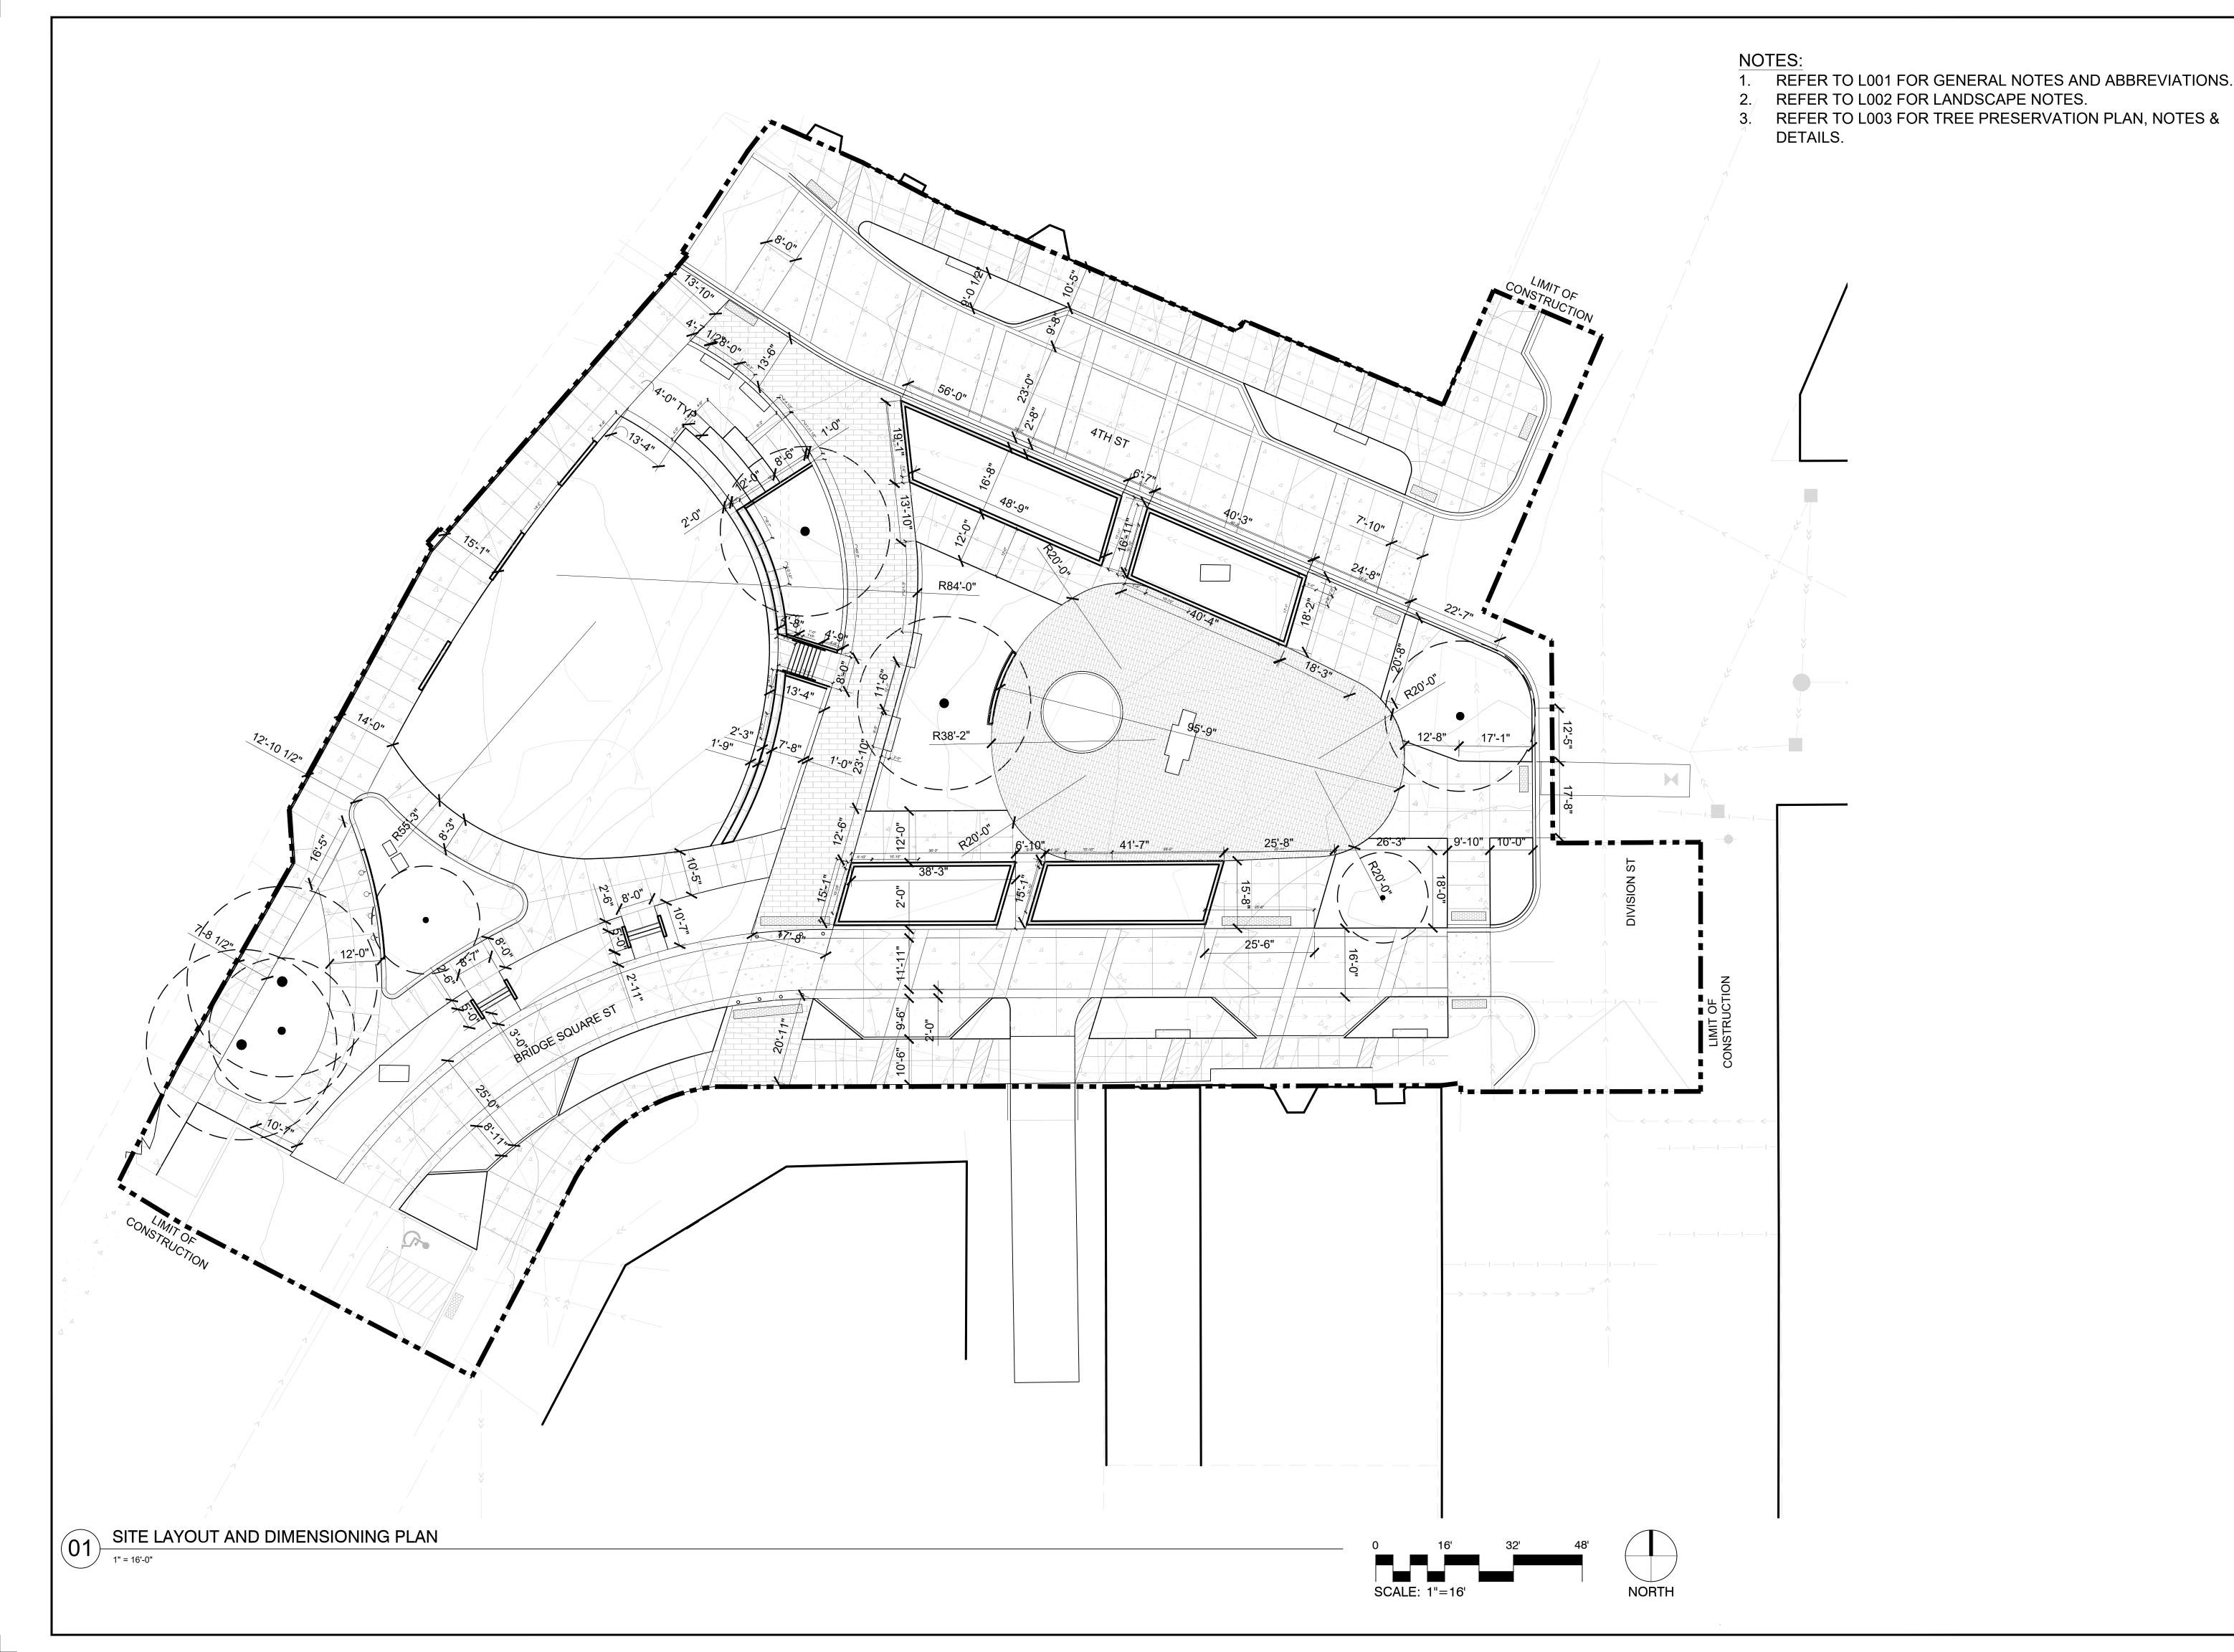



Minnesota

CITY OF NORTHFIELD

801 WASHINGTON STREET NORTHFIELD, MINNESOTA 55057 DAVID.BENNETT@CI.NORTHFIELD.MN.US

DAMON FARBER

LANDSCAPE ARCHITECTS
310 S 4TH AVE
MINNEAPOLIS, MN 55415
RBLASEG@DAMONFARBER.COM
612.332.7522

BOLTON & MENK
7575 GOLDEN VALLEY ROAD
SUITE 200
MINNEAPOLIS, MN 55427
BRADLEY.FISHER@BOLTON-MENK.COM 612.759.7240

NELSON-RUDIE & ASSOCIATES, 9100 49TH AVE N, MINNEAPOLIS, MN 55428 SARAH.GREFF@NELSONRUDIE.COM 763.367.7600

SCHULER & SHOOK
219 SE MAIN ST
MINNEAPOLIS, MN 55414
PWHITAKER@SCHULERSHOOK.COM
612.339.5958

60% PRICING SET

NORTHFIELD BRIDGE SQUARE

NORTHFIELD, MN


I hereby certify that this document was prepared by me or under my direct supervision and that I am a duly licensed Landscape Architect under the laws of the State of Minnesota.

Registration#

Tom Whitlock

26292 Signature 09/26/2023 22-184 DF/ Project # AS SHOWN RP/AG/BE/RB Drawn/Checked

SITE LAYOUT AND DIMENSIONING PLAN

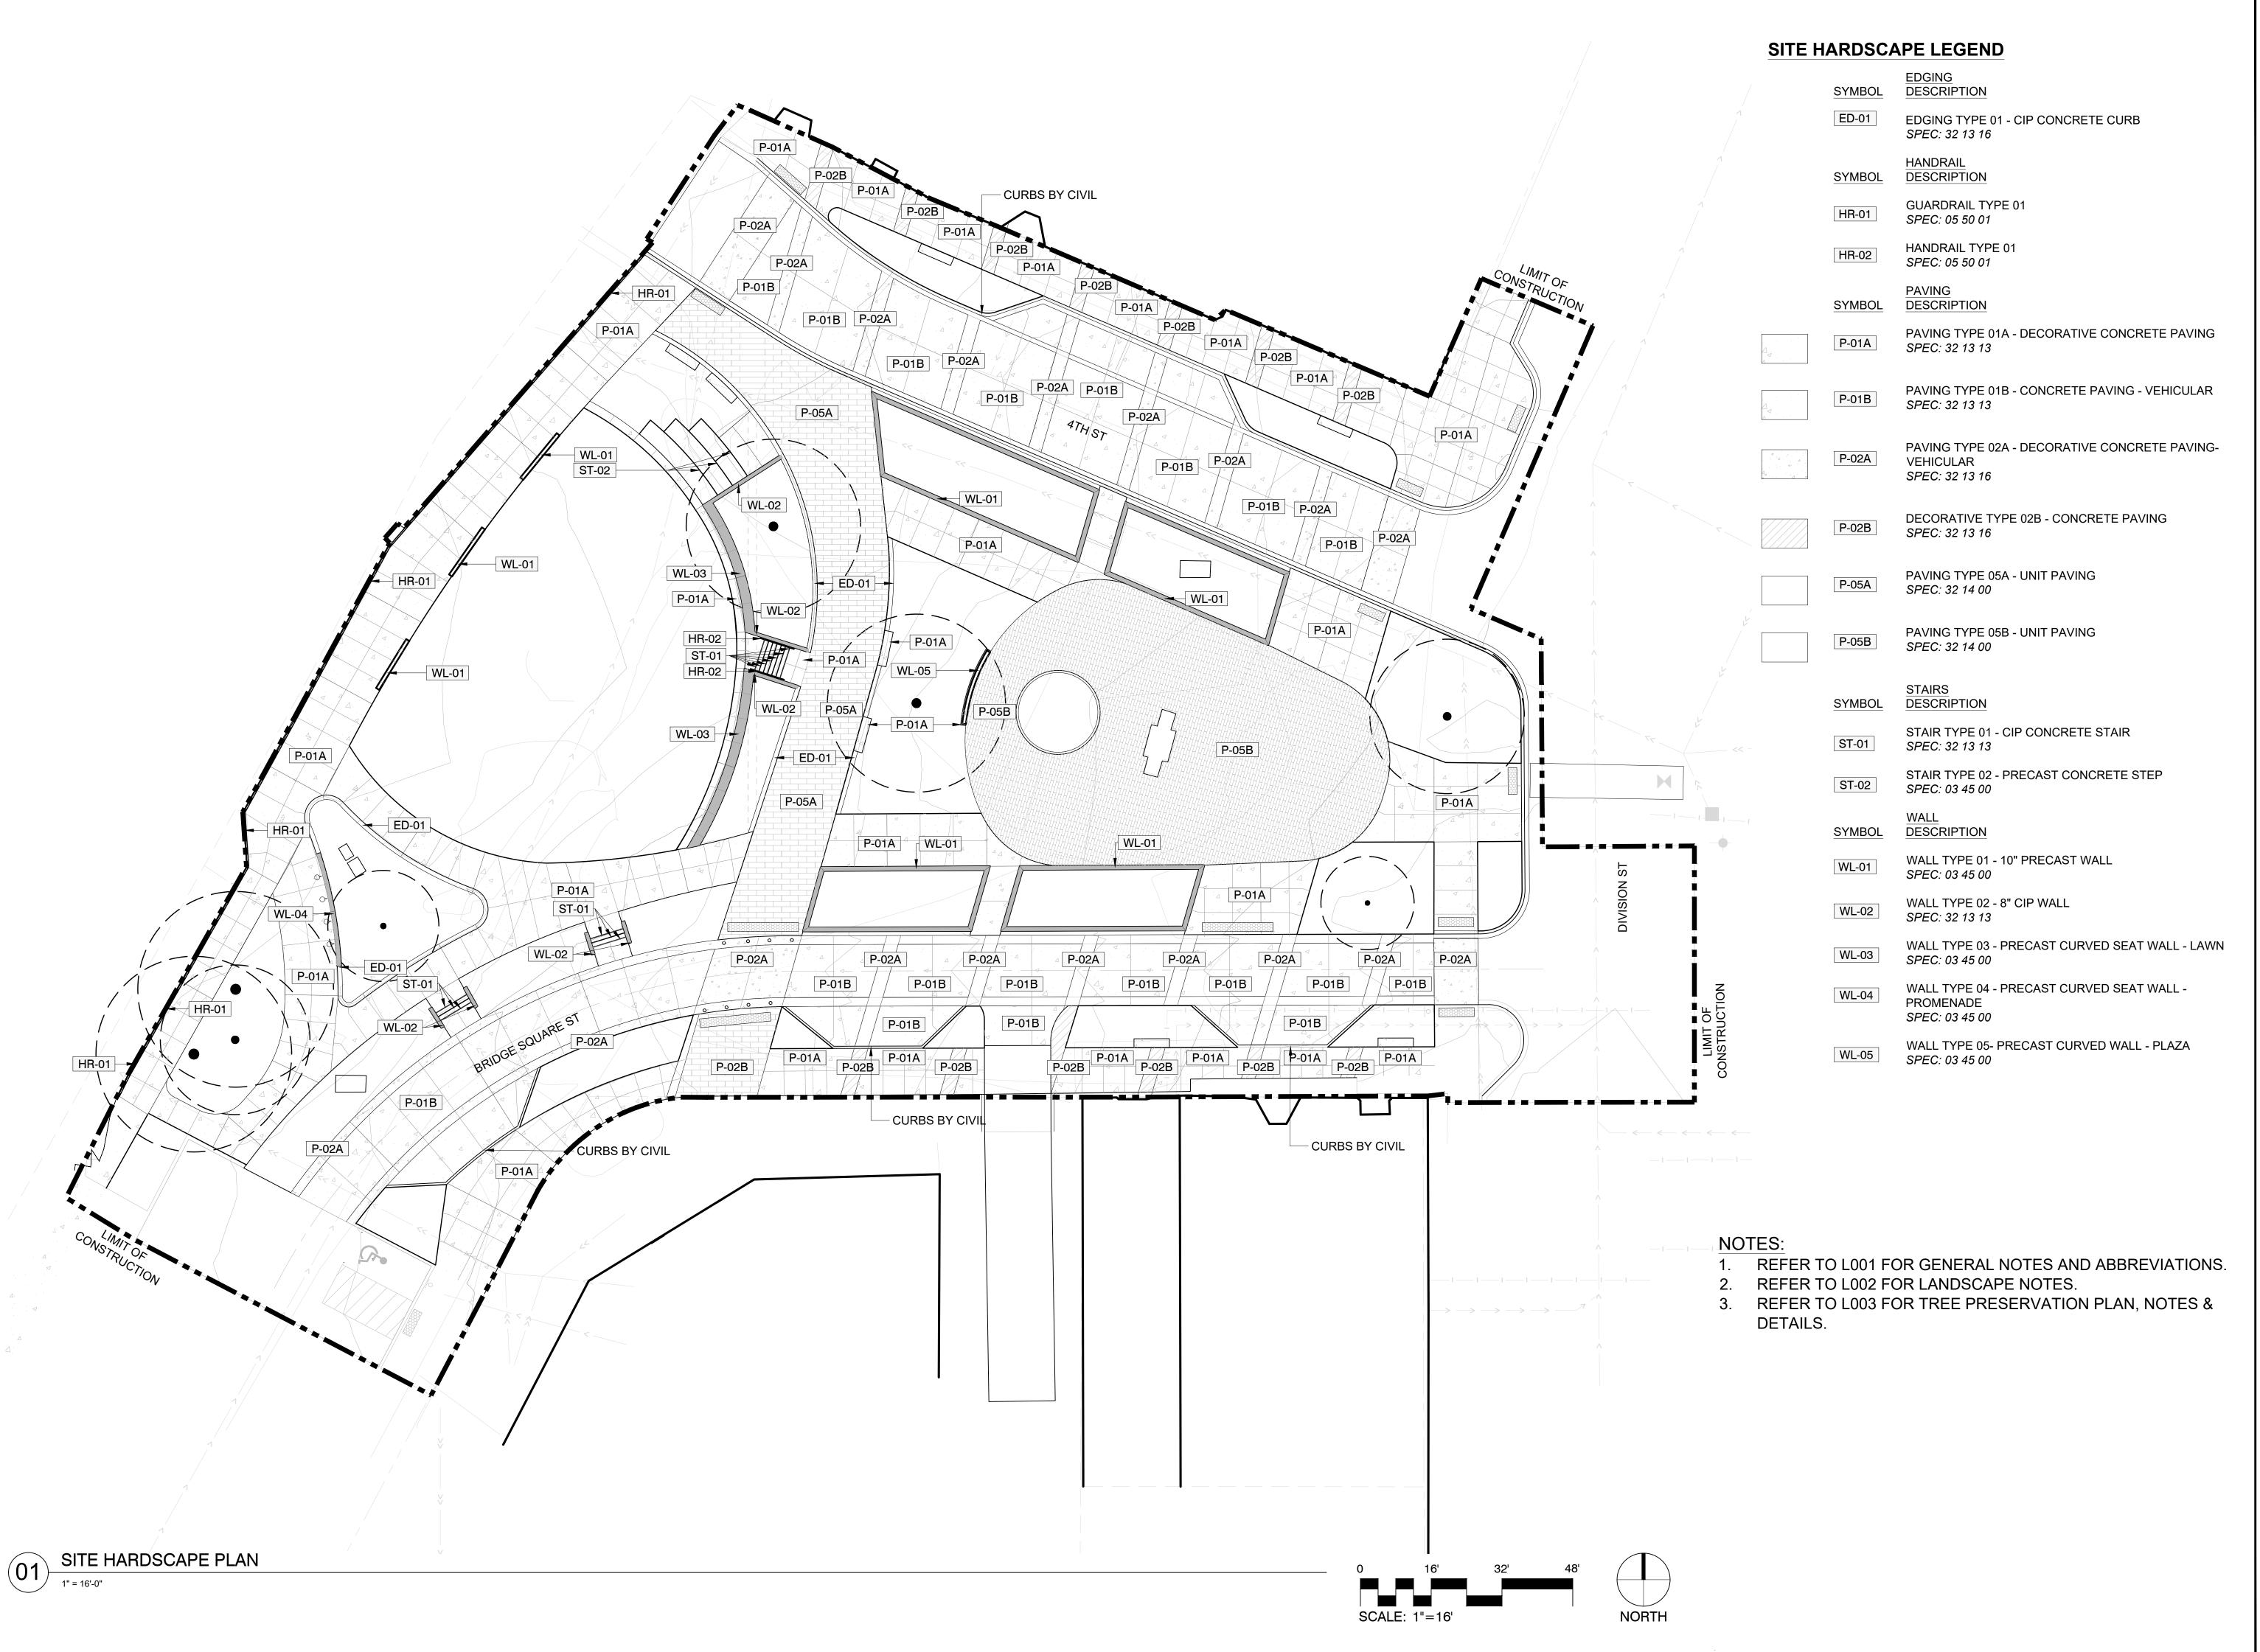

North field

CITY OF NORTHFIELD

Minnesota

801 WASHINGTON STREET
NORTHFIELD, MINNESOTA 55057
DAVID.BENNETT@CI.NORTHFIELD.MN.US

DAMON FARBER LANDSCAPE ARCHITECTS 310 S 4TH AVE

BOLTON & MENK

MINNEAPOLIS, MN 55415 RBLASEG@DAMONFARBER.COM 612.332.7522

7575 GOLDEN VALLEY ROAD SUITE 200 MINNEAPOLIS, MN 55427 BRADLEY.FISHER@BOLTON-MENK.COM 612.759.7240

NELSON-RUDIE & ASSOCIATES, 9100 49TH AVE N, MININEAROUS, MAI 55428

MINNEAPOLIS, MN 55428 SARAH.GREFF@NELSONRUDIE.COM 763.367.7600

SCHULER & SHOOK

219 SE MAIN ST MINNEAPOLIS, MN 55414 PWHITAKER@SCHULERSHOOK.COM 612.339.5958

60% PRICING SET

NORTHFIELD BRIDGE SQUARE

NORTHFIELD, MN

I hereby certify that this document was prepared by me or under my direct supervision and that I am a duly licensed Landscape Architect under the laws of the State of Minnesota.

Tom Whitlock

26292

Signature Date

09/26/2023

DF/ Project # 22-184


Scale AS SHOWN

Drawn/Checked RP/AG/BE/RB

Registration#

REVISION

SITE HARDSCAPE PLAN

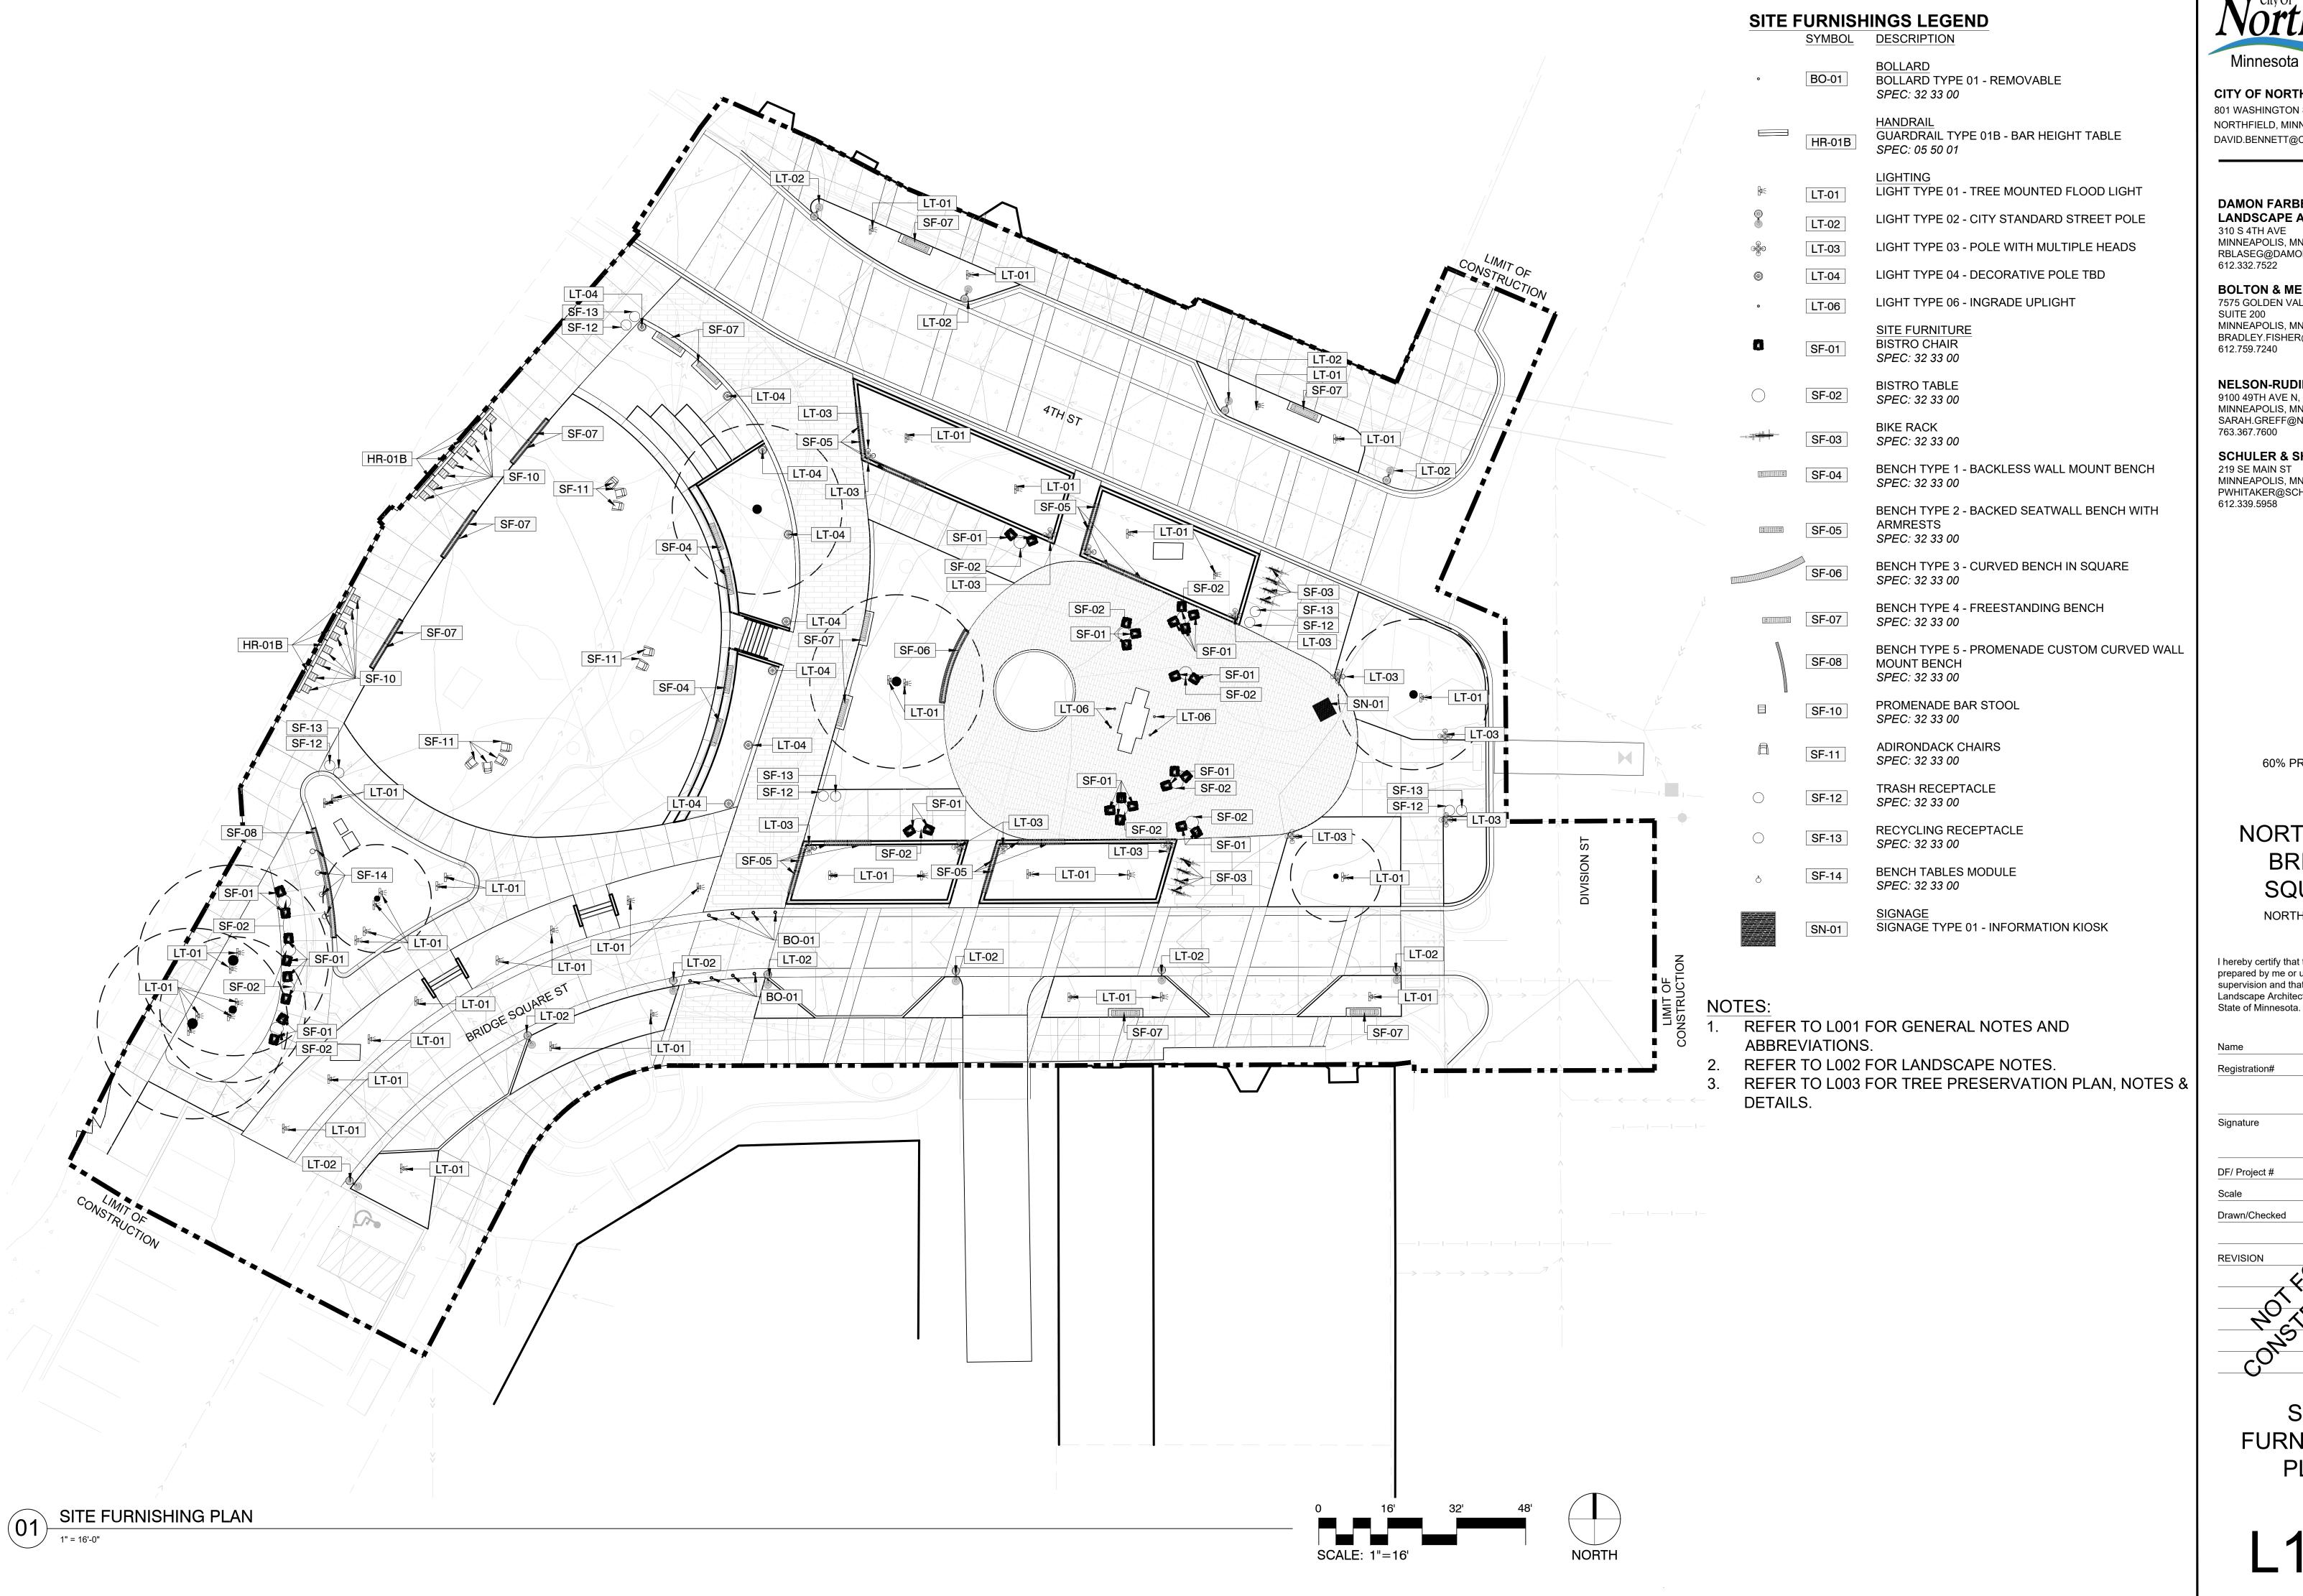

CITY OF NORTHFIELD

801 WASHINGTON STREET NORTHFIELD, MINNESOTA 55057 DAVID.BENNETT@CI.NORTHFIELD.MN.US

DAMON FARBER LANDSCAPE ARCHITECTS 310 S 4TH AVE

MINNEAPOLIS, MN 55415 RBLASEG@DAMONFARBER.COM 612.332.7522

BOLTON & MENK 7575 GOLDEN VALLEY ROAD SUITE 200 MINNEAPOLIS, MN 55427

BRADLEY.FISHER@BOLTON-MENK.COM 612.759.7240

NELSON-RUDIE & ASSOCIATES, 9100 49TH AVE N, MINNEAPOLIS, MN 55428 SARAH.GREFF@NELSONRUDIE.COM

SCHULER & SHOOK

MINNEAPOLIS, MN 55414 PWHITAKER@SCHULERSHOOK.COM 612.339.5958

60% PRICING SET

NORTHFIELD BRIDGE SQUARE

NORTHFIELD, MN

I hereby certify that this document was prepared by me or under my direct supervision and that I am a duly licensed Landscape Architect under the laws of the

Tom Whitlock

26292 Registration# Date Signature 09/26/2023 22-184 DF/ Project # **AS SHOWN** RP/AG/BE/RB Drawn/Checked

> SITE FURNISHING PLAN



NOTES:

- 1. REFER TO L001 FOR GENERAL NOTES AND ABBREVIATIONS.
- 2. REFER TO L002 FOR LANDSCAPE NOTES.
- 3. REFER TO L003 FOR TREE PRESERVATION PLAN, NOTES & DETAILS.
- 4. PROVIDE SHOP DRAWINGS FOR JOINTING LAYOUTS.



Minnesota

CITY OF NORTHFIELD

801 WASHINGTON STREET

NORTHFIELD, MINNESOTA 55057

DAVID.BENNETT@CI.NORTHFIELD.MN.US

DAMON FARBER
LANDSCAPE ARCHITECTS

310 S 4TH AVE
MINNEAPOLIS, MN 55415
RBLASEG@DAMONFARBER.COM
612.332.7522

BOLTON & MENK
7575 GOLDEN VALLEY ROAD
SUITE 200

SUITE 200
MINNEAPOLIS, MN 55427
BRADLEY.FISHER@BOLTON-MENK.COM
612.759.7240

NELSON-RUDIE & ASSOCIATES,

9100 49TH AVE N, MINNEAPOLIS, MN 55428 SARAH.GREFF@NELSONRUDIE.COM 763.367.7600

SCHULER & SHOOK 219 SE MAIN ST

MINNEAPOLIS, MN 55414
PWHITAKER@SCHULERSHOOK.COM
612.339.5958

60% PRICING SET

NORTHFIELD BRIDGE SQUARE


NORTHFIELD, MN

I hereby certify that this document was prepared by me or under my direct supervision and that I am a duly licensed Landscape Architect under the laws of the State of Minnesota.

Tom Whitlock


RP/AG/BE/RB

Registration#	26292
Signature	Date
	09/26/2023
DF/ Project #	22-184
Scale	AS SHOWN

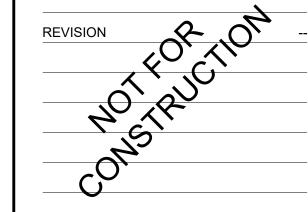

Drawn/Checked

PLAN ENLARGEMENT -LAWN TERRACE

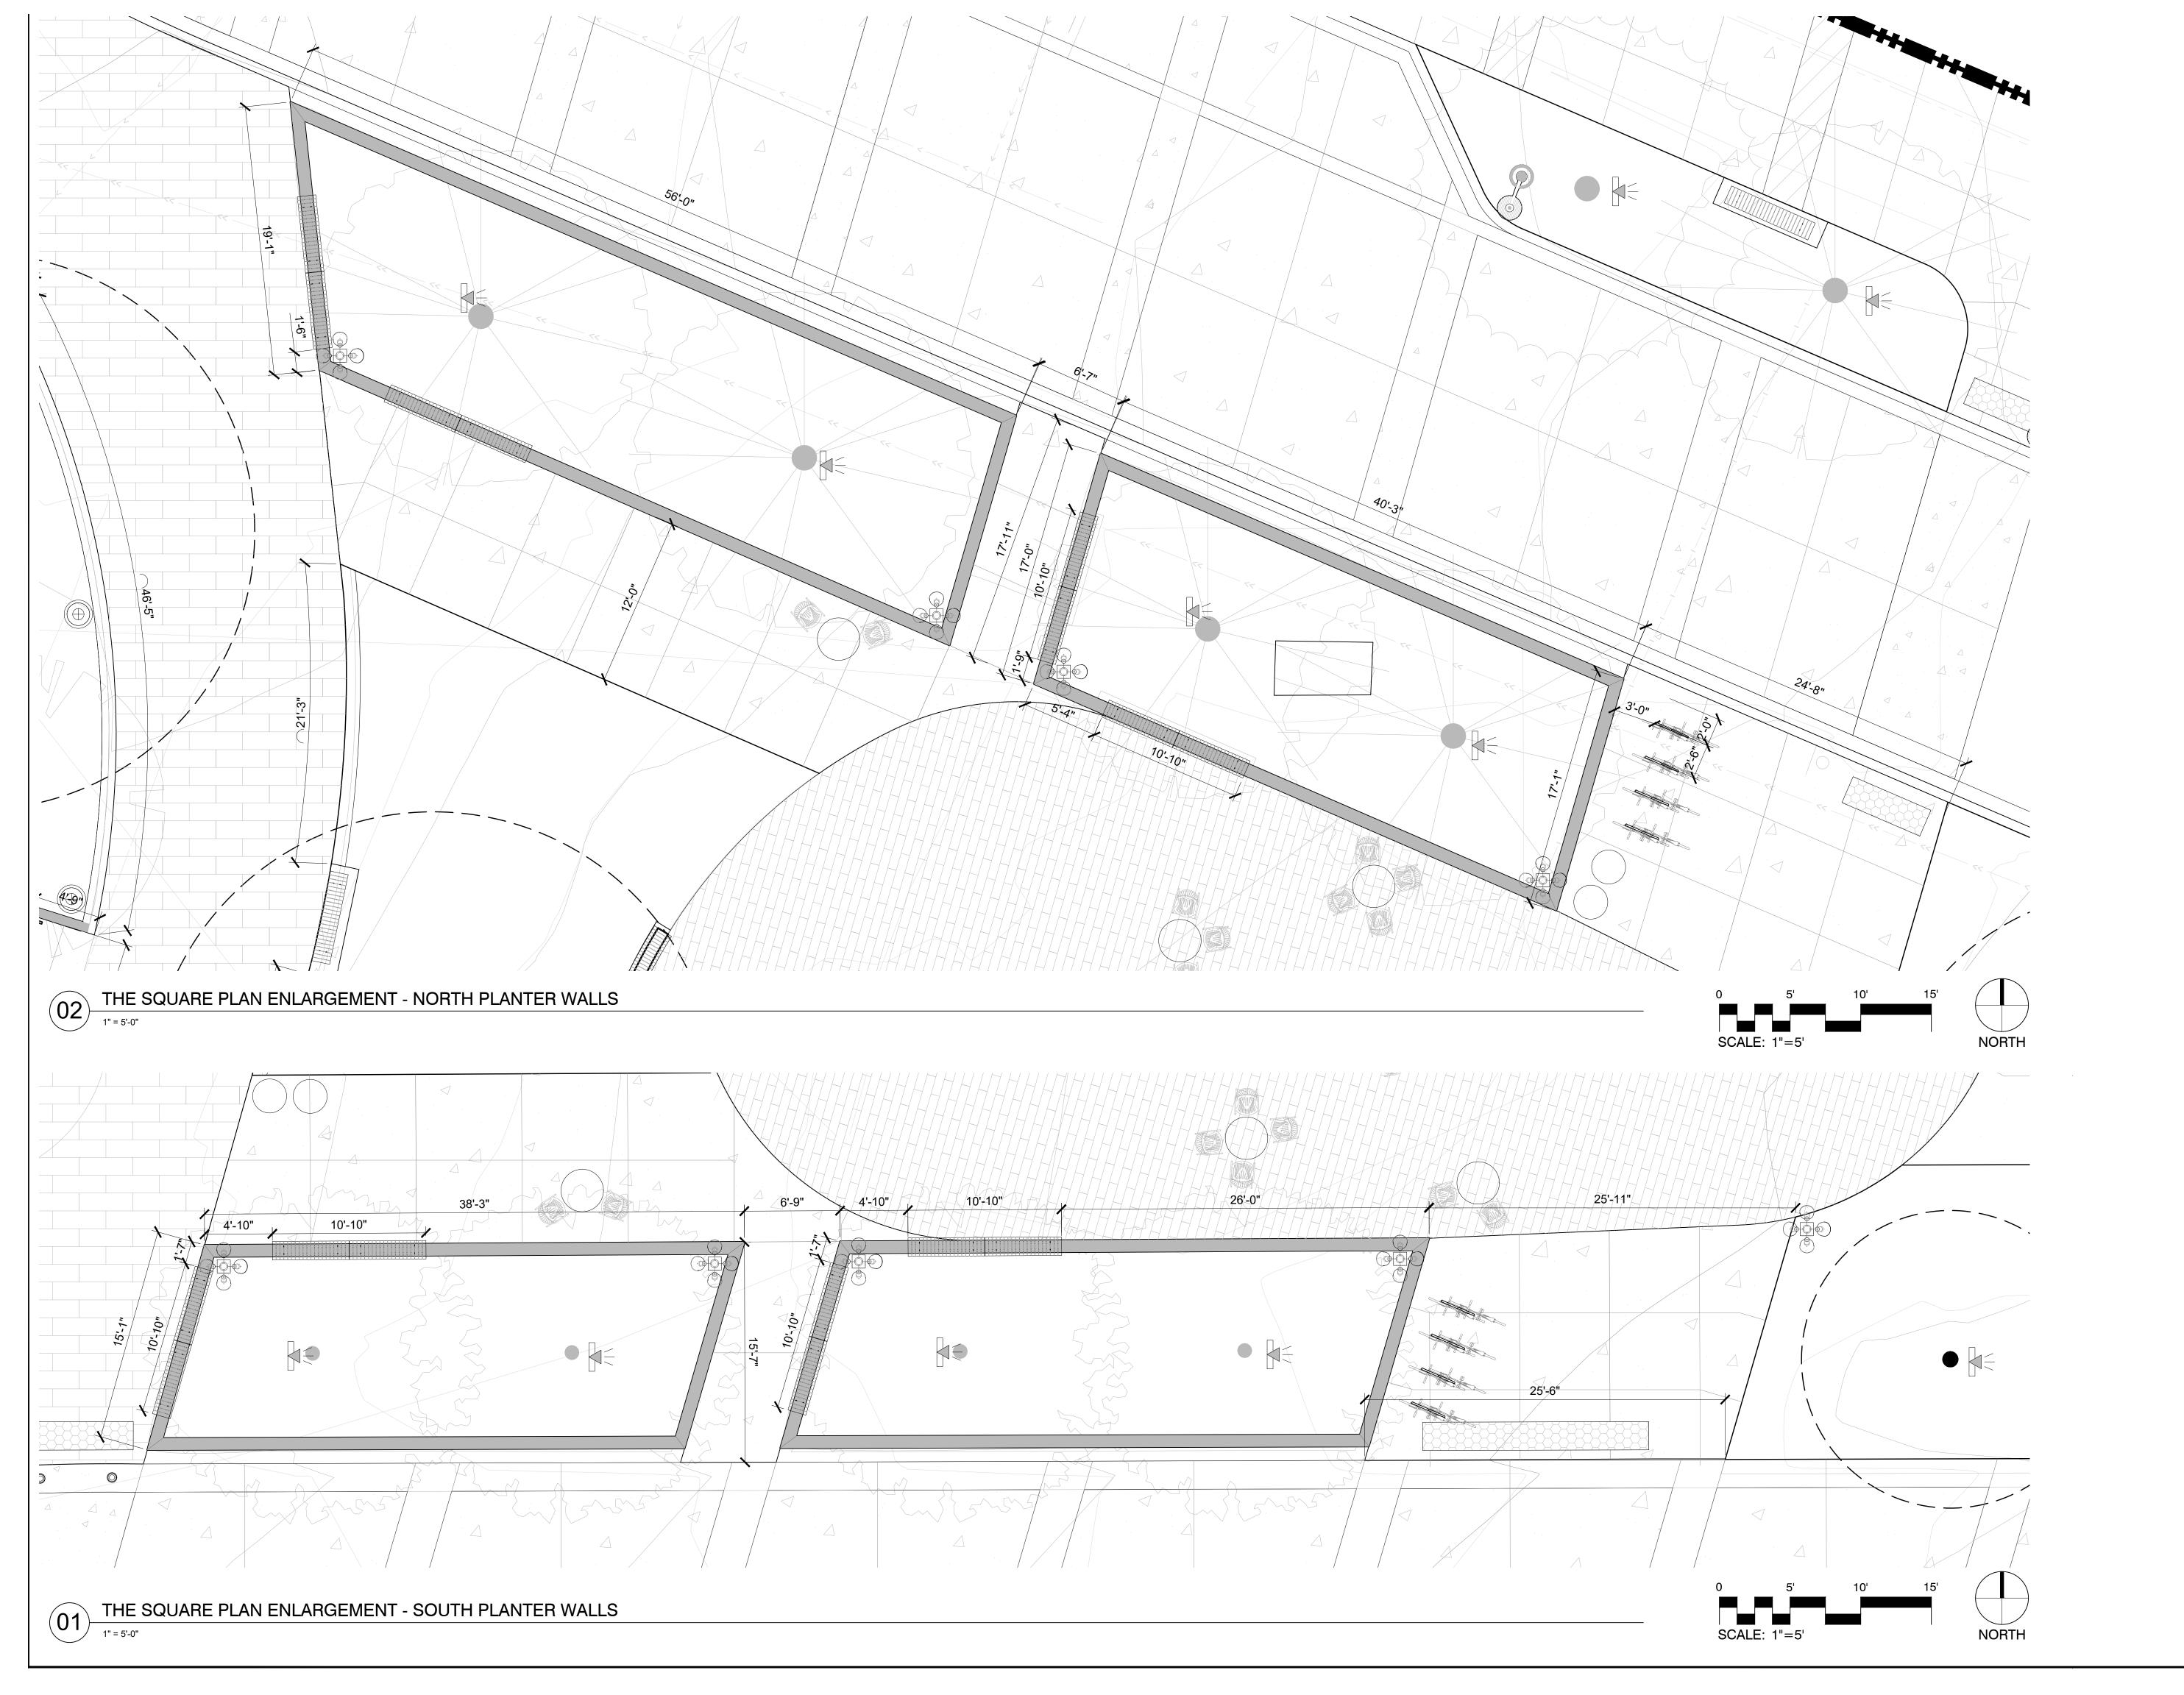



Minnesota

CITY OF NORTHFIELD 801 WASHINGTON STREET

NORTHFIELD, MINNESOTA 55057

DAVID.BENNETT@CI.NORTHFIELD.MN.US

DAMON FARBER LANDSCAPE ARCHITECTS 310 S 4TH AVE MINNEAPOLIS, MN 55415 RBLASEG@DAMONFARBER.COM 612.332.7522

BOLTON & MENK
7575 GOLDEN VALLEY ROAD
SUITE 200
MINNEAPOLIS, MN 55427
BRADLEY.FISHER@BOLTON-MENK.COM
612.759.7240

NELSON-RUDIE & ASSOCIATES, 9100 49TH AVE N, MINNEAPOLIS, MN 55428 SARAH.GREFF@NELSONRUDIE.COM 763.367.7600

SCHULER & SHOOK
219 SE MAIN ST
MINNEAPOLIS, MN 55414
PWHITAKER@SCHULERSHOOK.COM
612.339.5958

60% PRICING SET

NORTHFIELD BRIDGE SQUARE

NORTHFIELD, MN


I hereby certify that this document was prepared by me or under my direct supervision and that I am a duly licensed Landscape Architect under the laws of the State of Minnesota.

Tom Whitlock

Negisti attori#	20
Signature	Γ
	09/26/2
DF/ Project #	22-
Scale	AS SHO
Drawn/Checked	RP/AG/BE
	4.
REVISION	<i>/</i> - <i>/</i> 0 <i>/</i> -

PLAN ENLARGEMENT -

THE SQUARE

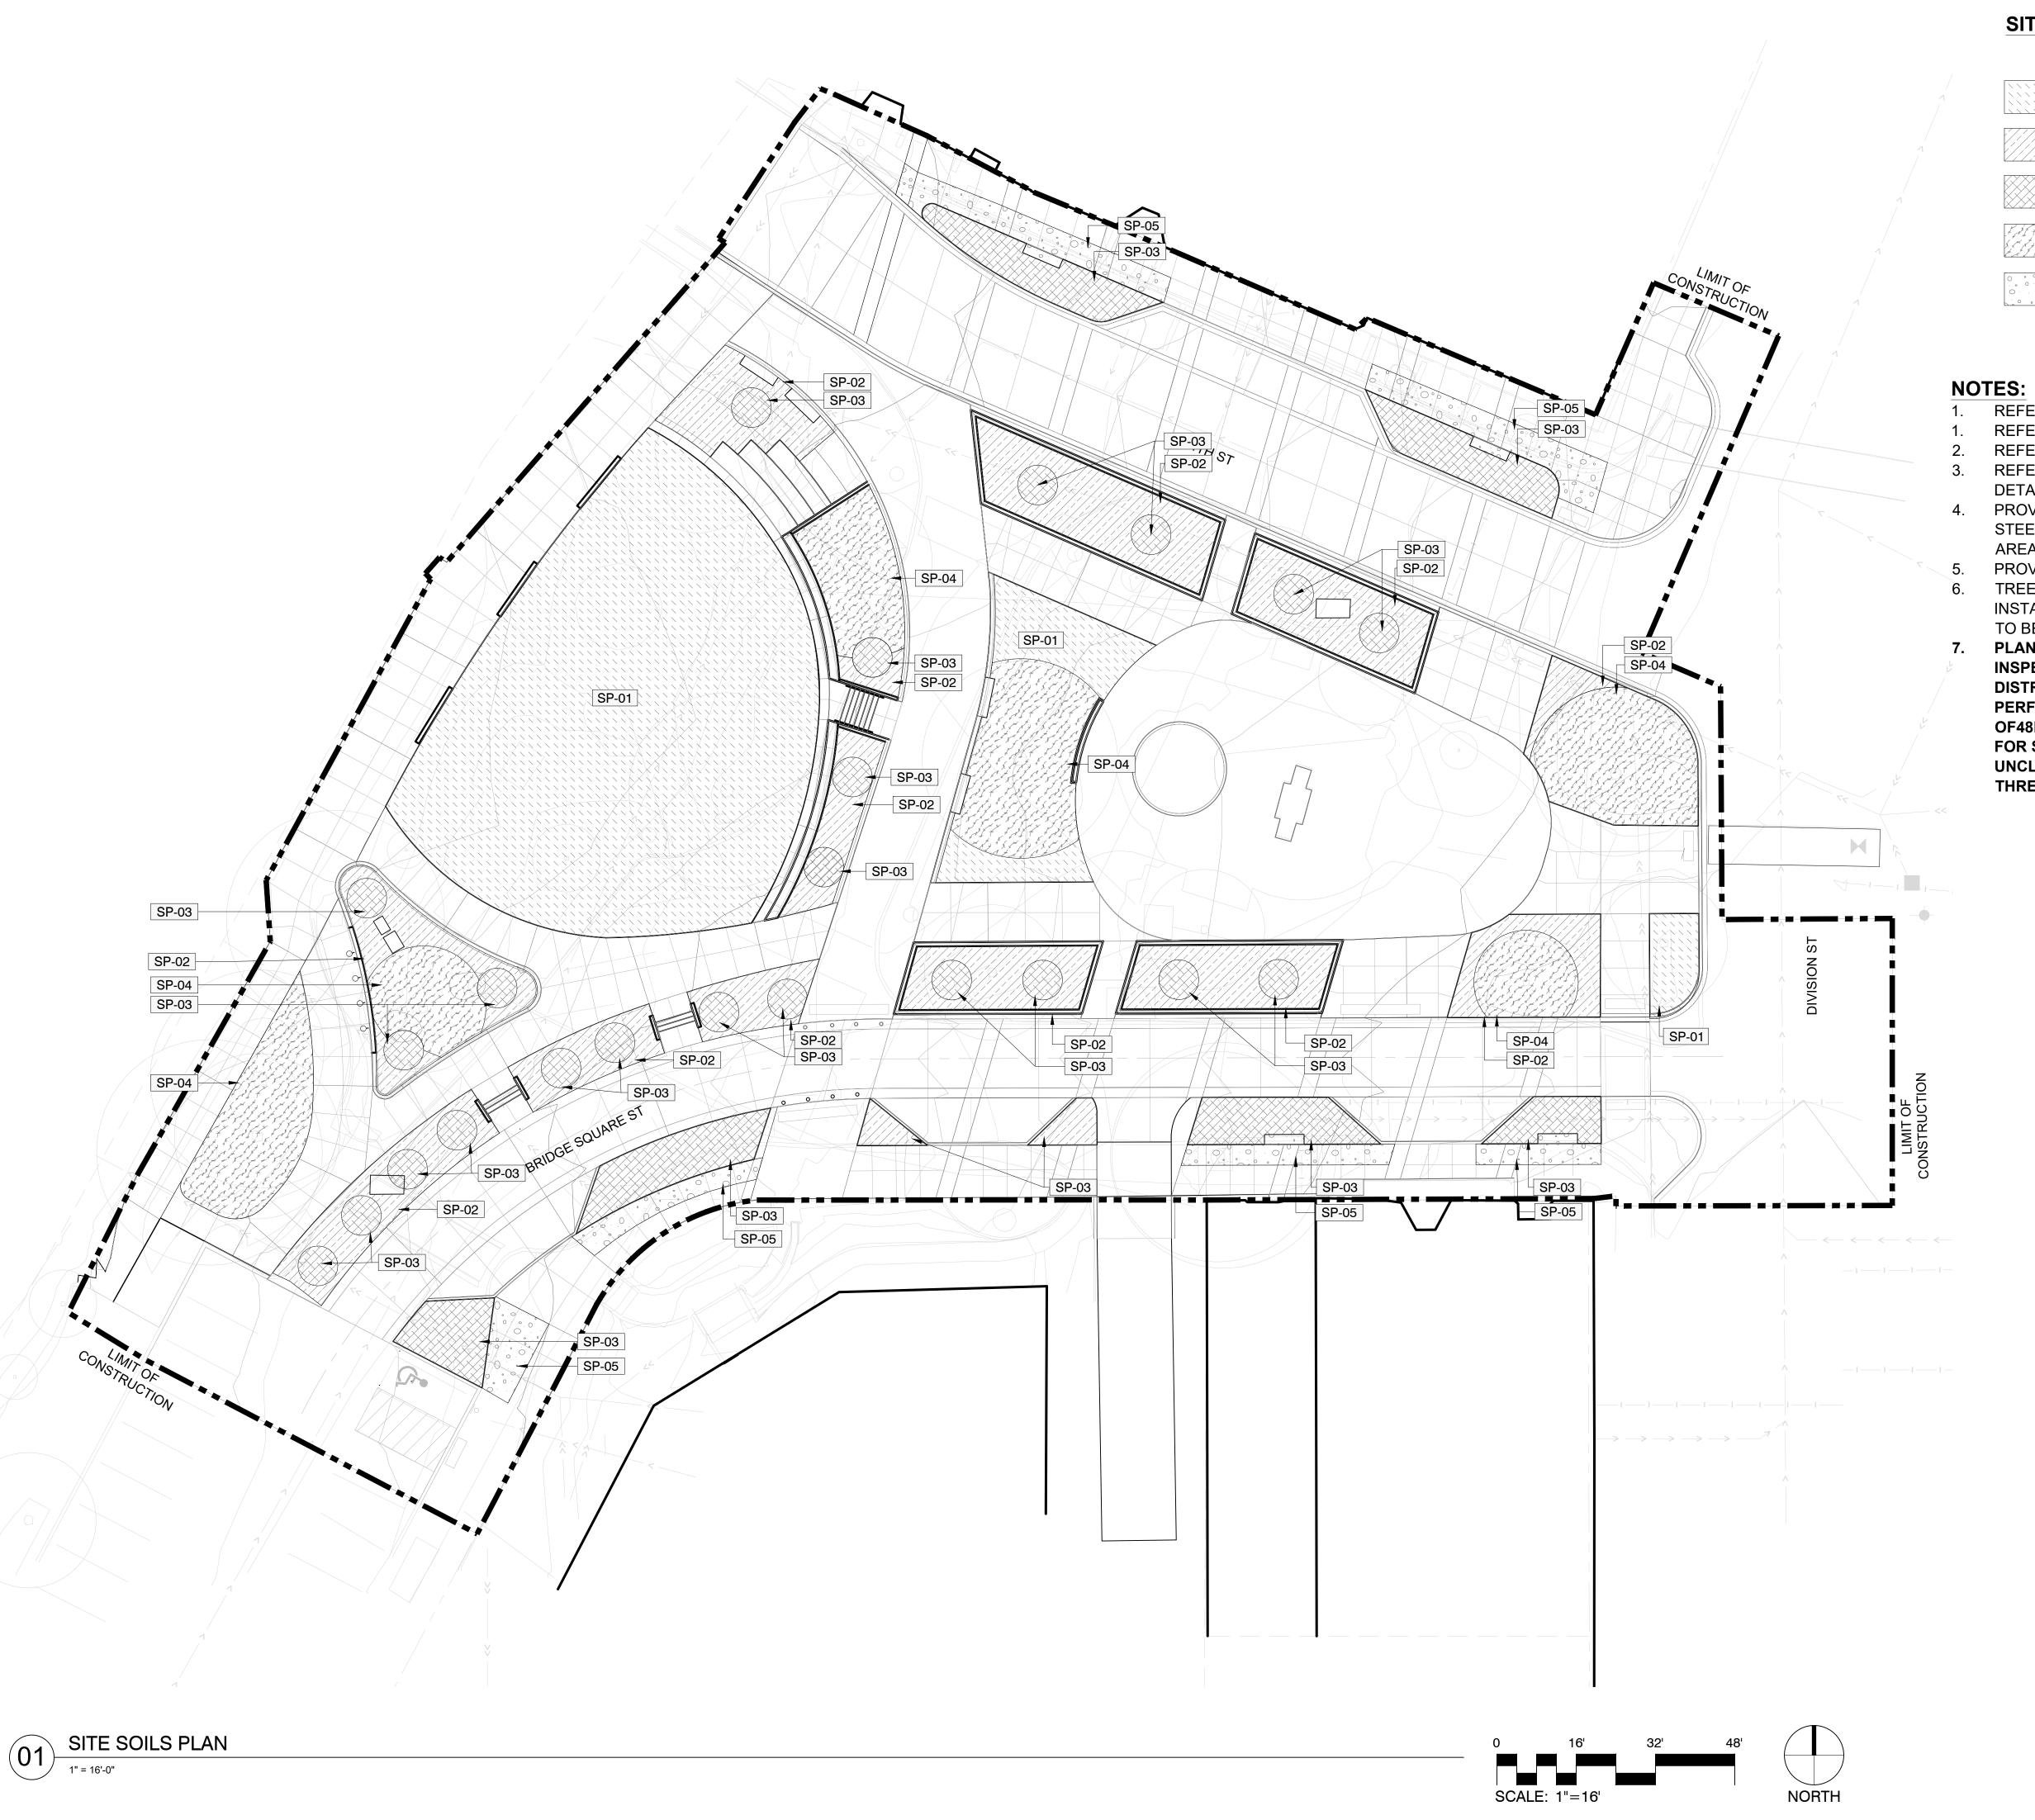

SITE SOILS LEGEND


SYMBOL DESCRIPTION SP-01 SOIL TYPE 01 - HIGH USE LAWN MIX

SOIL TYPE 02 - 18" DEPTH PLANTING SOIL

SOIL TYPE 03 - 36" DEPTH PLANTING SOIL



SOIL TYPE 04 - SOIL PREP BELOW EXISTING TREES

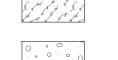

SOIL TYPE 05 - SAND-BASED STRUCTURAL SOIL

- REFER TO SOILS SPECIFICATION 32 91 13
- REFER TO L001FOR GENERAL NOTES AND ABBREVIATIONS.
- REFER TO L002FOR LANDSCAPE NOTES.
- REFER TO L003FOR TREE PRESERVATION PLAN, NOTES & DETAILS.
- PROVIDE EROSION CONTROL BLANKET AT SEEDED AREAS 3:1 AND STEEPER. PROVIDE NATIVE STRAW/ HYDROMULCH AT SEEDED AREAS SLOPED LESS THAN 3:1.
- PROVIDE ROADBED DECOMPACTION TO MINIMUM DEPTH OF 12".
- TREE, SHRUB AND PERENNIAL PLANTINGS TO BE PROVIDED AND INSTALLED BY OWNER. SEEDING, RESTORATION, AND SOIL PREP TO BE PROVIDED AND INSTALLED BY CONTRACTOR.
- PLANT MATERIAL, MULCH, SOILS, AND COMPOST SHALL BE **INSPECTED FOR JUMPING WORMS PRIOR TO PLACEMENT AND** DISTRIBUTION OF MATERIALS ON SITE. INSPECTION SHALL BE PERFORMED BY LANDSCAPE ARCHITECT. NOTIFY LA MINIMUM OF48HRS PRIOR TO MATERIAL ARRIVAL. SEE SPECIFICATIONS FOR SUBMITTAL REQUIREMENTS. JUMPING WORMS ARE AN **UNCLASSIFIED INVASIVE SPECIES IN MINNESOTA AND PROVIDE A** THREAT TO NATURAL ECOSYSTEMS.

Minnesota

CITY OF NORTHFIELD 801 WASHINGTON STREET

DAMON FARBER LANDSCAPE ARCHITECTS

NORTHFIELD, MINNESOTA 55057

DAVID.BENNETT@CI.NORTHFIELD.MN.US

310 S 4TH AVE MINNEAPOLIS, MN 55415 RBLASEG@DAMONFARBER.COM 612.332.7522

BOLTON & MENK 7575 GOLDEN VALLEY ROAD

SUITE 200 MINNEAPOLIS, MN 55427 BRADLEY.FISHER@BOLTON-MENK.COM 612.759.7240

NELSON-RUDIE & ASSOCIATES, 9100 49TH AVE N, MINNEAPOLIS, MN 55428

SARAH.GREFF@NELSONRUDIE.COM 763.367.7600

PWHITAKER@SCHULERSHOOK.COM

612.339.5958

SCHULER & SHOOK 219 SE MAIN ST MINNEAPOLIS, MN 55414

60% PRICING SET

NORTHFIELD BRIDGE SQUARE

NORTHFIELD, MN

I hereby certify that this document was prepared by me or under my direct supervision and that I am a duly licensed Landscape Architect under the laws of the State of Minnesota.


Tom Whitlock

26292

Date Signature 09/26/2023 22-184 DF/ Project # AS SHOWN RP/AG/BE/RB Drawn/Checked

Registration#

SITE SOILS PLAN

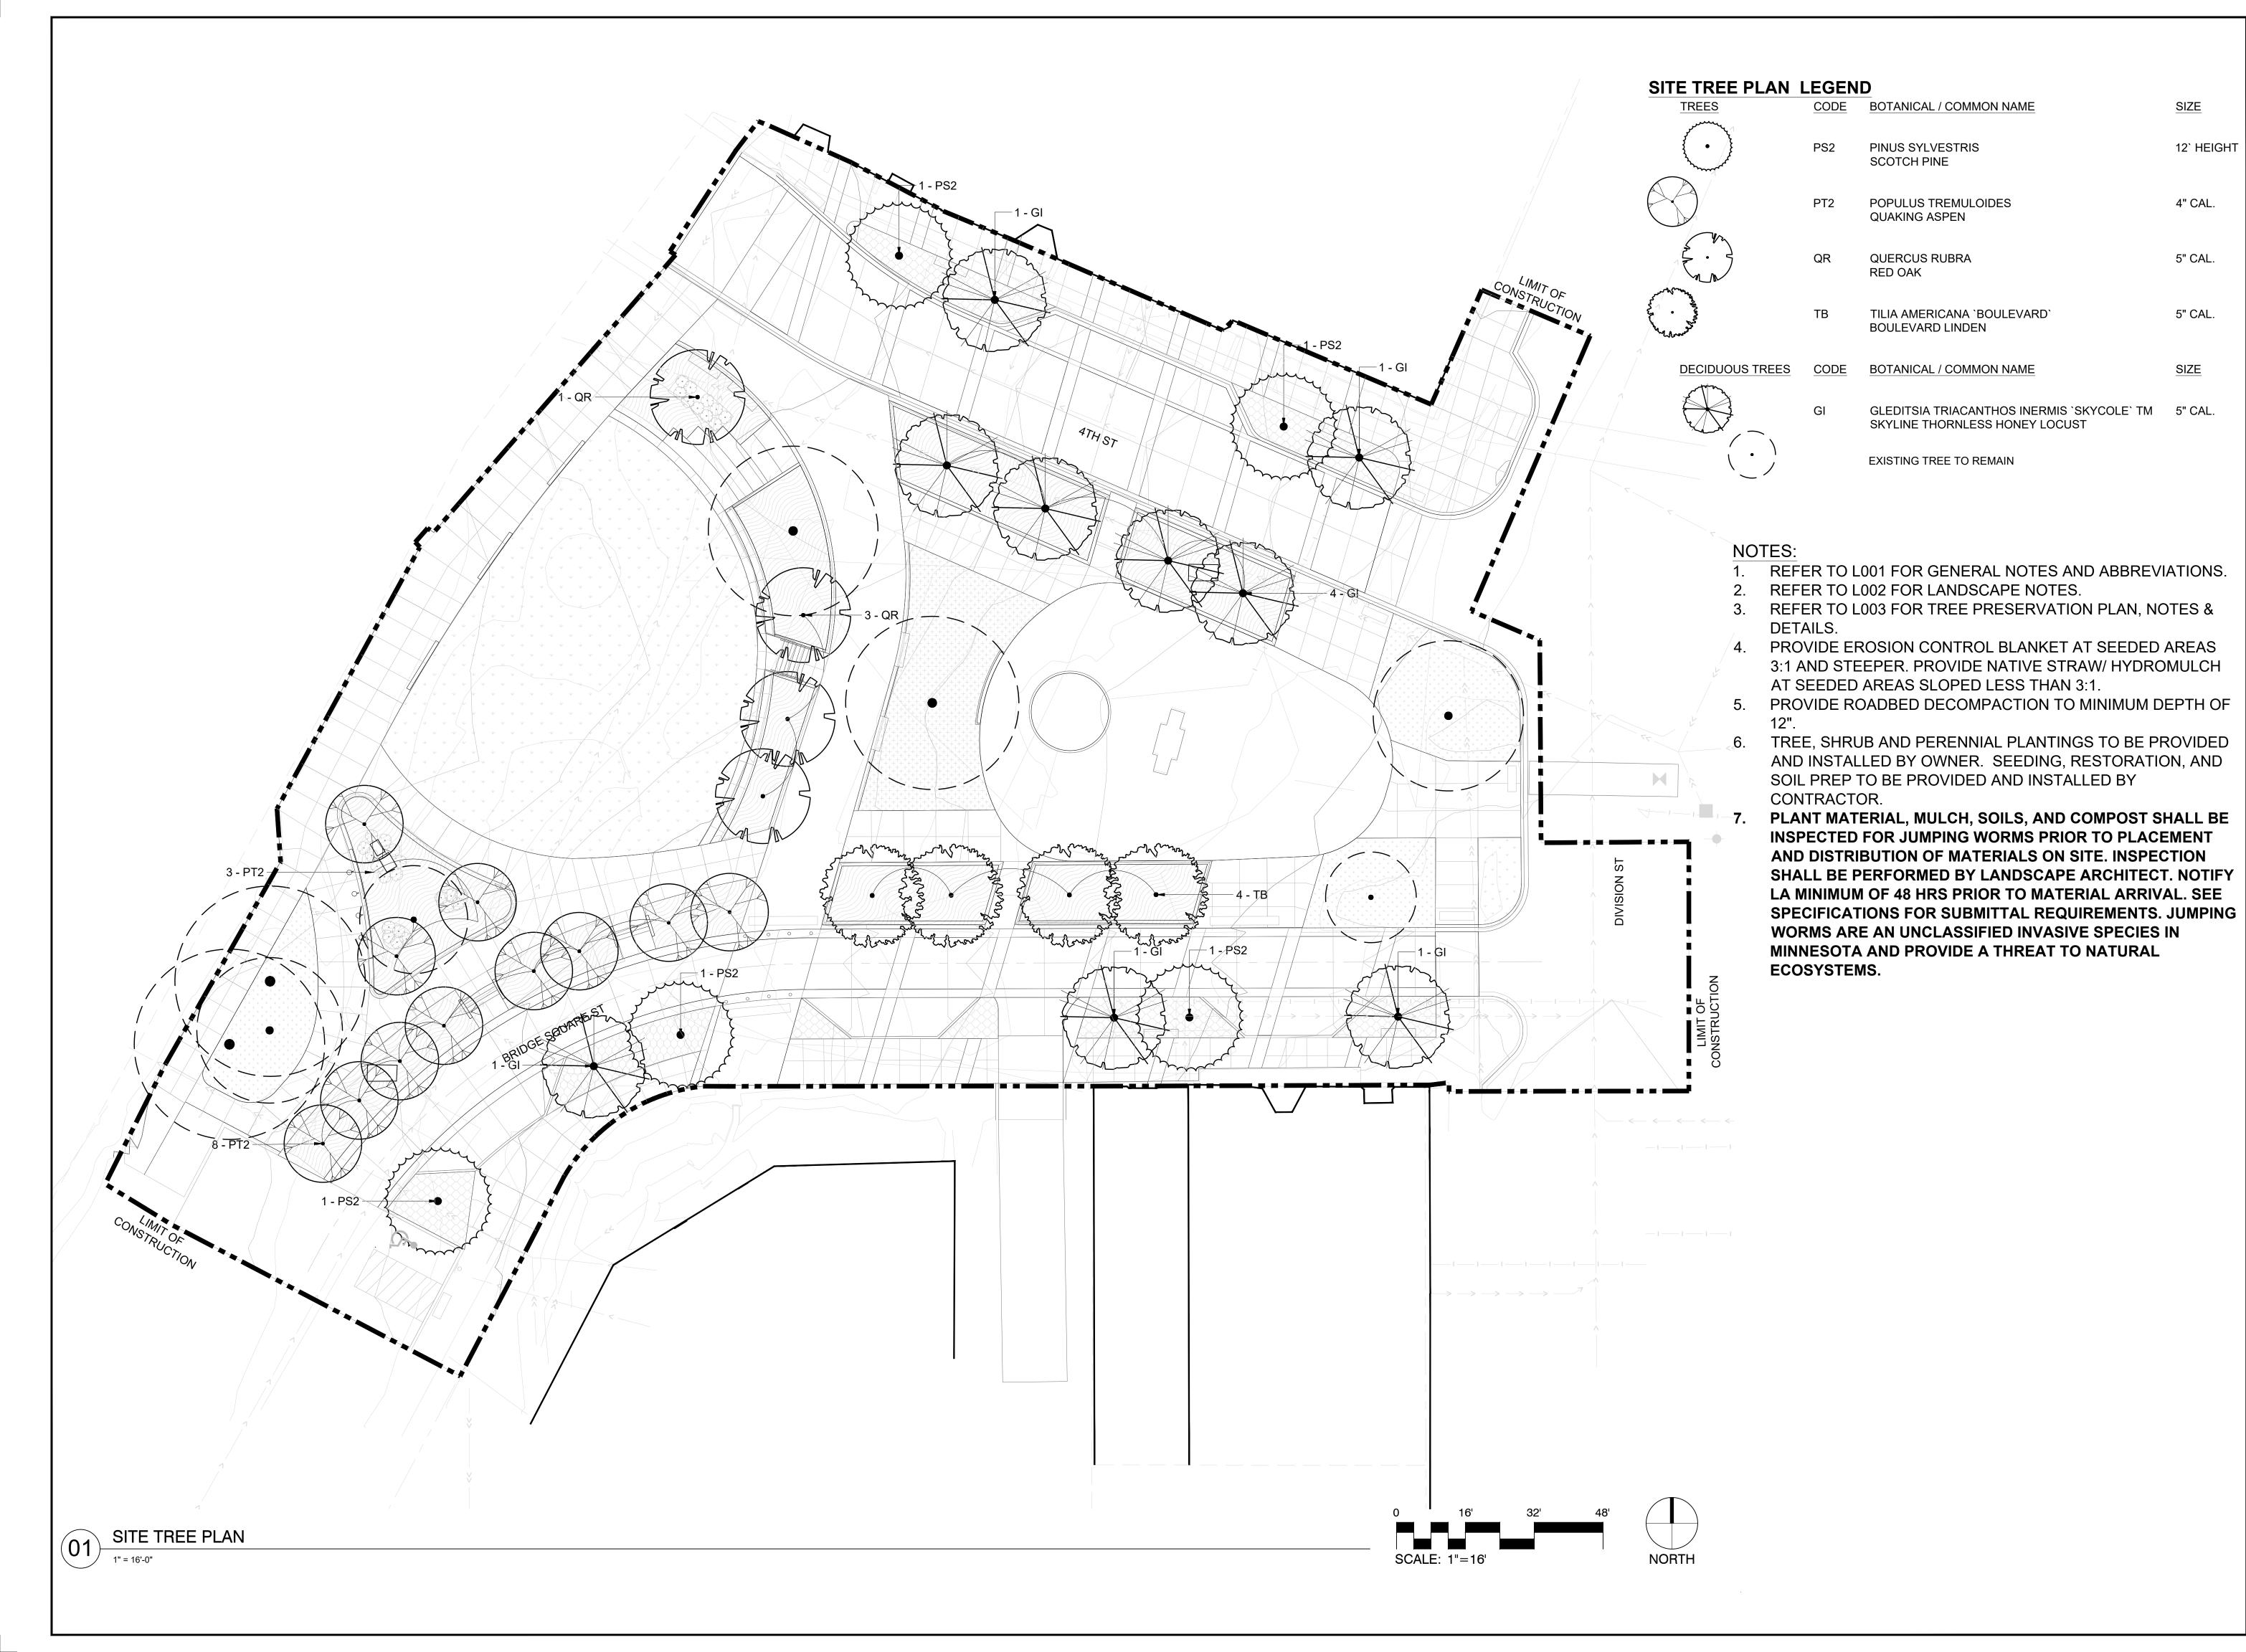



CITY OF NORTHFIELD

Minnesota

801 WASHINGTON STREET
NORTHFIELD, MINNESOTA 55057
DAVID.BENNETT@CI.NORTHFIELD.MN.US

DAMON FARBER LANDSCAPE ARCHITECTS 310 S 4TH AVE MINNEAPOLIS, MN 55415 RBLASEG@DAMONFARBER.COM 612.332.7522

BOLTON & MENK
7575 GOLDEN VALLEY ROAD
SUITE 200
MINNEAPOLIS, MN 55427
BRADLEY.FISHER@BOLTON-MENK.COM
612.759.7240

NELSON-RUDIE & ASSOCIATES, 9100 49TH AVE N, MINNEAPOLIS, MN 55428

SARAH.GREFF@NELSONRUDIE.COM 763.367.7600 SCHULER & SHOOK

219 SE MAIN ST MINNEAPOLIS, MN 55414 PWHITAKER@SCHULERSHOOK.COM 612.339.5958

60% PRICING SET

NORTHFIELD BRIDGE SQUARE

NORTHFIELD, MN

I hereby certify that this document was prepared by me or under my direct supervision and that I am a duly licensed Landscape Architect under the laws of the State of Minnesota.

Tom Whitlock

Signature Date

09/26/2023


DF/ Project # 22-184

Scale AS SHOWN

Drawn/Checked RP/AG/BE/RB

REVISION ---

SITE TREE PLAN

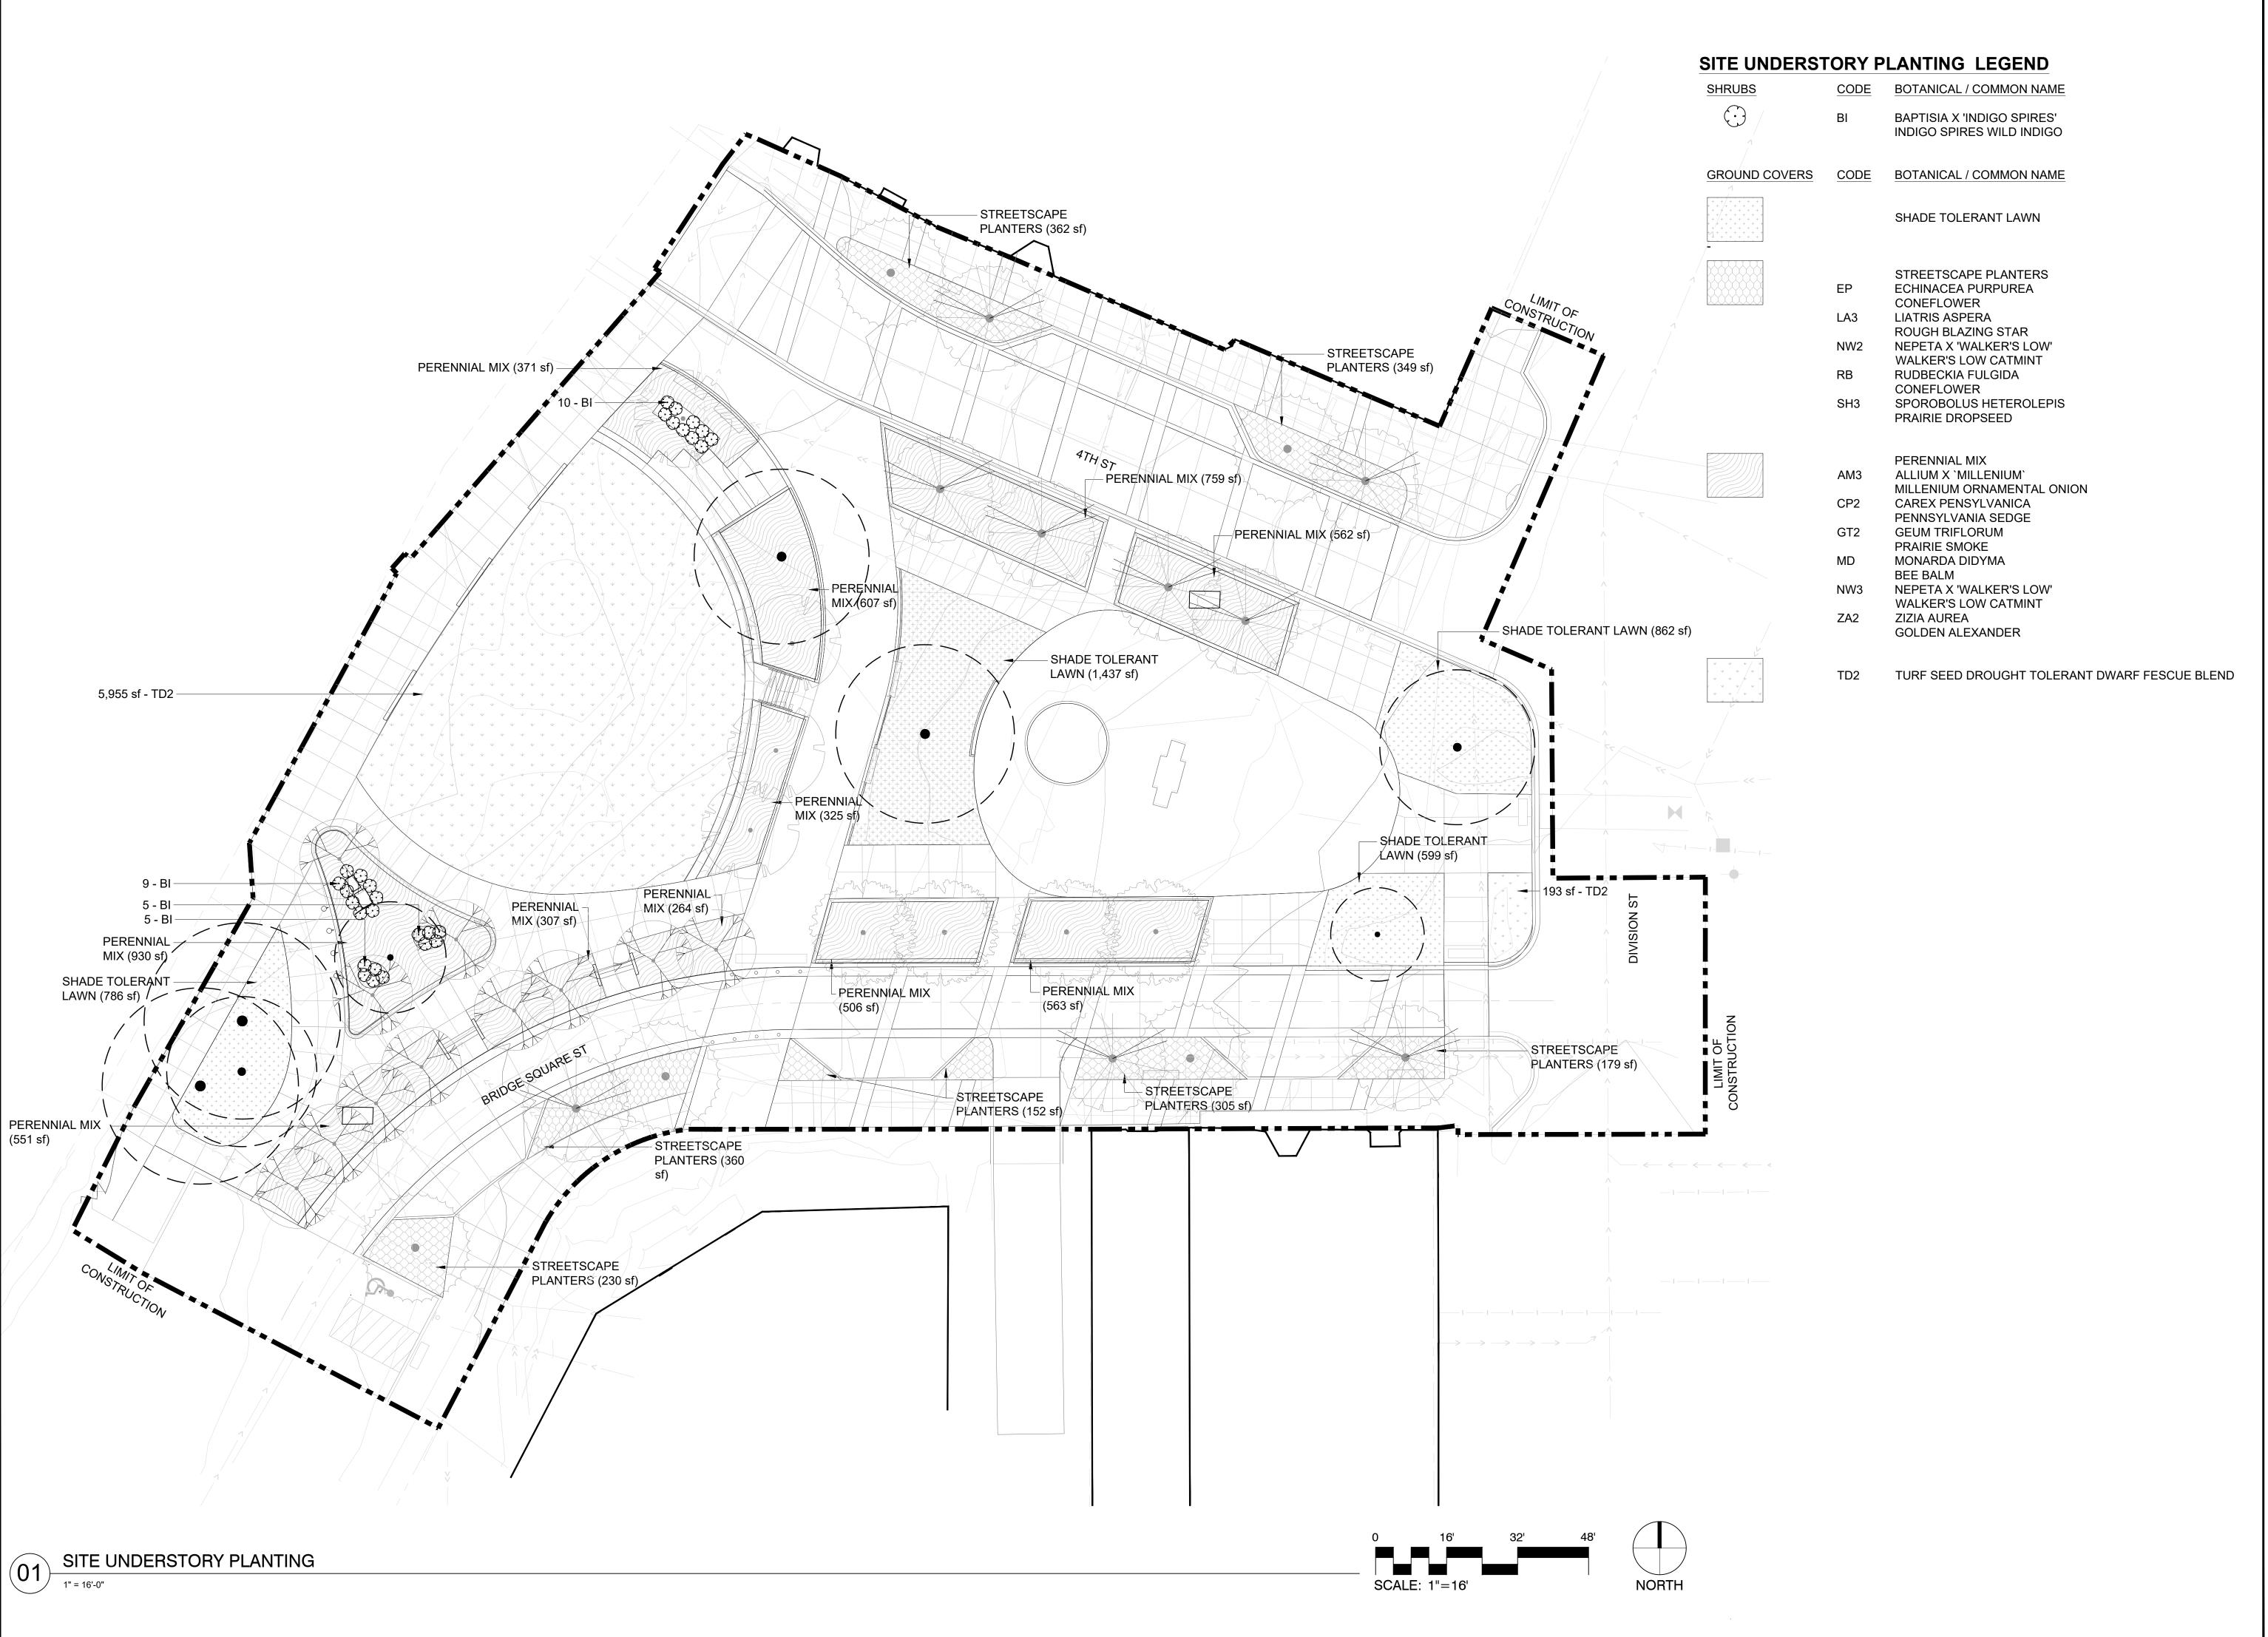



Minnesota

CITY OF NORTHFIELD

801 WASHINGTON STREET
NORTHFIELD, MINNESOTA 55057
DAVID.BENNETT@CI.NORTHFIELD.MN.US

DAMON FARBER LANDSCAPE ARCHITECTS 310 S 4TH AVE

MINNEAPOLIS, MN 55415 RBLASEG@DAMONFARBER.COM 612.332.7522

BOLTON & MENK

7575 GOLDEN VALLEY ROAD SUITE 200 MINNEAPOLIS, MN 55427 BRADLEY.FISHER@BOLTON-MENK.COM 612.759.7240

NELSON-RUDIE & ASSOCIATES, 9100 49TH AVE N,

MINNEAPOLIS, MN 55428 SARAH.GREFF@NELSONRUDIE.COM 763.367.7600

SCHULER & SHOOK 219 SE MAIN ST

MINNEAPOLIS, MN 55414 PWHITAKER@SCHULERSHOOK.COM 612.339.5958

60% PRICING SET

NORTHFIELD BRIDGE SQUARE

NORTHFIELD, MN

I hereby certify that this document was prepared by me or under my direct supervision and that I am a duly licensed Landscape Architect under the laws of the State of Minnesota.

Tom Whitlock

Signature Date

09/26/2023


DF/ Project # 22-184

Scale AS SHOWN

Drawn/Checked RP/AG/BE/RB

REVISION ---

SITE UNDERSTORY PLANTING

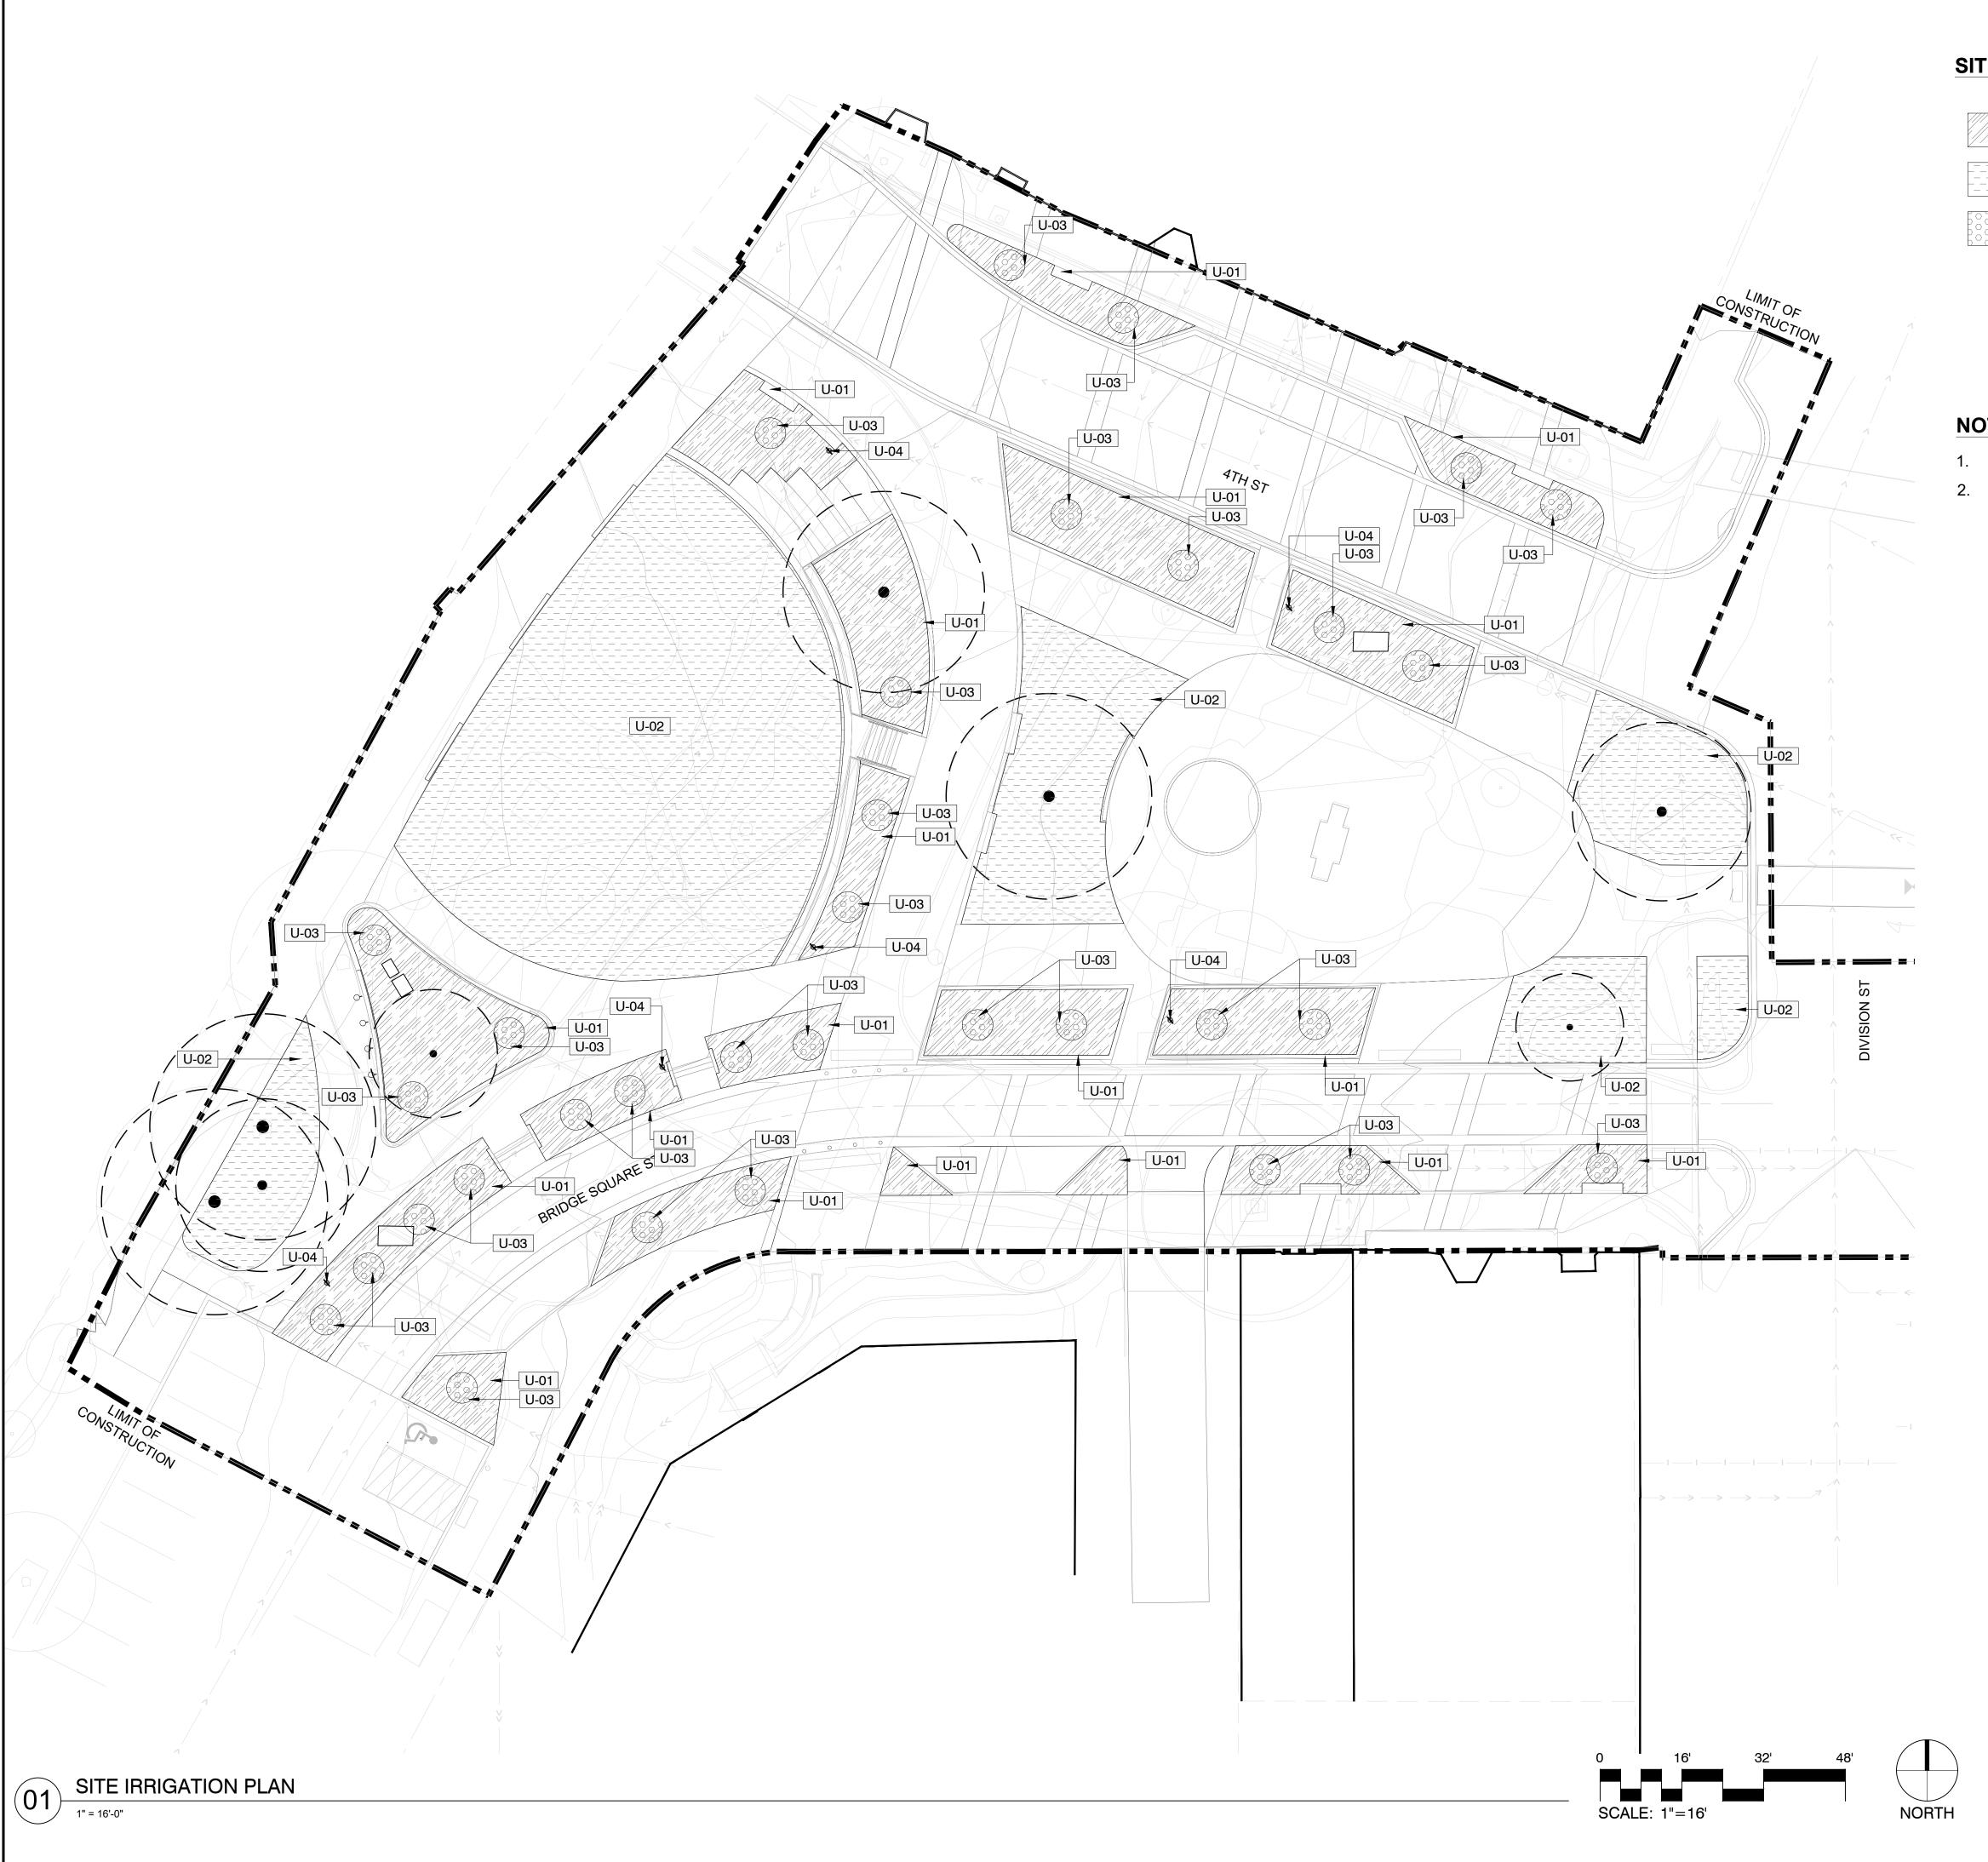

SITE IRRIGATION PLAN LEGEND

SYMBOL DESCRIPTION MATERIAL PROFILE

U-01 SITE IRRIGATION TYPE 01 DRIP IRRIGATION

U-02 SITE IRRIGATION TYPE 02 POP-UP SPRAY IRRIGATION

U-03 SITE IRRIGATION TYPE 03 BUBBLER IRRIGATION

U-04 SITE IRRIGATION - QUICK COUPLER HOSE HOOK UP

NOTES:

- 1. CONTROLLER LOCATION TBD
- 2. POINT OF CONNECTION TBD

North field

CITY OF NORTHFIELD

Minnesota

801 WASHINGTON STREET NORTHFIELD, MINNESOTA 55057 DAVID.BENNETT@CI.NORTHFIELD.MN.US

DAMON FARBER LANDSCAPE ARCHITECTS 310 S 4TH AVE

MINNEAPOLIS, MN 55415 RBLASEG@DAMONFARBER.COM 612.332.7522

BOLTON & MENK 7575 GOLDEN VALLEY ROAD SUITE 200

SUITE 200 MINNEAPOLIS, MN 55427 BRADLEY.FISHER@BOLTON-MENK.COM 612.759.7240

NELSON-RUDIE & ASSOCIATES, 9100 49TH AVE N, MINNEAPOLIS, MN 55428

MINNEAPOLIS, MN 55428 SARAH.GREFF@NELSONRUDIE.COM 763.367.7600

SCHULER & SHOOK 219 SE MAIN ST

MINNEAPOLIS, MN 55414 PWHITAKER@SCHULERSHOOK.COM 612.339.5958

60% PRICING SET

NORTHFIELD BRIDGE SQUARE

NORTHFIELD, MN

I hereby certify that this document was prepared by me or under my direct supervision and that I am a duly licensed Landscape Architect under the laws of the State of Minnesota.

Tom Whitlock

Signature Date

09/26/2023


DF/ Project # 22-184

Scale AS SHOWN

Drawn/Checked RP/AG/BE/RB

REVISION ---

SITE IRRIGATION PLAN

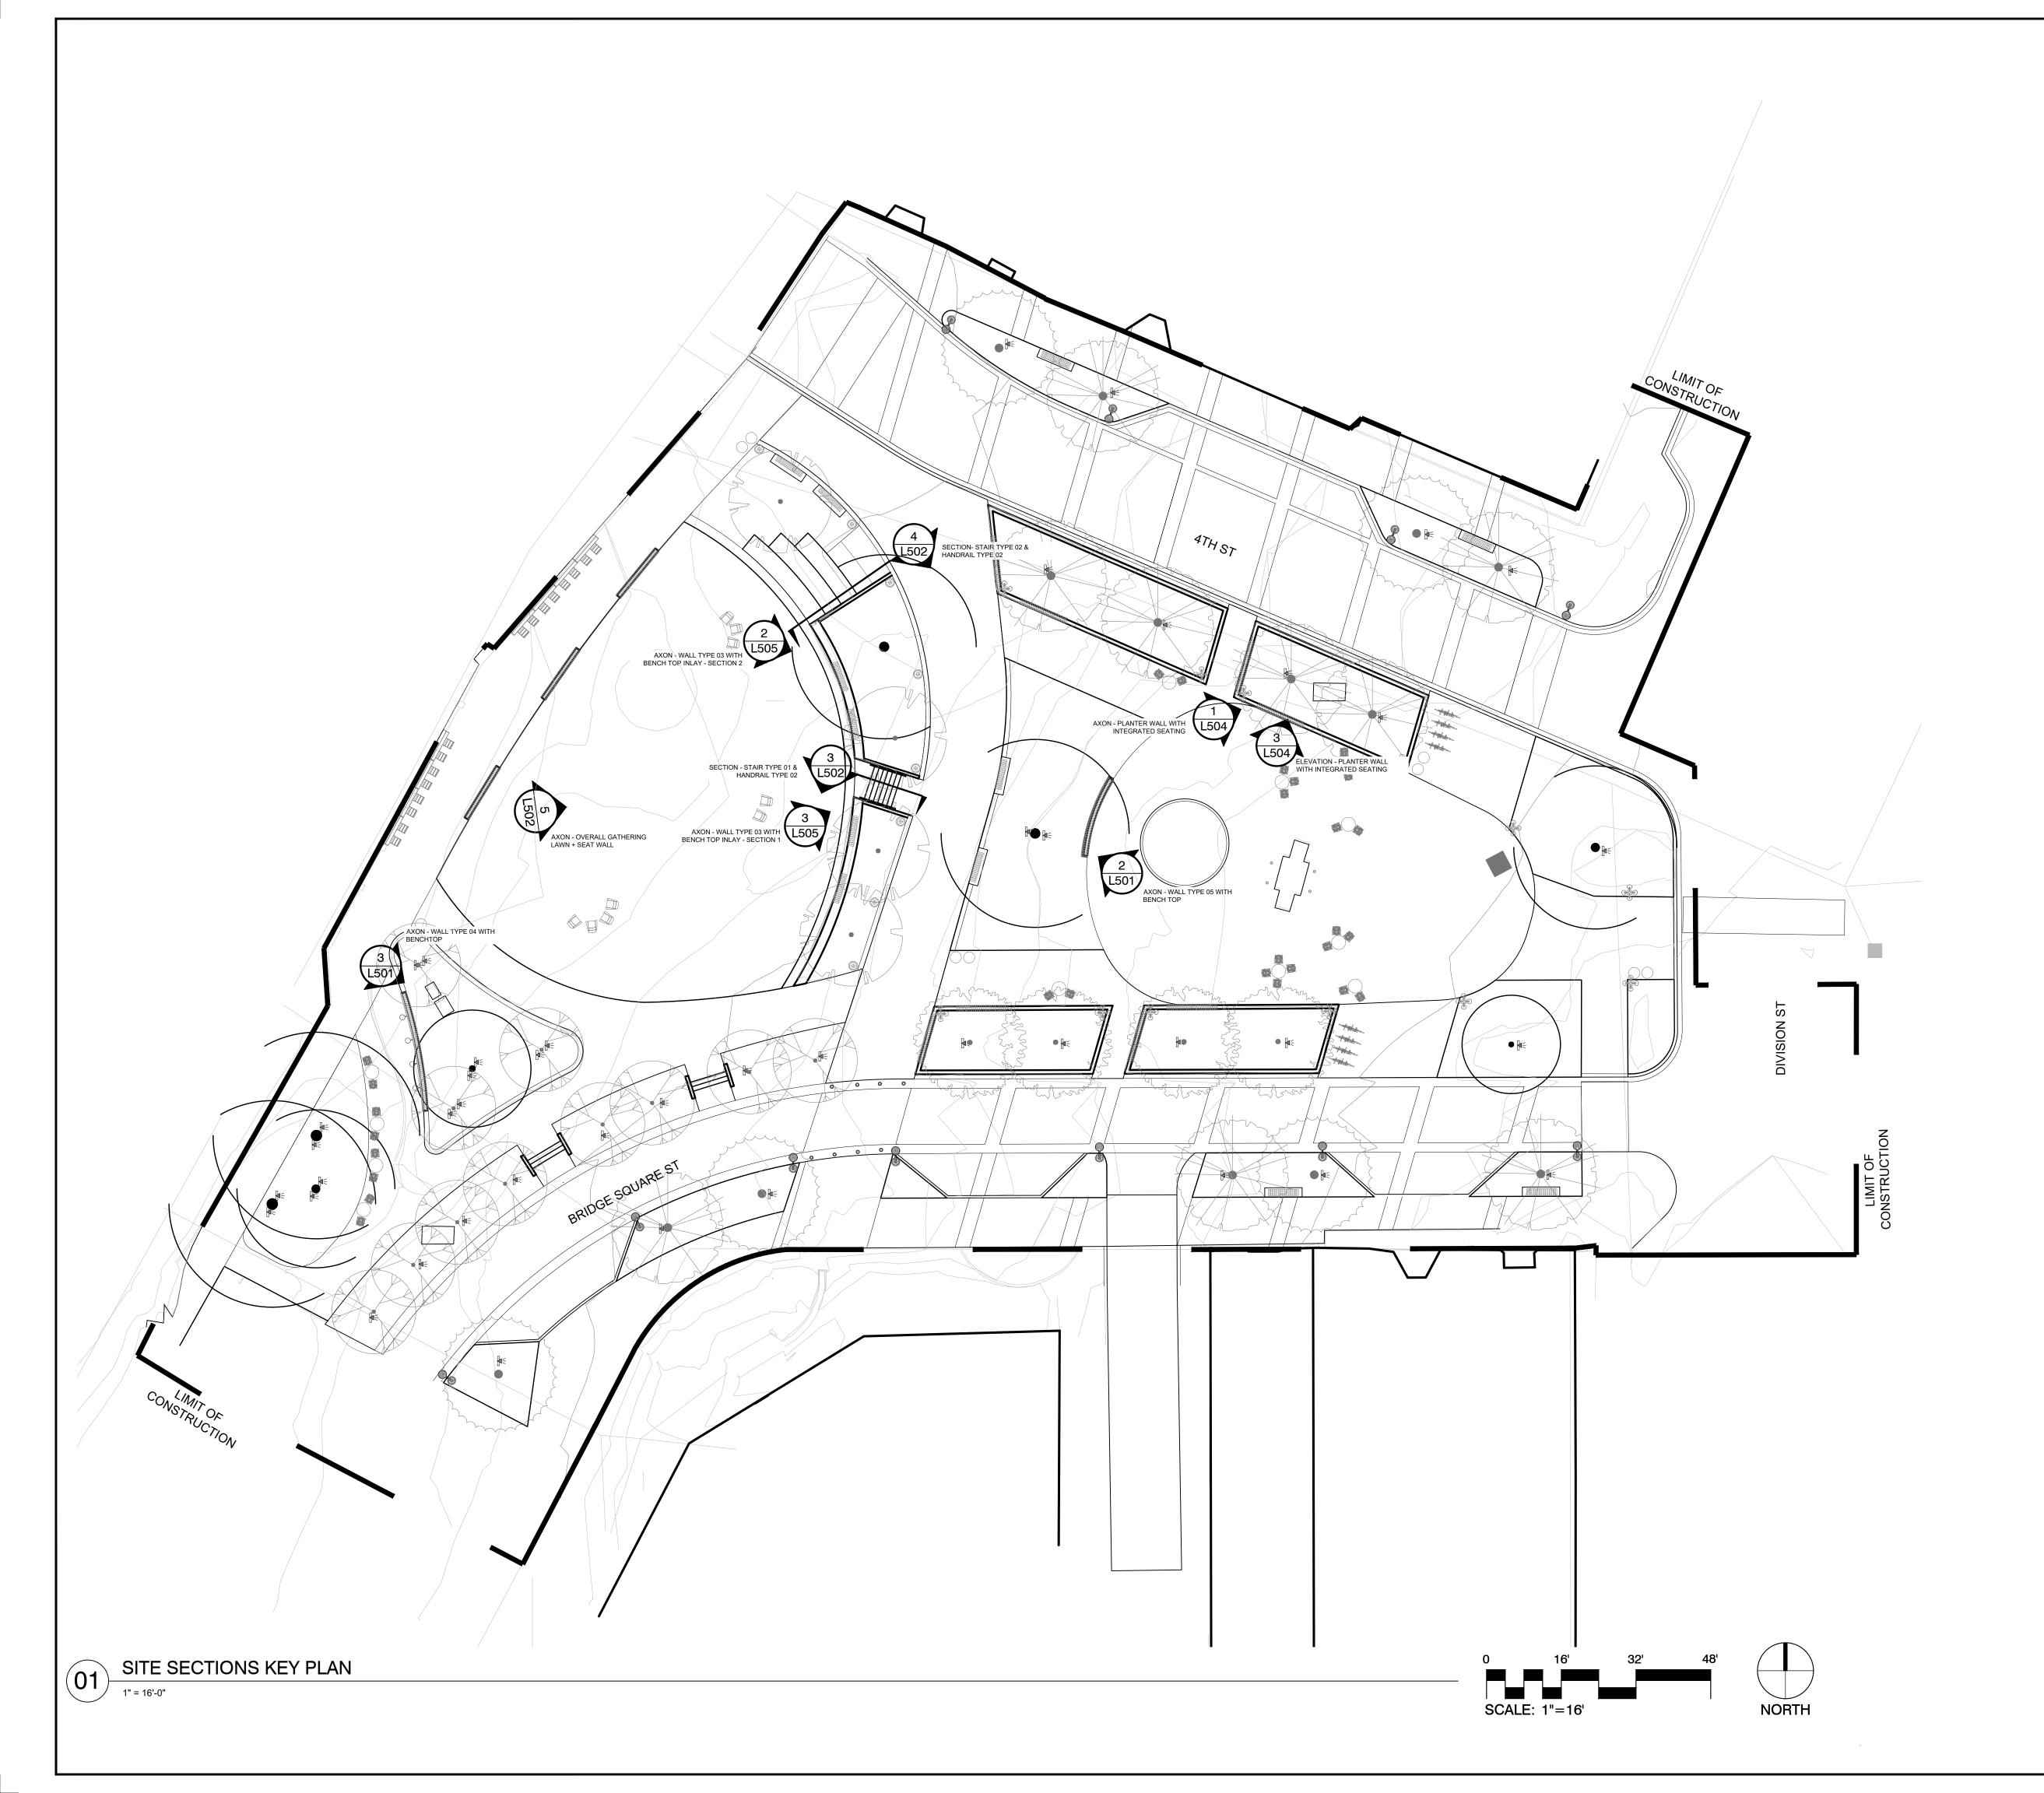



Minnesota

CITY OF NORTHFIELD 801 WASHINGTON STREET

NORTHFIELD, MINNESOTA 55057 DAVID.BENNETT@CI.NORTHFIELD.MN.US

DAMON FARBER

LANDSCAPE ARCHITECTS
310 S 4TH AVE
MINNEAPOLIS, MN 55415
RBLASEG@DAMONFARBER.COM
612.332.7522

BOLTON & MENK

7575 GOLDEN VALLEY ROAD SUITE 200 MINNEAPOLIS, MN 55427 BRADLEY.FISHER@BOLTON-MENK.COM 612.759.7240

NELSON-RUDIE & ASSOCIATES, 9100 49TH AVE N, MINNEAPOLIS, MN 55428 SARAH.GREFF@NELSONRUDIE.COM 763.367.7600

SCHULER & SHOOK
219 SE MAIN ST
MINNEAPOLIS, MN 55414
PWHITAKER@SCHULERSHOOK.COM 612.339.5958

60% PRICING SET

NORTHFIELD BRIDGE SQUARE

NORTHFIELD, MN

I hereby certify that this document was prepared by me or under my direct supervision and that I am a duly licensed Landscape Architect under the laws of the State of Minnesota.


Registration#

Tom Whitlock

26292

Date Signature 09/26/2023 22-184 DF/ Project # AS SHOWN RP/AG/BE/RB Drawn/Checked

> SITE SECTIONS **KEY PLAN**

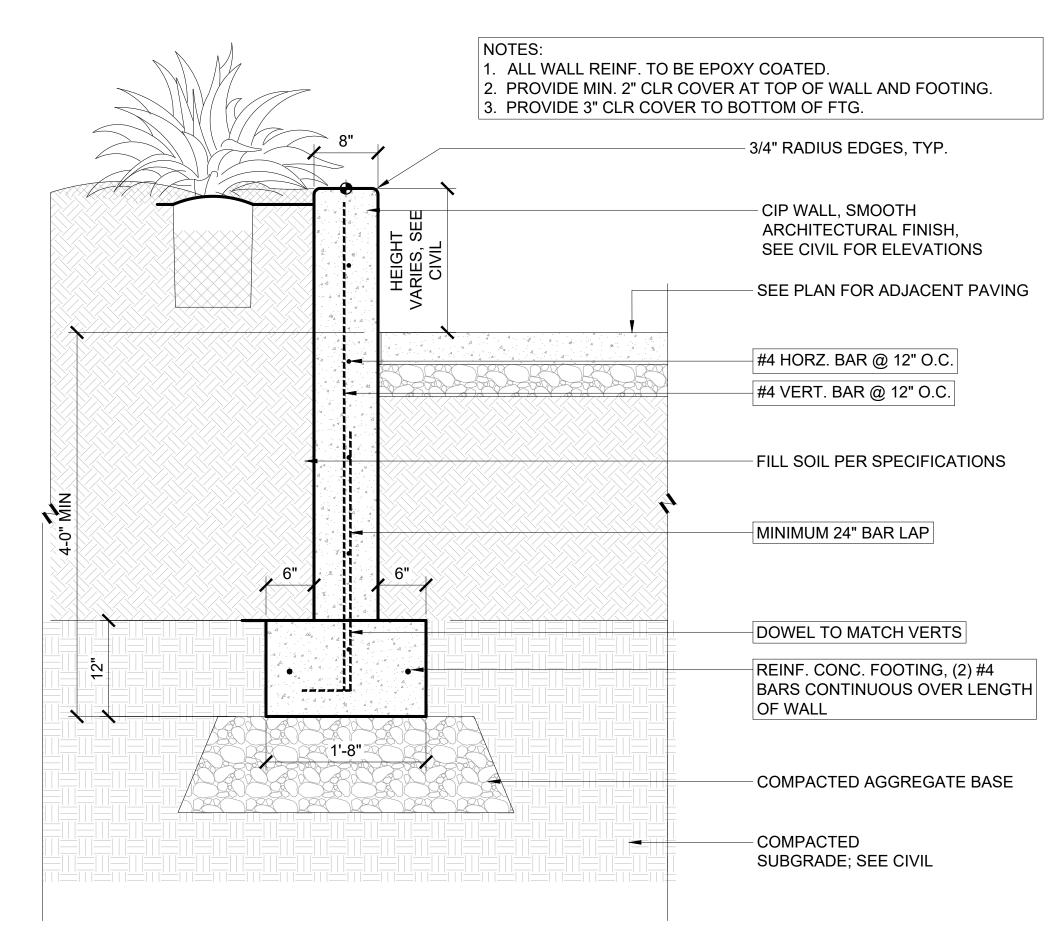

WALL TYPE 02 - 8" CIP WALL


1'-0" ¹'' CHAMFER ⁻ - UNIT PAVERS (1) -(2) #4 BAR, CONT. PIP REINF. CONCRETE TOP FINISH: LIGHT BROOM - 6" DEPTH COMPACTED AGGREGATE BASE, COMPACT TO 98% PROCTOR DENSITY - COMPACTED/ UNDISTURBED SUBGRADE

EDGER TYPE 02 - FLUSH CONCRETE CURB 3

P-22 184-20


P-22 184-118

1" = 1'-0"

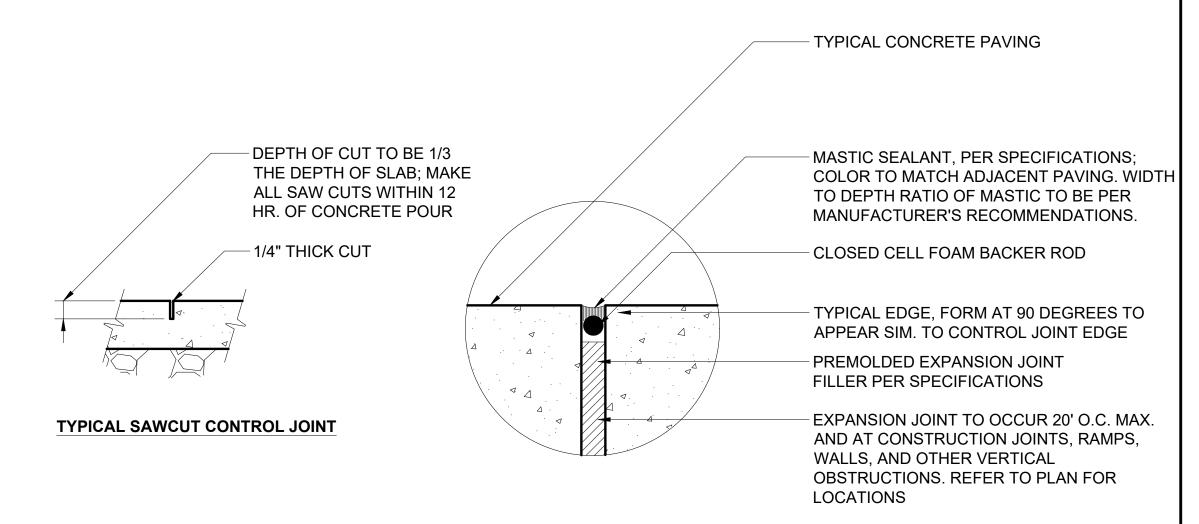

TYPICAL EXPANSION JOINT - ENLARGED

DETAIL - TYPICAL CONCRETE JOINTING P-22 184-05

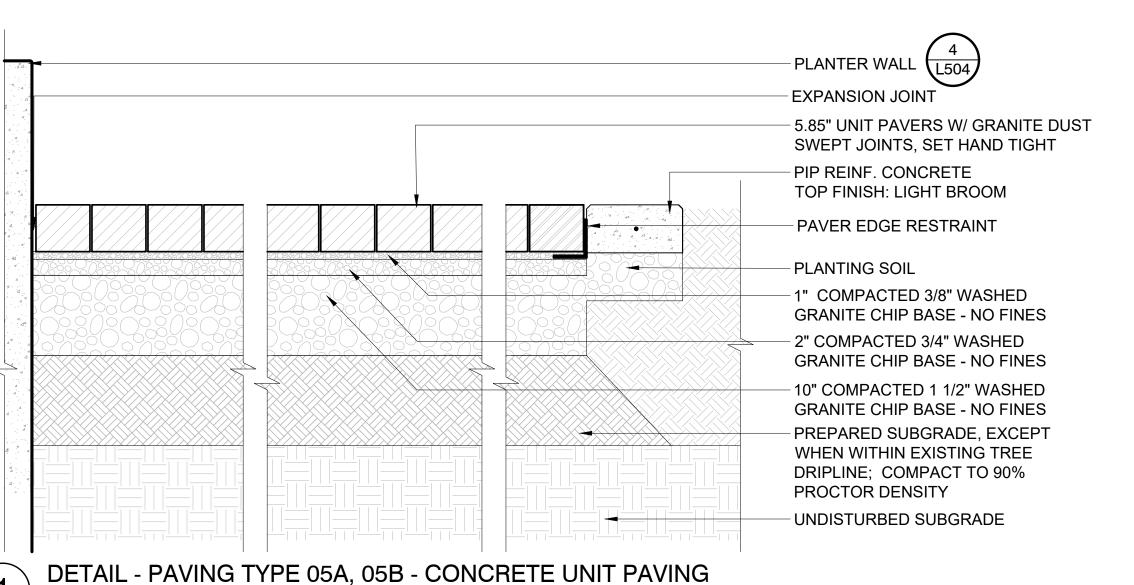

CITY OF NORTHFIELD

Minnesota

801 WASHINGTON STREET NORTHFIELD, MINNESOTA 55057 DAVID.BENNETT@CI.NORTHFIELD.MN.US

DAMON FARBER LANDSCAPE ARCHITECTS 310 S 4TH AVE

MINNEAPOLIS, MN 55415 RBLASEG@DAMONFARBER.COM 612.332.7522

BOLTON & MENK 7575 GOLDEN VALLEY ROAD SUITE 200 MINNEAPOLIS, MN 55427 BRADLEY.FISHER@BOLTON-MENK.COM 612.759.7240

NELSON-RUDIE & ASSOCIATES, 9100 49TH AVE N,

MINNEAPOLIS, MN 55428 SARAH.GREFF@NELSONRUDIE.COM 763.367.7600

SCHULER & SHOOK

219 SE MAIN ST MINNEAPOLIS, MN 55414 PWHITAKER@SCHULERSHOOK.COM 612.339.5958

60% PRICING SET

NORTHFIELD BRIDGE SQUARE

NORTHFIELD, MN

I hereby certify that this document was prepared by me or under my direct supervision and that I am a duly licensed Landscape Architect under the laws of the State of Minnesota.


Tom Whitlock

Registration# 26292 Date Signature 09/26/2023 22-184 DF/ Project # AS SHOWN RP/AG/BE/RB Drawn/Checked

REVISION

SITE DETAILS

P-22 184-08

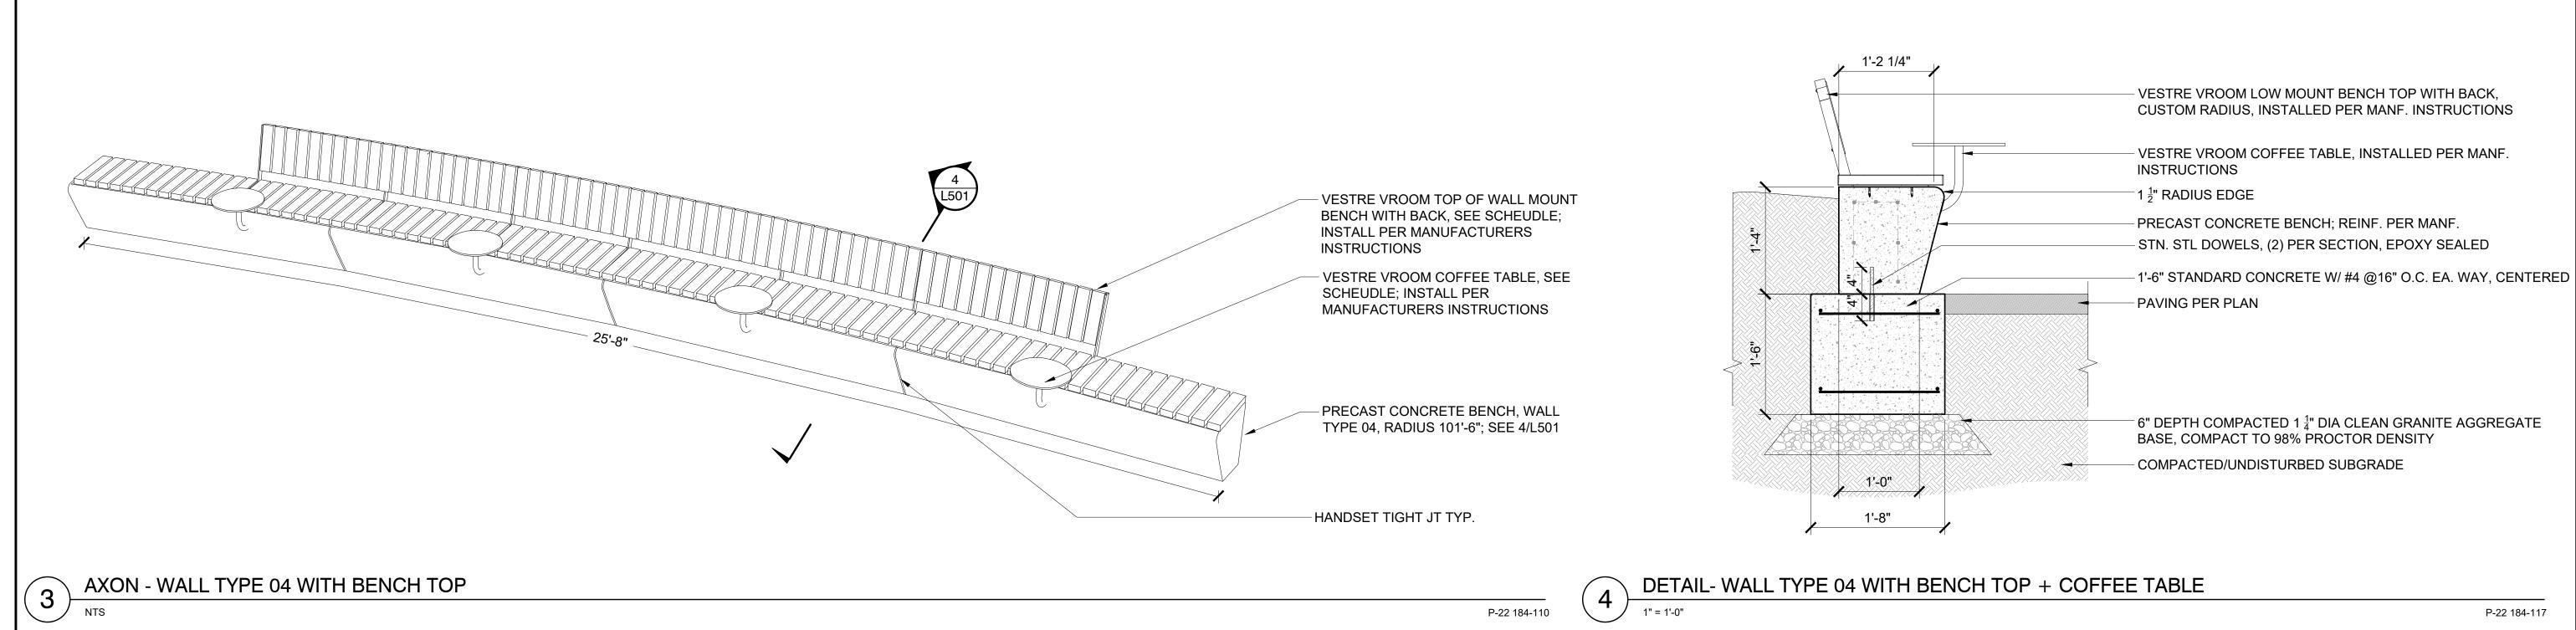

VESTRE VROOM ARMREST,

INSTRUCTIONS

- PRECAST CONCRETE BENCH, WALL TYPE 05,

RADIUS 38'-2"; 1/L501

- HAND TIGHT JT TYP.

1 L501

AXON - WALL TYPE 05 WITH BENCH TOP

INSTALL PER MANUFACTURERS

MANUFACTURERS INSTRUCTIONS

- VESTRE VROOM TOP OF WALL MOUNT

BENCH TOP, SEE SCHEDULE; INSTALL PER

P-22 184-110

P-22 184-105

1'-3 3/4"

1'-8"

DETAIL- WALL TYPE 05 WITH BENCH TOP

CITY OF NORTHFIELD

Minnesota

801 WASHINGTON STREET NORTHFIELD, MINNESOTA 55057 DAVID.BENNETT@CI.NORTHFIELD.MN.US

DAMON FARBER LANDSCAPE ARCHITECTS 310 S 4TH AVE

MINNEAPOLIS, MN 55415 RBLASEG@DAMONFARBER.COM 612.332.7522

BOLTON & MENK 7575 GOLDEN VALLEY ROAD SUITE 200 MINNEAPOLIS, MN 55427 BRADLEY.FISHER@BOLTON-MENK.COM 612.759.7240

NELSON-RUDIE & ASSOCIATES, 9100 49TH AVE N, MINNEAPOLIS, MN 55428

SARAH.GREFF@NELSONRUDIE.COM 763.367.7600

SCHULER & SHOOK 219 SE MAIN ST MINNEAPOLIS, MN 55414 PWHITAKER@SCHULERSHOOK.COM 612.339.5958

60% PRICING SET

NORTHFIELD BRIDGE SQUARE

NORTHFIELD, MN

I hereby certify that this document was prepared by me or under my direct supervision and that I am a duly licensed Landscape Architect under the laws of the State of Minnesota.

Tom Whitlock Registration# 26292 Date Signature 09/26/2023 22-184 DF/ Project # AS SHOWN RP/AG/BE/RB Drawn/Checked

P-22 184-117

P-22 184-101

VESTRE VROOM LOW MOUNT BENCH

INSTALLED PER MANF. INSTRUCTIONS

VESTRE VROOM ARMREST; INSTALLED

STN. STL DOWELS, (2) PER SECTION,

 $^{-}$ 6" DEPTH COMPACTED 1 $\frac{1}{4}$ " DIA CLEAN GRANITE AGGREGATE BASE, COMPACT

- COMPACTED/UNDISTURBED SUBGRADE

TO 98% PROCTOR DENSITY

TOP WITH BACK, CUSTOM RADIUS;

PER MANF. INSTRUCTIONS

BENCH; REINF. PER MANF.

- 1" RADIUS EDGE - 6" STANDARD CONCRETE

W/ #4 @16" O.C. EA. WAY,


 $-1\frac{1}{2}$ " RADIUS EDGE

CENTERED


EPOXY SEALD

PAVING PER PLAN

PRECAST CONCRETE

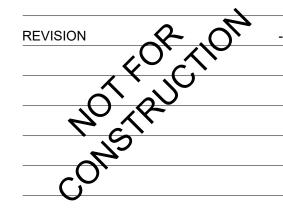

SITE DETAILS

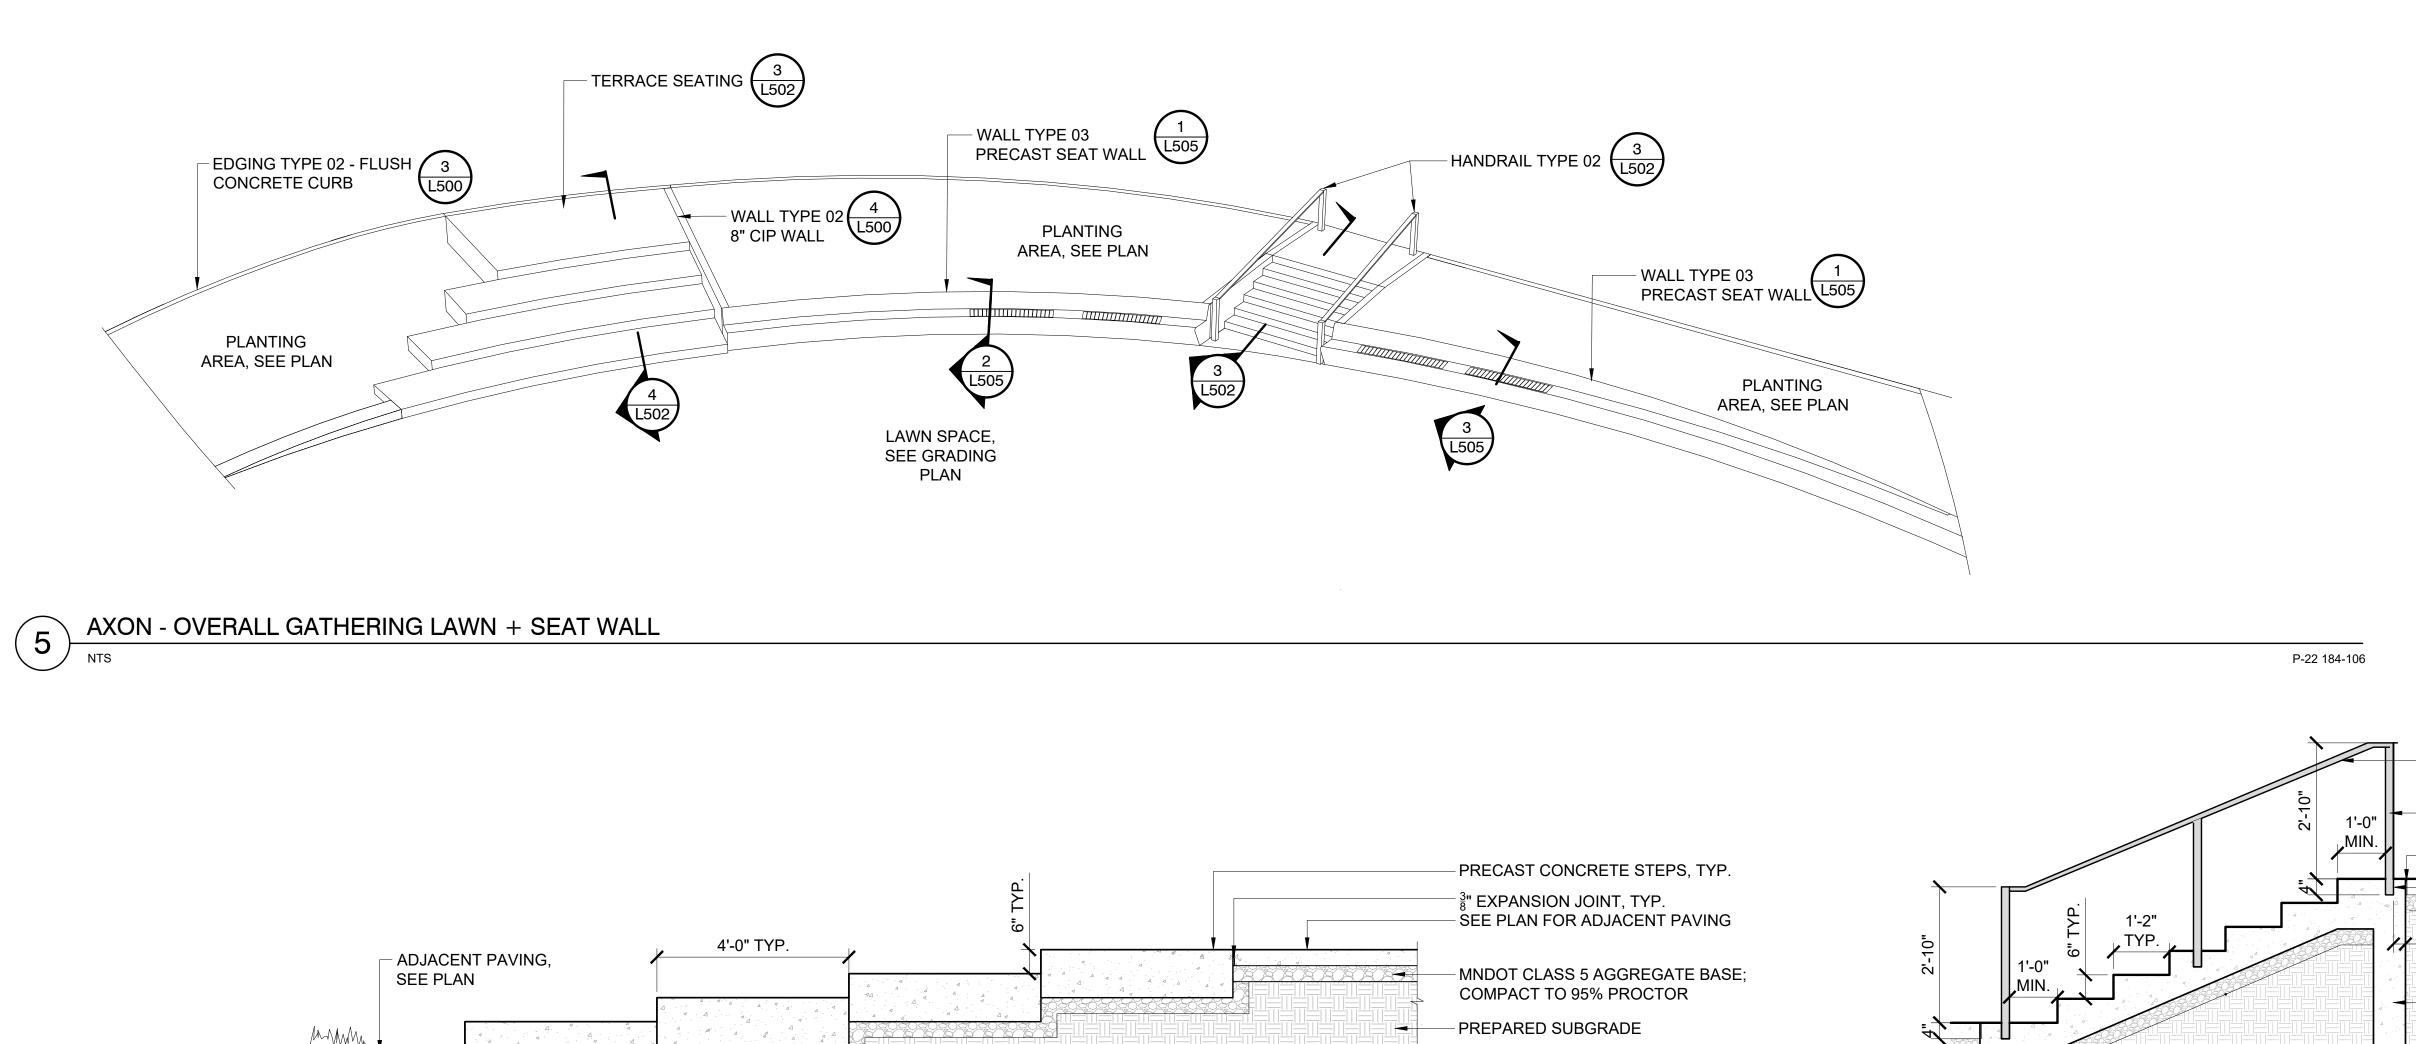

STAIR TYPE 02 - OVERSIZED STEPS AT LAWN

1/2" = 1'-0"

CONCRETE FOOTING SEE XXX FOR FOOTING DETAILS

STAIR TYPE 01 & HANDRAIL TYPE 02 - DETAIL 3

P-22 184-104 P-22 184-112

/ POWDERCOATED

SEE LIGHTING

BASE PLATE

STAINLESS STEEL TOP RAIL

✓ 4" X 4" POWDERCOATED

STAINLESS STEEL POSTS

- 1/2" X 3" POWDERCOATED

STAINLESS STEEL POSTS

RECESSED WALL LIGHT -

√ 1/2" X 3" POWDERCOATED

STAINLESS STEEL POSTS

P-22 184-98

2" X 1" POWDERCOATED **ALUMINUM TOP RAIL**

2" X 2" POWDERCOATED

EXPANSION JOINT, TYP.

EMBED POST 4" MIN INTO

ALUMINUM POSTS

6'-0" MAX. SEGMENT 6'-0" MAX. SEGMENT VESTRE, APRIL BAR TABLE, SURFACE MOUNT, 1 L502 POWDERCOATED 3 1/2" SEE SCHEDULE MAX. STAINLESS STEEL TOP RAIL 5'-0" GUARDRAIL TYPE 01 2'-10" - 4" X 4" POWDERCOATED RE: 1/L502 STAINLESS STEEL POSTS VESTRE, APRIL BAR TABLE, - 1/2" X 3" POWDERCOATED SURFACE MOUNT, SEE STAINLESS STEEL POSTS SCHEDULE RECESSED WALL LIGHT -— GUARDRAIL TYPE 01 SEE LIGHTING VESTRE, APRIL RE: 1/L502 BAR STOOL, SEE - 1/2" X 3" POWDERCOATED SCHEDULE STAINLESS STEEL POSTS SEE MANUFACTURERS SPECIFICATIONS FOR MOUNTING DETAILS POST SECTION BASE PLATE FRONT ELEVATION FRONT ELEVATION DETAIL - BAR HEIGHT TABLE AT GUARDRAIL **DETAIL - GUARDRAIL** 1/2" = 1'-0" P-22 184-99 1/2" = 1'-0"

Minnesota

CITY OF NORTHFIELD 801 WASHINGTON STREET

NORTHFIELD, MINNESOTA 55057 DAVID.BENNETT@CI.NORTHFIELD.MN.US

DAMON FARBER LANDSCAPE ARCHITECTS 310 S 4TH AVE

MINNEAPOLIS, MN 55415 RBLASEG@DAMONFARBER.COM 612.332.7522

BOLTON & MENK 7575 GOLDEN VALLEY ROAD SUITE 200

MINNEAPOLIS, MN 55427 BRADLEY.FISHER@BOLTON-MENK.COM 612.759.7240

NELSON-RUDIE & ASSOCIATES, 9100 49TH AVE N, MINNEAPOLIS, MN 55428

SARAH.GREFF@NELSONRUDIE.COM 763.367.7600

SCHULER & SHOOK 219 SE MAIN ST MINNEAPOLIS, MN 55414 PWHITAKER@SCHULERSHOOK.COM 612.339.5958

60% PRICING SET

NORTHFIELD BRIDGE SQUARE

NORTHFIELD, MN

I hereby certify that this document was prepared by me or under my direct supervision and that I am a duly licensed Landscape Architect under the laws of the State of Minnesota.


Tom Whitlock


26292


Date Signature 09/26/2023 22-184 DF/ Project # AS SHOWN RP/AG/BE/RB Drawn/Checked

Registration#

SITE DETAILS

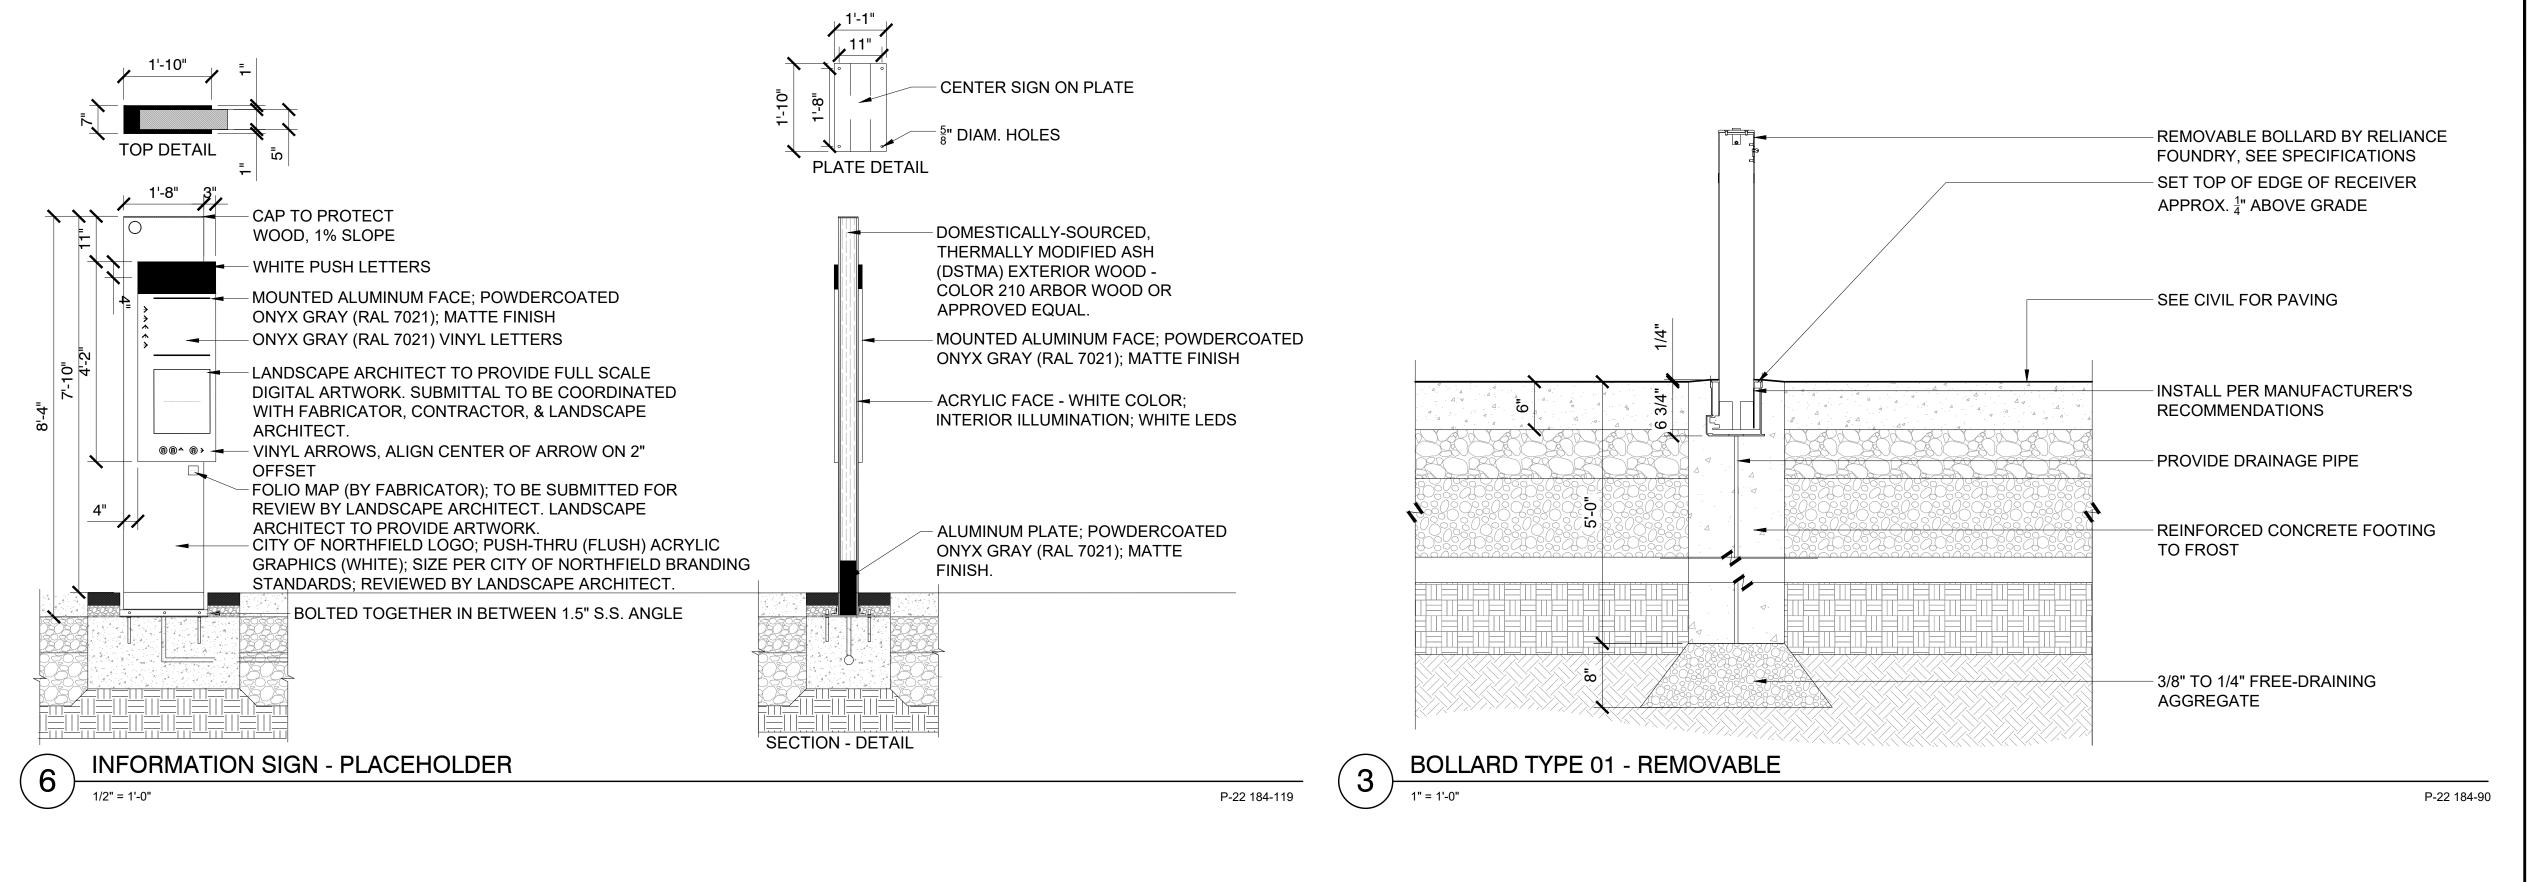


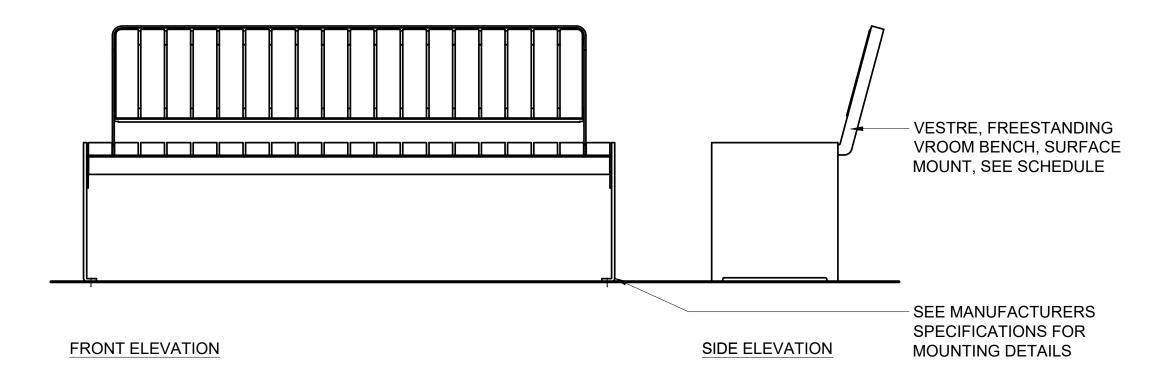

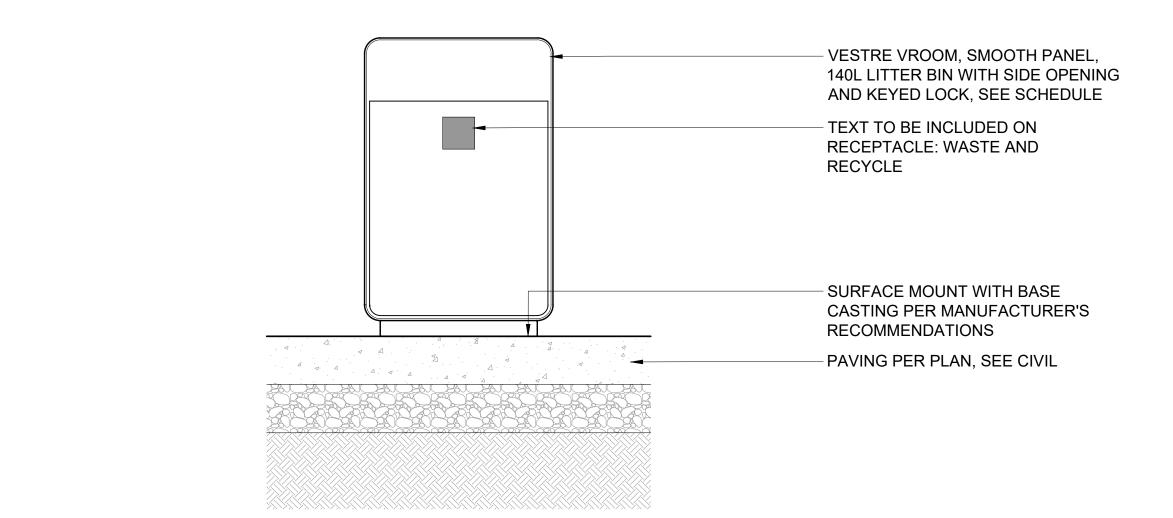


DETAIL - TRASH & RECYCLE RECEPTACLE

DETAIL - BIKE RACK

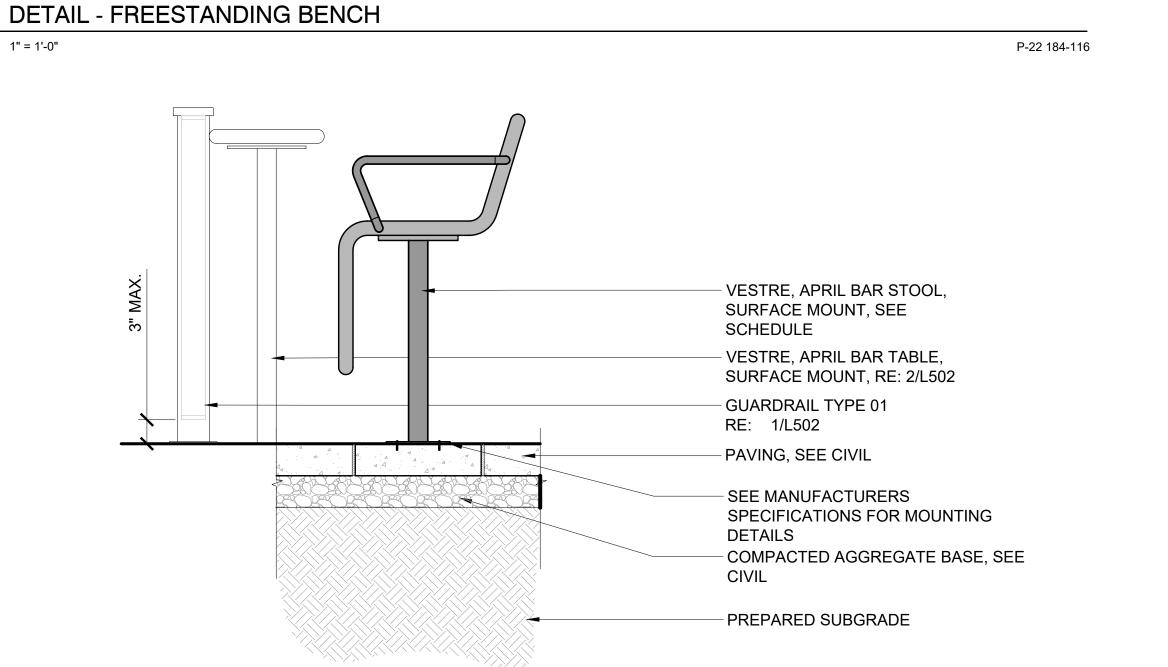

DETAIL - BAR STOOL

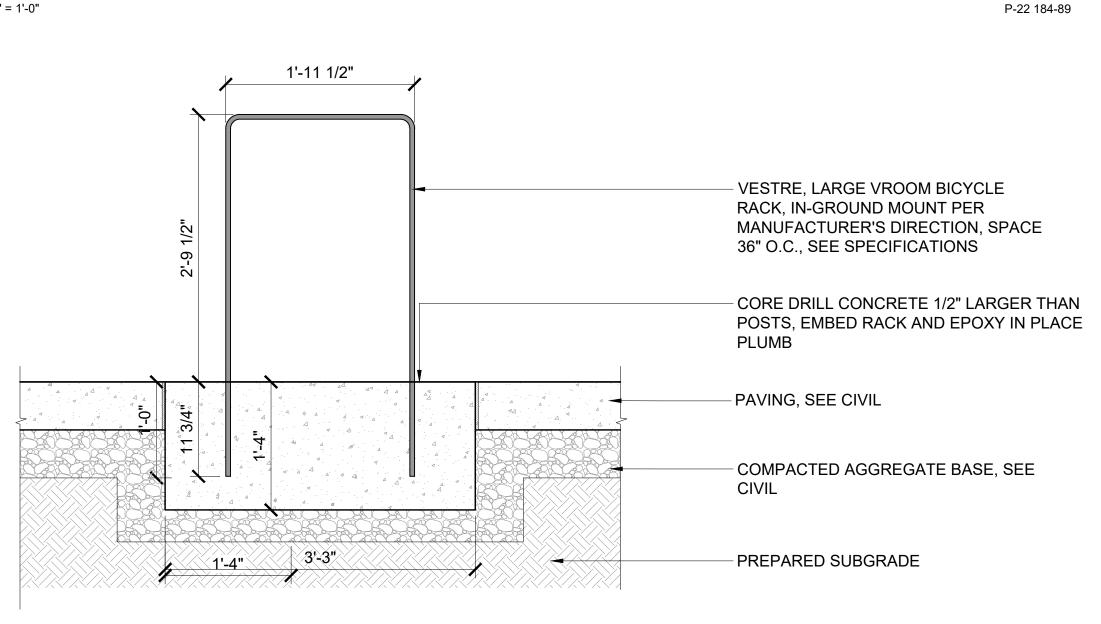

North field

CITY OF NORTHFIELD

Minnesota

801 WASHINGTON STREET
NORTHFIELD, MINNESOTA 55057
DAVID.BENNETT@CI.NORTHFIELD.MN.US

DAMON FARBER
LANDSCAPE ARCHITECTS
310 S 4TH AVE

MINNEAPOLIS, MN 55415 RBLASEG@DAMONFARBER.COM 612.332.7522

BOLTON & MENK
7575 GOLDEN VALLEY ROAD
SUITE 200
MINNEAPOLIS, MN 55427
BRADLEY.FISHER@BOLTON-MENK.COM
612.759.7240

NELSON-RUDIE & ASSOCIATES, 9100 49TH AVE N, MINNEAPOLIS, MN 55428

9100 491H AVE N, MINNEAPOLIS, MN 55428 SARAH.GREFF@NELSONRUDIE.COM 763.367.7600

SCHULER & SHOOK
219 SE MAIN ST
MINNEAPOLIS, MN 55414
PWHITAKER@SCHULERSHOOK.COM

612.339.5958

60% PRICING SET

NORTHFIELD BRIDGE SQUARE

NORTHFIELD, MN

Tom Whitlock

26292

I hereby certify that this document was prepared by me or under my direct supervision and that I am a duly licensed Landscape Architect under the laws of the State of Minnesota.

Registration#

Signature Date

09/26/2023

DF/ Project # 22-184

Scale AS SHOWN

Drawn/Checked RP/AG/BE/RB

REVISION ---


REVISION


SITE DETAILS


L503

P-22 184-73

P-22 184-115

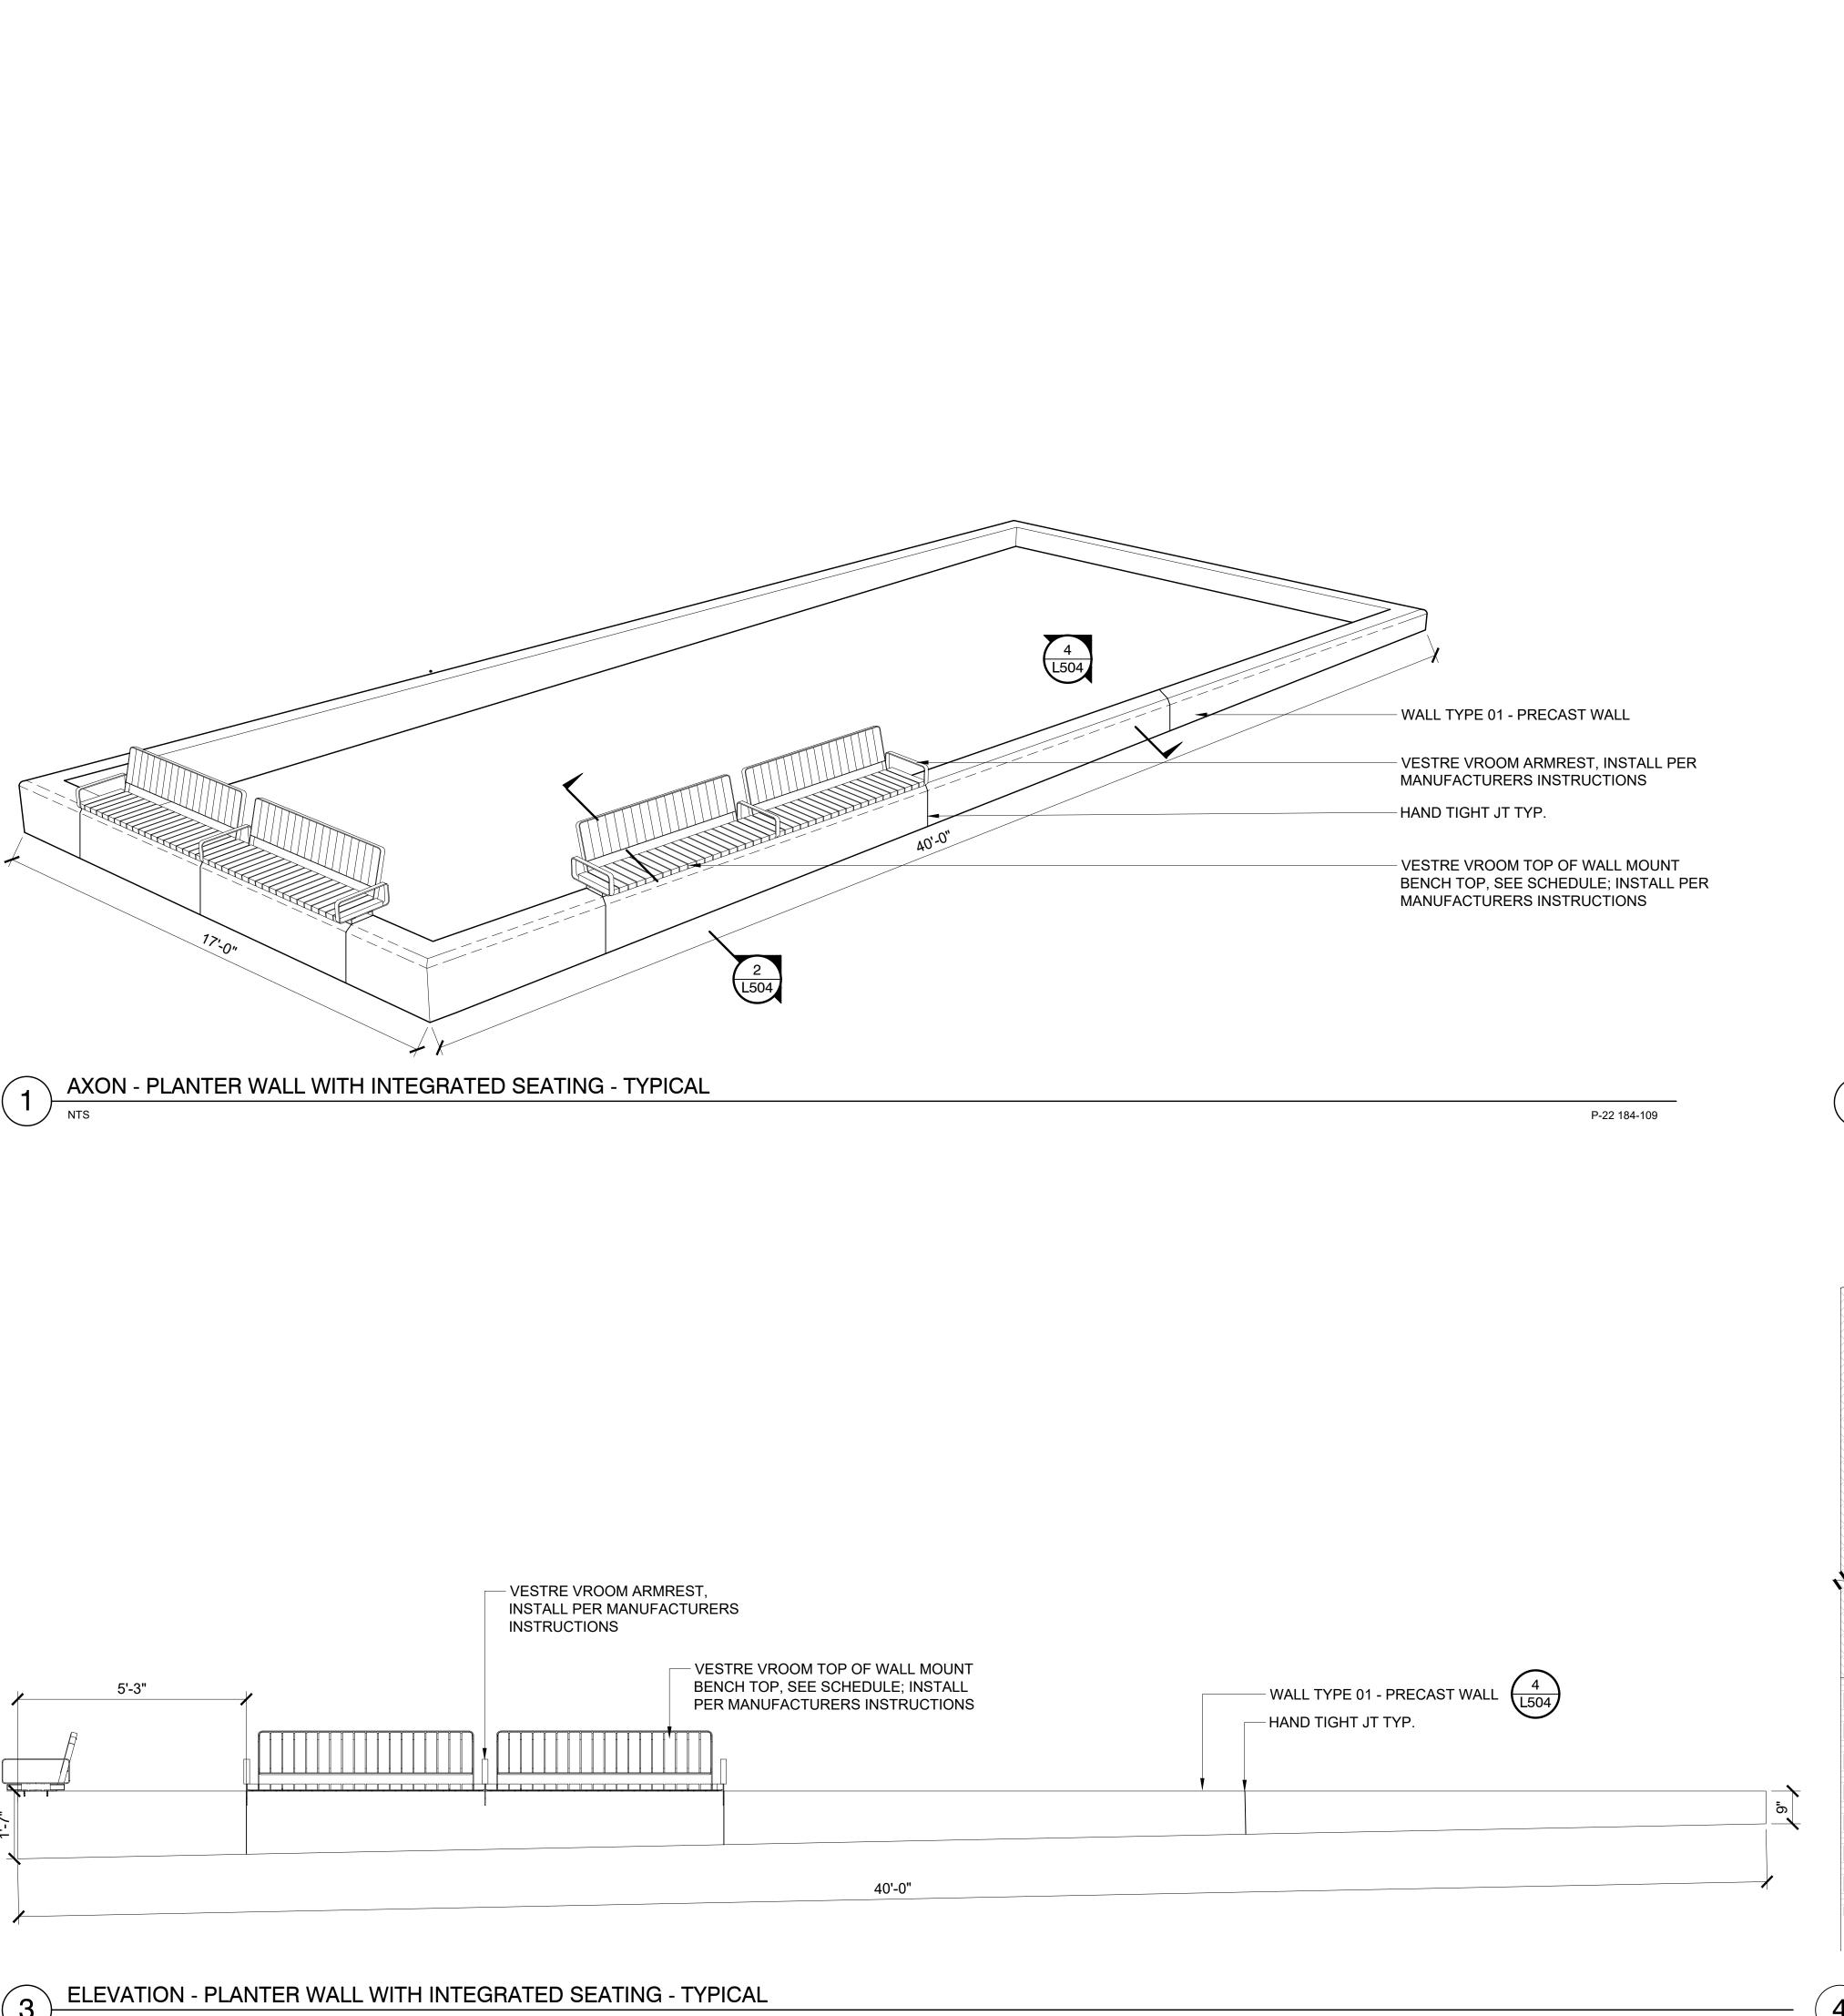

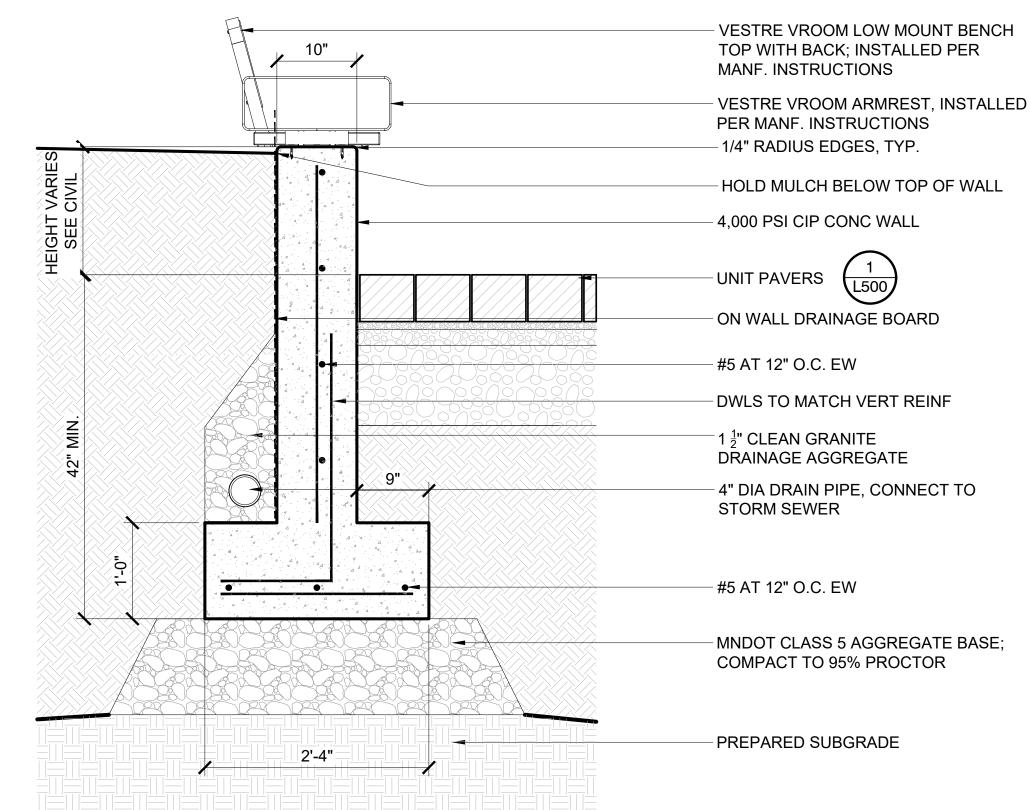

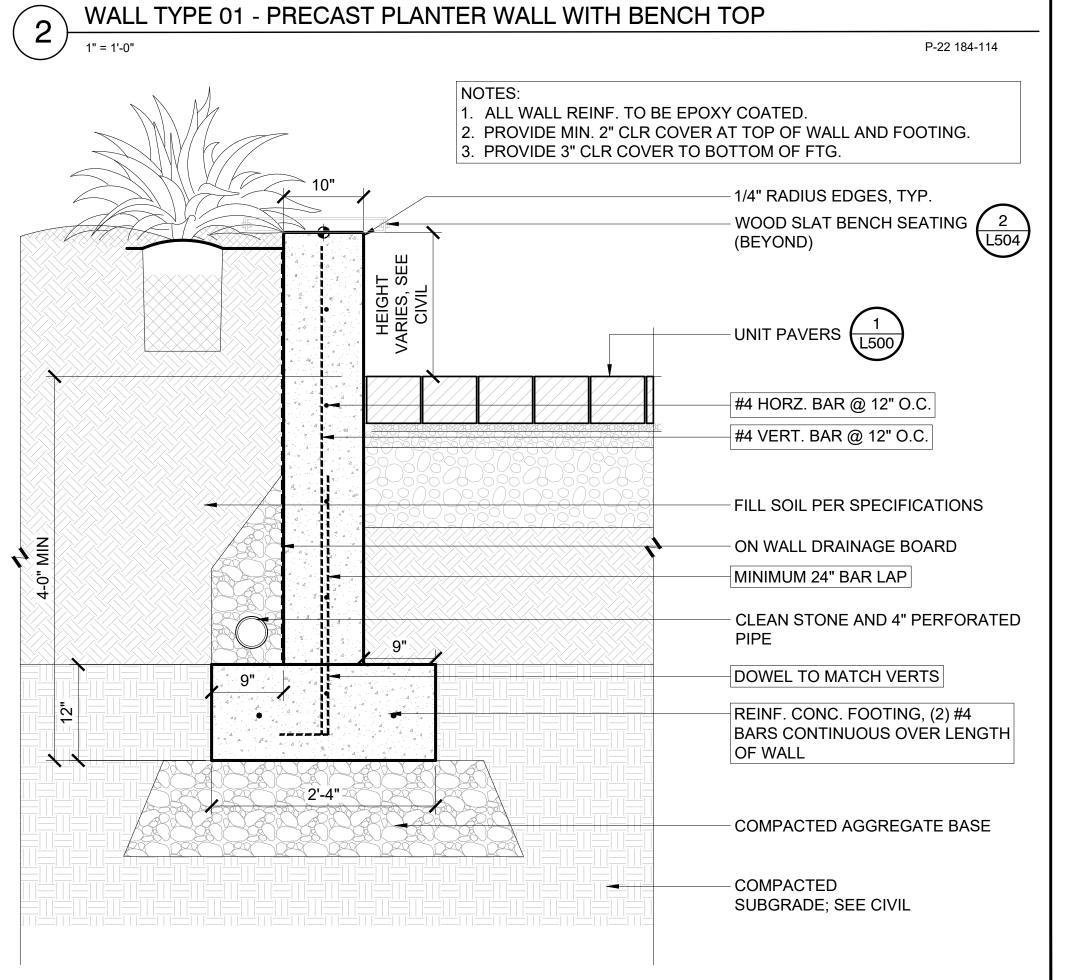

WALL TYPE 01 - PRECAST PLANTER WALL

North field

CITY OF NORTHFIELD

Minnesota

801 WASHINGTON STREET
NORTHFIELD, MINNESOTA 55057
DAVID.BENNETT@CI.NORTHFIELD.MN.US

DAMON FARBER
LANDSCAPE ARCHITECTS
310 S 4TH AVE

310 S 4TH AVE MINNEAPOLIS, MN 55415 RBLASEG@DAMONFARBER.COM 612.332.7522

BOLTON & MENK

7575 GOLDEN VALLEY ROAD SUITE 200 MINNEAPOLIS, MN 55427 BRADLEY.FISHER@BOLTON-MENK.COM 612.759.7240

NELSON-RUDIE & ASSOCIATES, 9100 49TH AVE N, MINNEAPOLIS, MN 55428

SARAH.GREFF@NELSONRUDIE.COM 763.367.7600 SCHULER & SHOOK

219 SE MAIN ST MINNEAPOLIS, MN 55414 PWHITAKER@SCHULERSHOOK.COM 612.339.5958

60% PRICING SET

NORTHFIELD BRIDGE SQUARE

NORTHFIELD, MN

I hereby certify that this document was prepared by me or under my direct supervision and that I am a duly licensed Landscape Architect under the laws of the State of Minnesota.

Tom Whitlock

Registration# 26292

Signature Date

09/26/2023

DF/ Project # 22-184

Scale AS SHOWN


Drawn/Checked RP/AG/BE/RB

REVISION ---

SITE DETAILS

L504

P-22 184-29

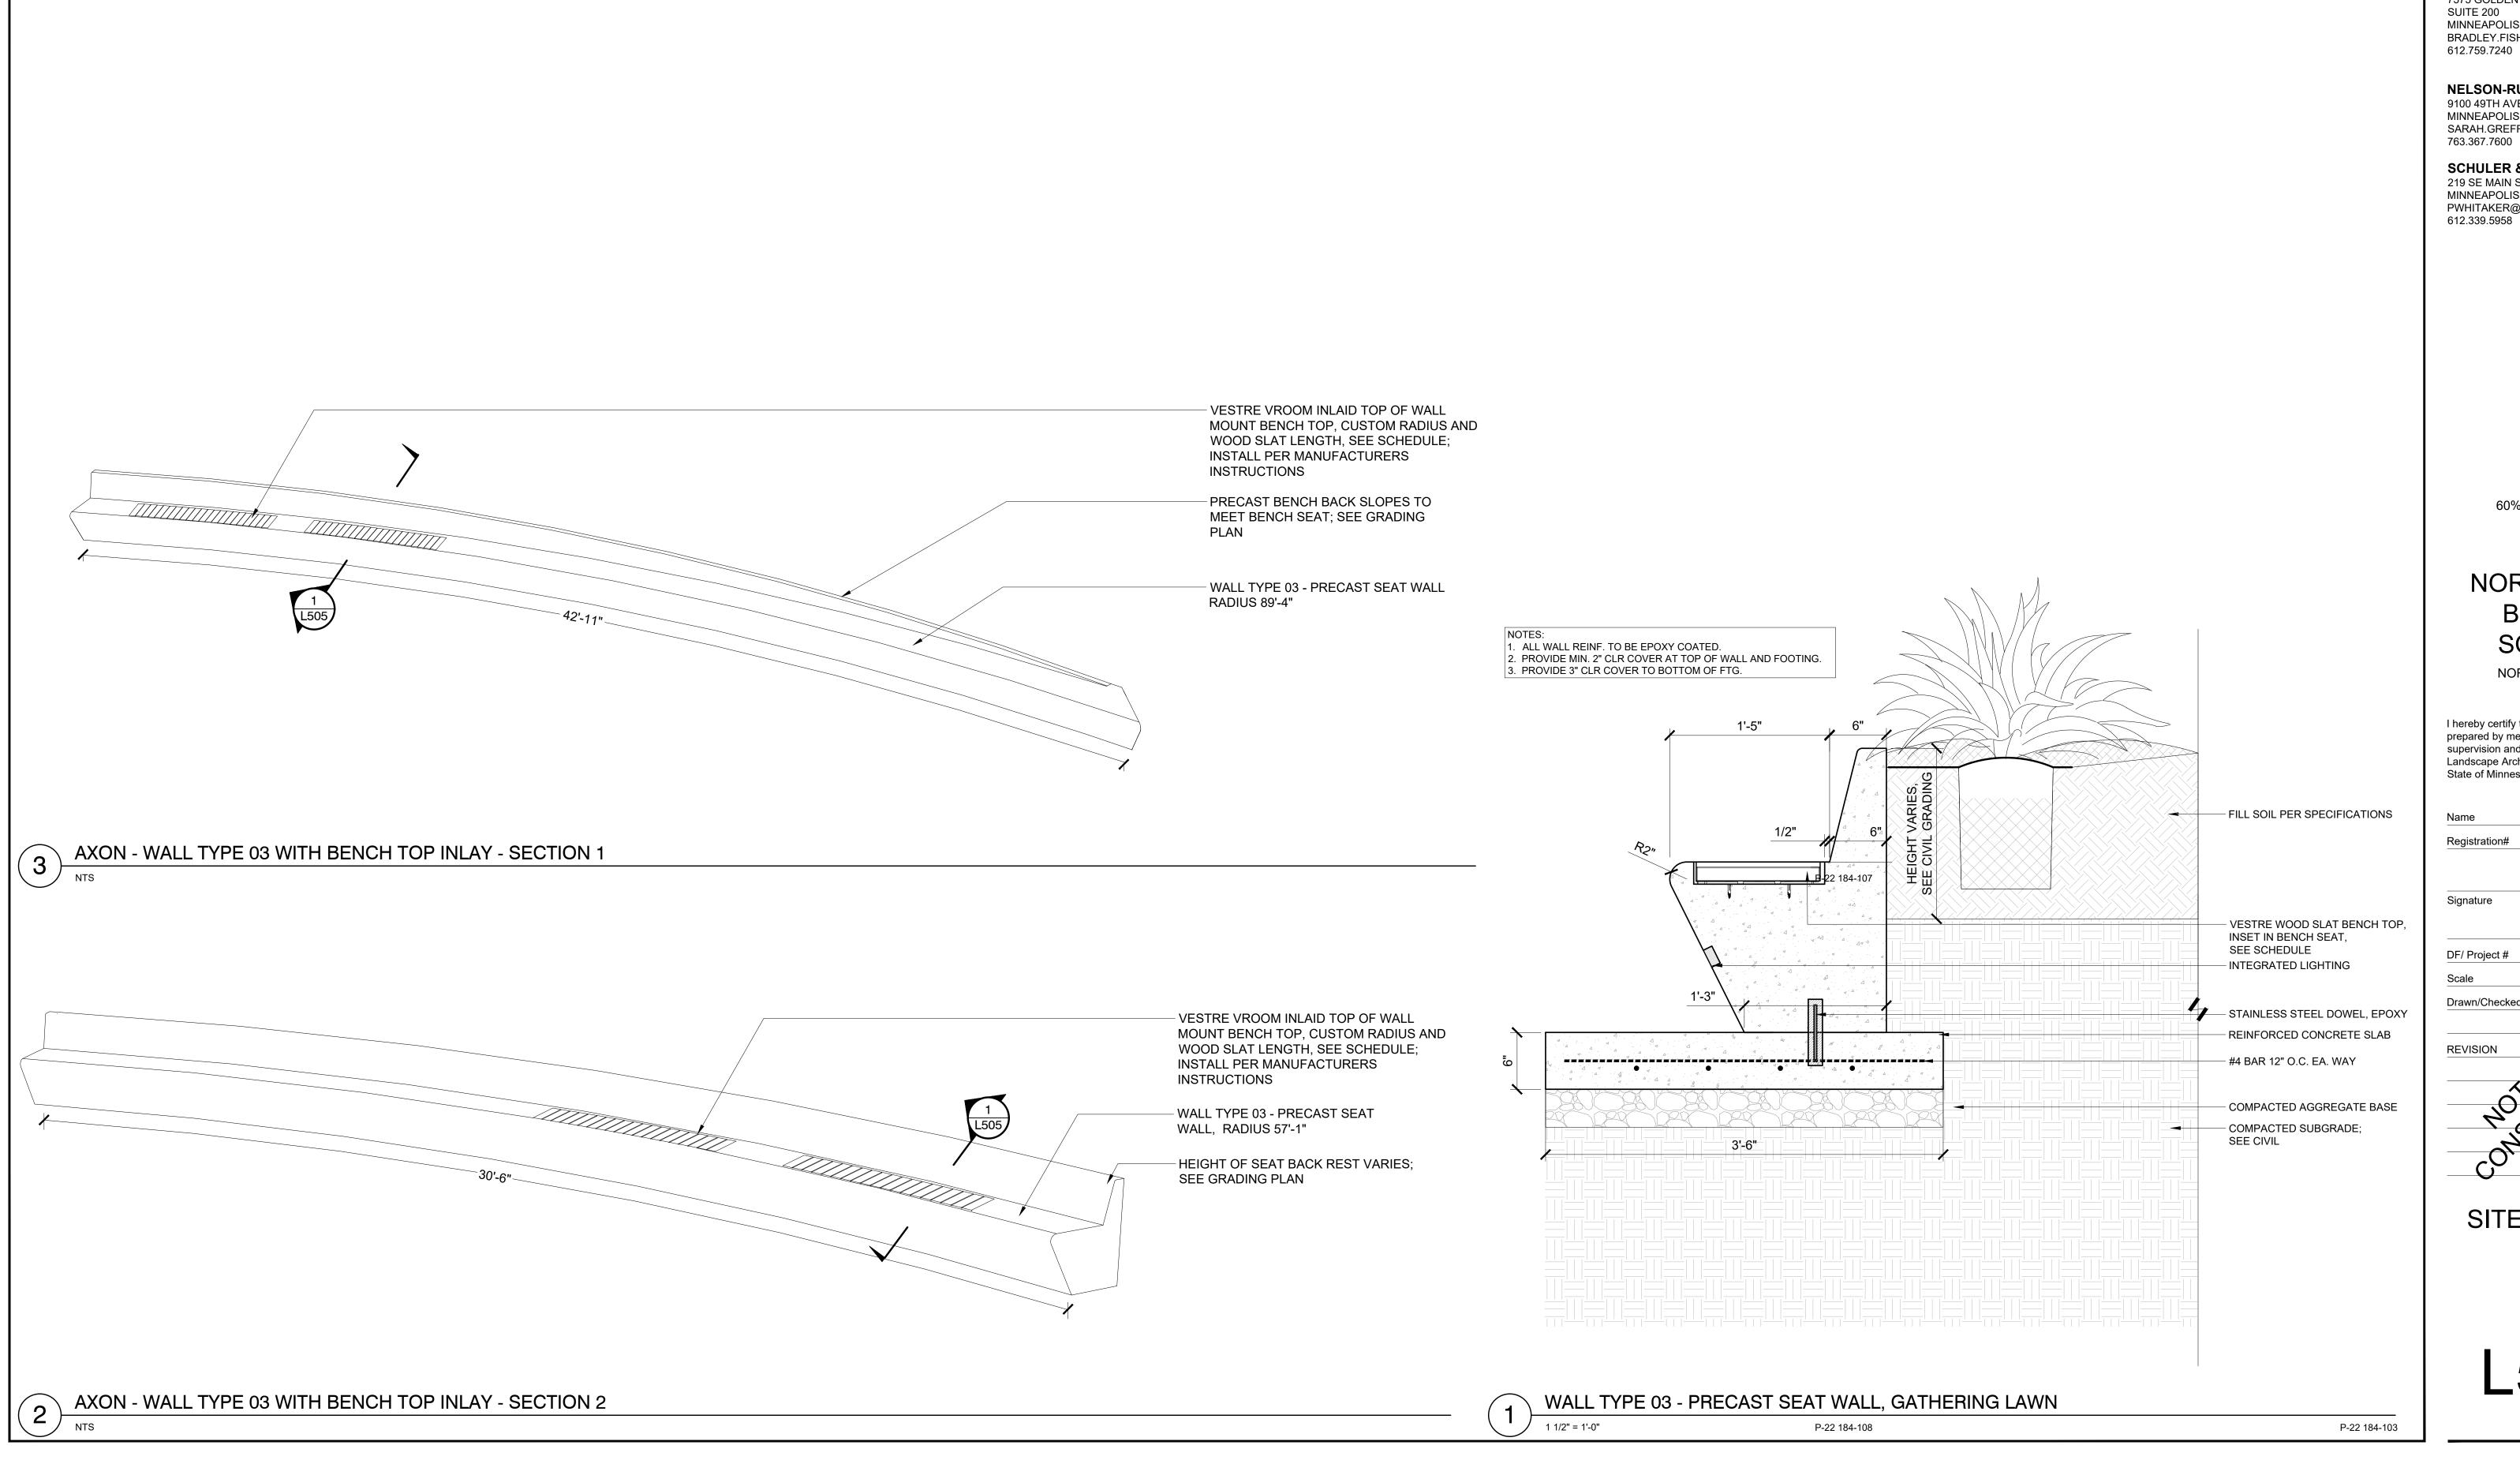

Northfield

DAVID.BENNETT@CI.NORTHFIELD.MN.US

Minnesota

CITY OF NORTHFIELD

801 WASHINGTON STREET

NORTHFIELD, MINNESOTA 55057

DAMON FARBER LANDSCAPE ARCHITECTS 310 S 4TH AVE MINNEAPOLIS, MN 55415

612.332.7522

BOLTON & MENK
7575 GOLDEN VALLEY ROAD
SUITE 200
MINNEAPOLIS, MN 55427
BRADLEY.FISHER@BOLTON-MENK.COM

RBLASEG@DAMONFARBER.COM

NELSON-RUDIE & ASSOCIATES, 9100 49TH AVE N, MINNEAPOLIS, MN 55428 SARAH.GREFF@NELSONRUDIE.COM

SCHULER & SHOOK 219 SE MAIN ST MINNEAPOLIS, MN 55414 PWHITAKER@SCHULERSHOOK.COM

60% PRICING SET

NORTHFIELD BRIDGE SQUARE

NORTHFIELD, MN

I hereby certify that this document was prepared by me or under my direct supervision and that I am a duly licensed Landscape Architect under the laws of the State of Minnesota.

Tom Whitlock

 Registration#
 26292


 Signature
 Date

 09/26/2023


 DF/ Project #
 22-184


 Scale
 AS SHOWN

 Drawn/Checked
 RP/AG/BE/RB

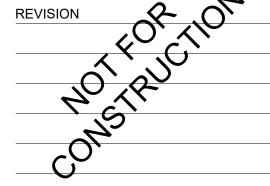

SITE DETAILS

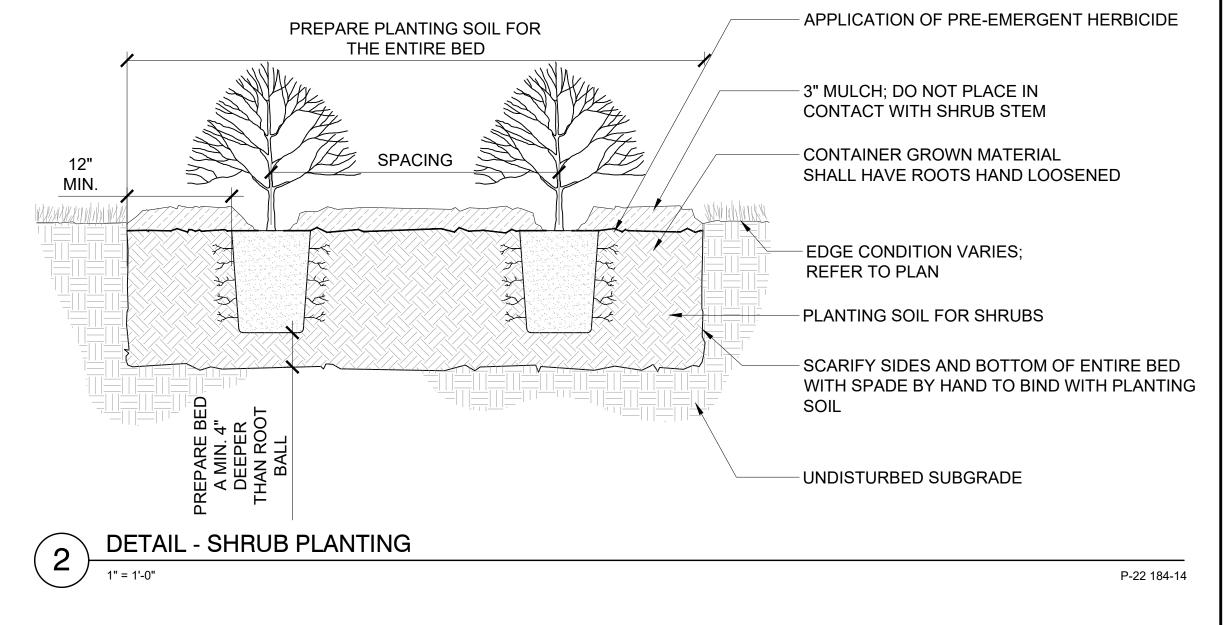

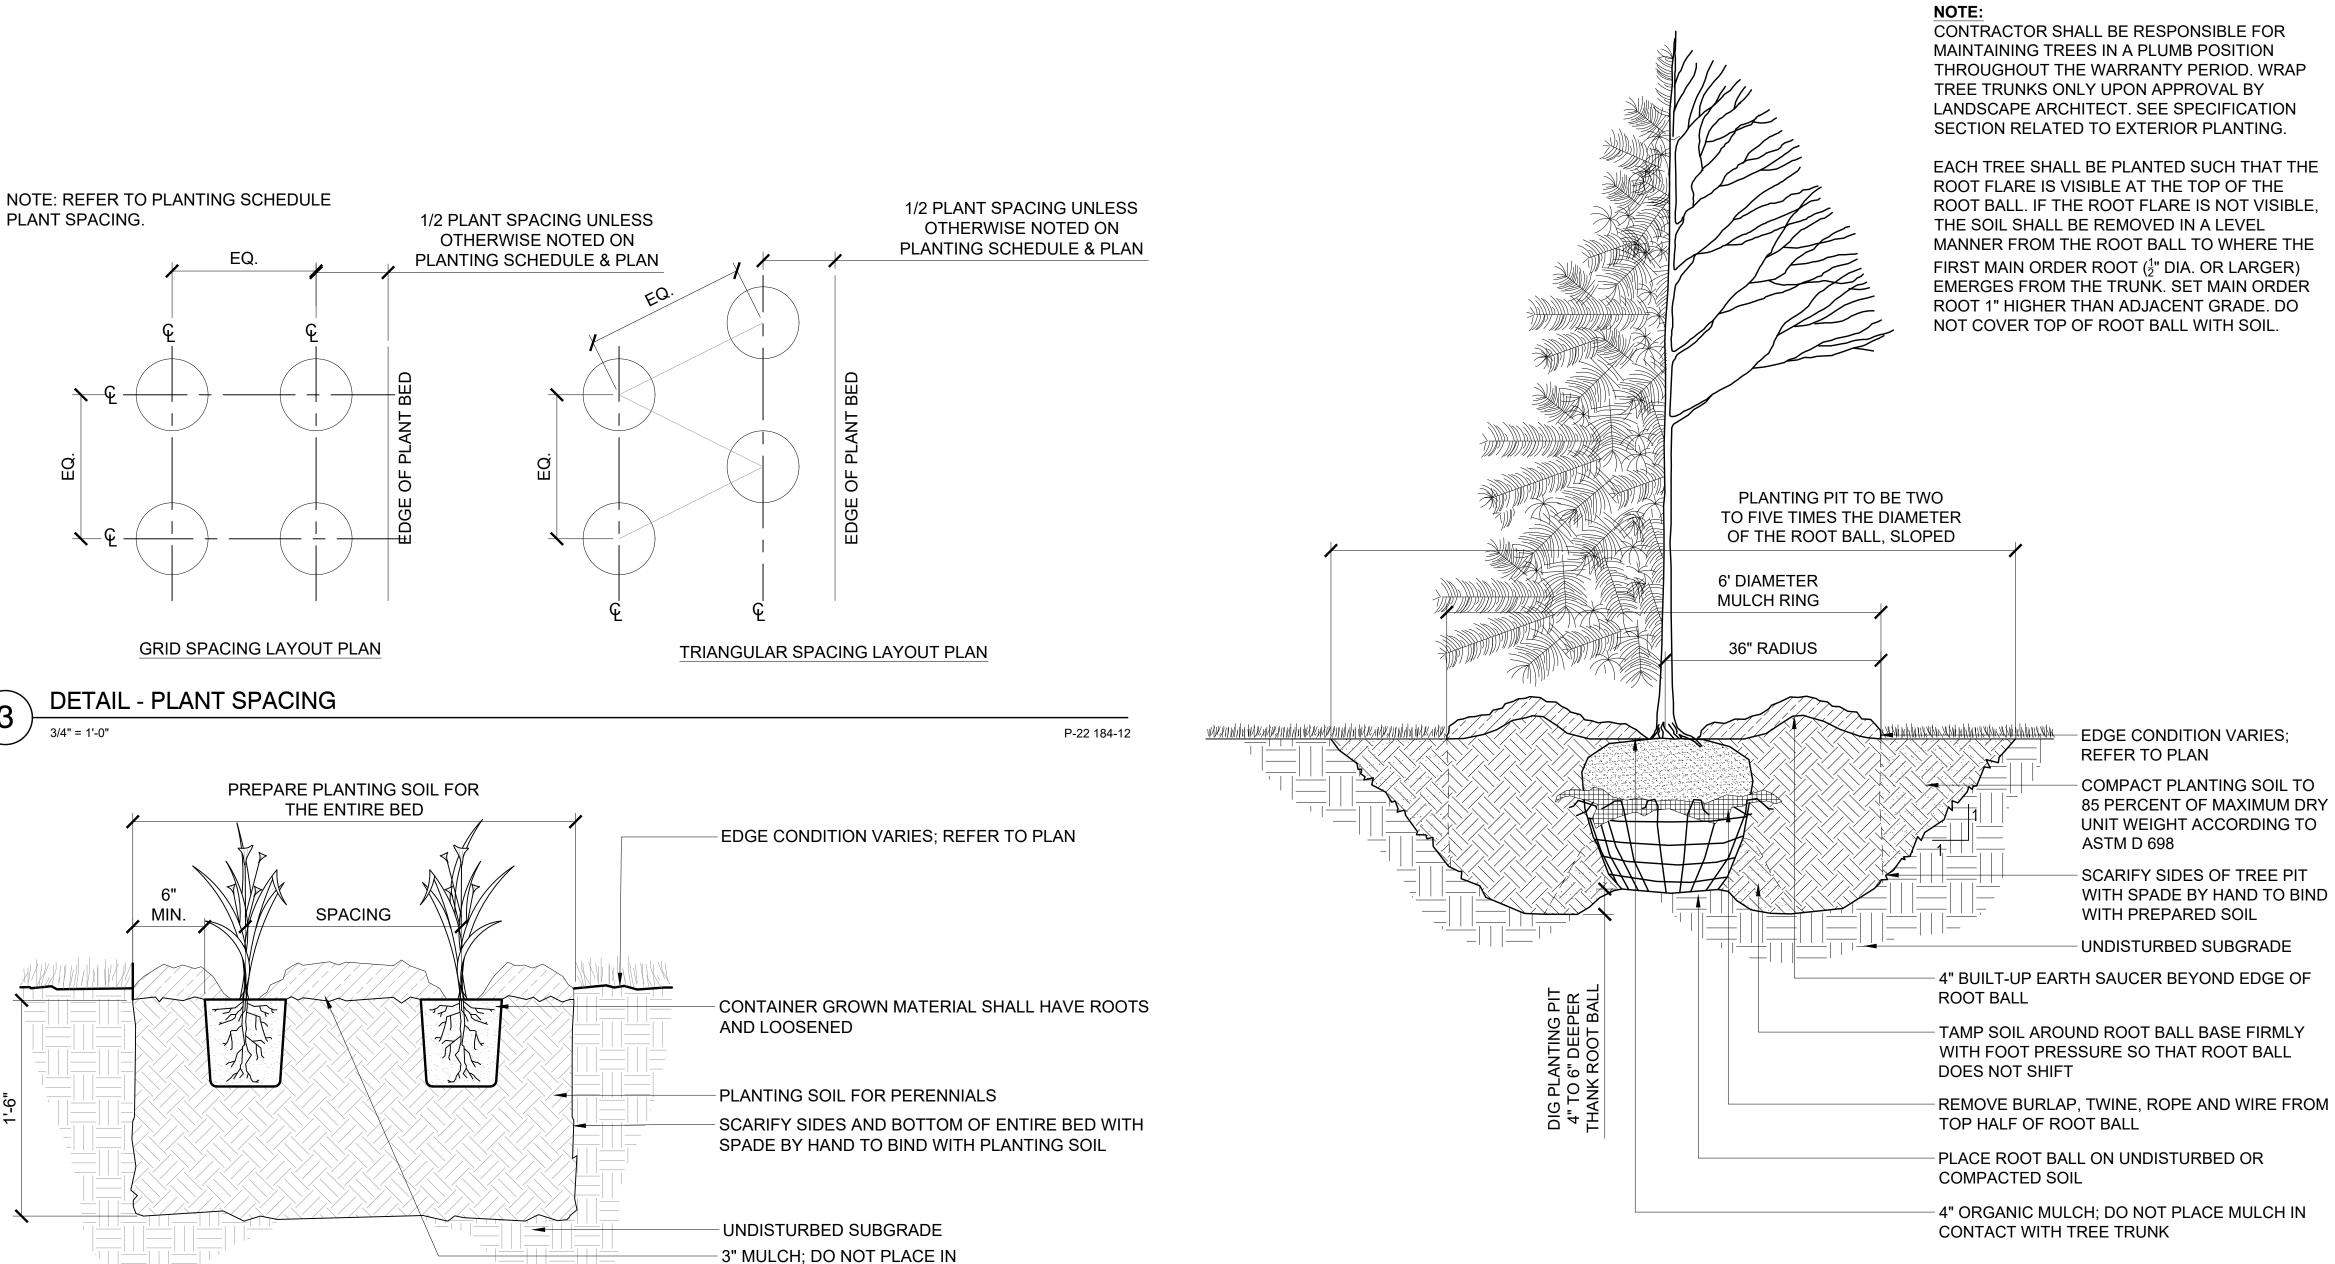

P-22 184-16

TREE PLANTING DETAIL

CONTACT WITH PLANT STEM

DETAIL - PERENNIAL PLANTING

3

1 1/2" = 1'-0"

Vorthfield

Minnesota

CITY OF NORTHFIELD

801 WASHINGTON STREET
NORTHFIELD, MINNESOTA 55057
DAVID.BENNETT@CI.NORTHFIELD.MN.US

DAMON FARBER
LANDSCAPE ARCHITECTS

310 S 4TH AVE
MINNEAPOLIS, MN 55415
RBLASEG@DAMONFARBER.COM

612.332.7522 **BOLTON & MENK**

7575 GOLDEN VALLEY ROAD SUITE 200 MINNEAPOLIS, MN 55427 BRADLEY.FISHER@BOLTON-MENK.COM 612.759.7240

NELSON-RUDIE & ASSOCIATES, 9100 49TH AVE N,

MINNEAPOLIS, MN 55428 SARAH.GREFF@NELSONRUDIE.COM 763.367.7600

SCHULER & SHOOK

219 SE MAIN ST MINNEAPOLIS, MN 55414 PWHITAKER@SCHULERSHOOK.COM 612.339.5958

60% PRICING SET

NORTHFIELD BRIDGE SQUARE

NORTHFIELD, MN

I hereby certify that this document was prepared by me or under my direct supervision and that I am a duly licensed Landscape Architect under the laws of the State of Minnesota.

Registration#

Tom Whitlock

26292

Signature Date

09/26/2023

DF/ Project # 22-184

Scale AS SHOWN


Drawn/Checked RP/AG/BE/RB

REVISION

SITE LANDSCAPE DETAILS

L506

P-22 184-10

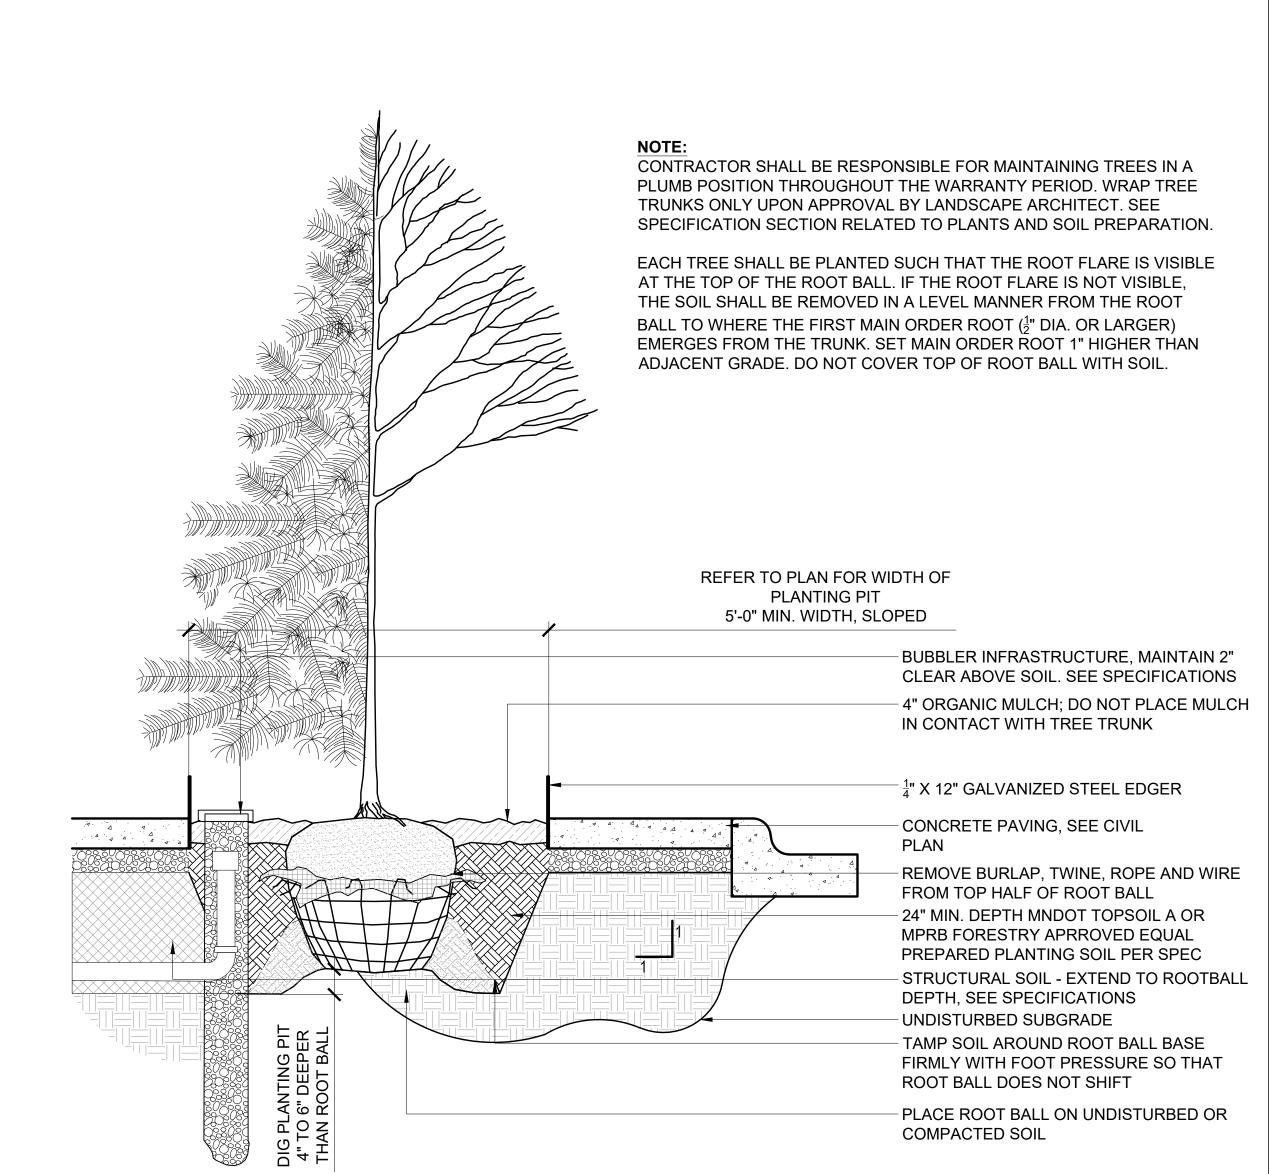

DETAIL - TREE PLANTING IN STREETSCAPE

3/4" = 1'-0"

CITY OF NORTHFIELD

Minnesota

801 WASHINGTON STREET NORTHFIELD, MINNESOTA 55057 DAVID.BENNETT@CI.NORTHFIELD.MN.US

> **DAMON FARBER** LANDSCAPE ARCHITECTS

> 310 S 4TH AVE MINNEAPOLIS, MN 55415 RBLASEG@DAMONFARBER.COM 612.332.7522

BOLTON & MENK 7575 GOLDEN VALLEY ROAD SUITE 200 MINNEAPOLIS, MN 55427 BRADLEY.FISHER@BOLTON-MENK.COM 612.759.7240

NELSON-RUDIE & ASSOCIATES, 9100 49TH AVE N, MINNEAPOLIS, MN 55428

SARAH.GREFF@NELSONRUDIE.COM 763.367.7600

SCHULER & SHOOK 219 SE MAIN ST MINNEAPOLIS, MN 55414 PWHITAKER@SCHULERSHOOK.COM 612.339.5958

60% PRICING SET

NORTHFIELD BRIDGE SQUARE

NORTHFIELD, MN

I hereby certify that this document was prepared by me or under my direct supervision and that I am a duly licensed Landscape Architect under the laws of the State of Minnesota.

Tom Whitlock

26292

Registration# Date Signature 09/26/2023 22-184 DF/ Project # AS SHOWN RP/AG/BE/RB Drawn/Checked

REVISION

SITE LANDSCAPE **DETAILS**

P-22 184-49

					ELECTRICAL	SY	MB)	OLS					
	LIGHTING SYMBOLS			SYSTEM	MS SYMBOLS	SYSTEMS SYMBOLS				POWER SYMBOLS			
MNT	SYMBOL	DESCRIPTION	MNT HT	SYMBOL	DESCRIPTION	MNT HT	SYMBOL	DESCRIPTION	MNT HT	SYMBOL	DESCRIPTION		
	<u> </u>	STRIP FLUORESCENT WALL MOUNTED FLUORESCENT	80"	F	VISUAL ANNUNCIATOR	18" 54"	∅	TELEPHONE OUTLET TELEPHONE OUTLET - WALL	18"	\mapsto	RECEPTACLE - SIMPLEX		
		1X4 FLUORESCENT	80"	F	AUDIBLE/VISUAL ANNUNCIATOR			TELEPHONE OUTLET - FLOOR	18"	\bigoplus	RECEPTACLE - DUPLEX RECEPTACLE - QUADPLEX		
		2X2 FLUORESCENT	48"	F	MANUAL PULL	18"		TELEPHONE BACKBOARD DATA OUTLET		\oplus	RECEPTACLE - CEILING MOUNT		
		2X4 FLUORESCENT		(F)	BELL/STROBE - CEILING MOUNTED SMOKE DETECTOR - PHOTOELECTRIC		7	DATA OUTLET - FLOOR	18"		RECEPTACLE - DUPLEX EMERGENCY		
	0 6	DOWNLIGHT WALLWASHER		© _P	SMOKE DETECTOR - IONIZATION	18"		VOICE/DATA OUTLET	18"		RECEPTACLE - QUADPLEX EMERGENCY		
	Ř	INT/EXT WALL FIXTURE/SCONCE		E _{DP}	DUCT SMOKE DETECTOR - PHOTOELECTRIC	4011		VOICE/DATA OUTLET - FLOOR	18"		RECEPTACLE - SWITCHED		
		HIGH BAY 1X4 FLUORESCENT - EMERGENCY		(F) _{DI}	DUCT SMOKE DETECTOR - IONIZATION	18"		DUAL DATA DUAL DATA - FLOOR		├	COMPUTER RECEPTACLE - DUPLEX COMPUTER RECEPTACLE - QUADPLEX		
		2X2 FLUORESENT - EMERGENCY		E _H	HEAT DETECTOR		HC	CLOCK OUTLET			COMPUTER RECEPTACLE - QUADPLEX COMPUTER RECEPTACLE - DUPLEX CEILING MOUNT		
		2X4 FLUORESCENT - EMERGENCY	0.0"	O B H	DOOR HOLD OPEN		H	HORN		+	COMPUTER RECEPTACLE - QUADPLEX CEILING MOUNT		
		STRIP/WRAP - EMERGENCY DOWNLIGHT - EMERGENCY	80" 80"		BELL HORN		\$	SPEAKER - CEILING			COMPUTER RECEPTACLE - DUPLEX FLOOR COMPUTER RECEPTACLE - QUADPLEX FLOOR		
		WALLWASHER - EMERGENCY	54"	FAAP	FIRE ALARM ANNUNCIATOR PANEL	54"	HS) H⇔	SPEAKER - WALL VOLUME CONTROL			RECEPTACLE - QUADPLEX FLOOR		
		LIGHTING TRACK/BUSWAY - HEADS PER DRAWINGS BATTERY PACK	54"	FACP	FIRE ALARM CONTROL PANEL	54"	$\vdash \stackrel{\checkmark}{ \bigcirc}$	MICROPHONE - WALL			RECEPTACLE - QUADPLEX FLOOR		
	40	BATTERY PACK - 3 HEAD		FS TS	FLOW SWITCH TAMPER SWITCH			MICROPHONE - FLOOR			RECEPTACLE - QUAD FLOOR EMERGENECY		
	7 42 AA -	REMOTE HEADS - SINGLE, DOUBLE, TRIPLE EXITLIGHT - WALL					H/	BUZZER BELL			RECEPTACLE - SPECIAL PURPOSE - SEE DWGS		
	•	EXITLIGHT - CEILING					H_H	CHIME	18"		RECEPTACLE - SPECIAL PURPOSE - SEE DWGS		
	⊶ □ ■	SITE LIGHT - POLE MOUNT IN-GRADE FIXTURE				54"	H lacktriangle	PUSHBUTTON	18"	HŪ	JUNCTION BOX - WALL		
	\triangleright	FLOOD LIGHT					PD	POWER/DATA RACEWAY			JUNCTION BOX - CEILING		
						18"	$\vdash \downarrow \downarrow \downarrow$	TV OUTLET - WALL			JUNCTION BOX - FLOOR		
	\$	SWITCH - SIMPLEX					$\langle \downarrow \rangle$	TV OUTLET - CEILING	54"	9	MOTOR DISCONNECT SWITCH		
	\$ D	SWITCH - PILOT LIGHT SWITCH - DIMMER; WATTAGE						REFRIGERATION CONTROL CONDUIT	54"	F	FUSED DISCONNECT SWITCH		
	[⊥] 600	OCCUPANCY SENSOR							54"	\boxtimes	STARTER		
	LC	LIGHTING CONTACTOR				İ	MISCELLA	ANEOUS SYMBOLS		•	PUSHBUTTON		
	LR (PC)	LOW VOLTAGE RELAY PHOTO-CELL					$\langle 1 \rangle$	KEY NOTE		⊬→ ^{MSS} ⊢①	MOTOR STARTER SWITCH THERMOSTAT		
							$\langle \overline{ZZZ} \rangle$	EQUIPMENT TAG			COMBINATION STARTER-DISCONNECT		
							\^			С	CONTACTOR		
											GROUND		
										M	METER		
										ATS	AUTOMATIC TRANSFER SWITCH LTG/REC PANELBOARD		
											DISTRIBUTION PANELBOARD		

ELECTRICAL SHEET LIST E001 ELECTRICAL TITLE SHEET E100 ELECTRICAL SITE PLAN E200 ELECTRICAL DETAILS



CITY OF NORTHFIELD

Minnesota

801 WASHINGTON STREET NORTHFIELD, MINNESOTA 55057 DAVID.BENNETT@CI.NORTHFIELD.MN.US

DAMON FARBER LANDSCAPE **ARCHITECTS** 310 S 4TH AVE MINNEAPOLIS, MN 55415 RBLASEG@DAMONFARBER.COM 612.332.7522

BOLTON & MENK 7575 GOLDEN VALLEY ROAD

SUITE 200 MINNEAPOLIS, MN 55427 DAVE.REY@BOLTON-MENK.COM 763.544.7129

NELSON-RUDIE & ASSOCIATES, 9100 49TH AVE N, MINNEAPOLIS, MN 55428 SARAH.GREFF@NELSONRUDIE.COM 763.367.7600

SCHULER & SHOOK

219 SE MAIN ST MINNEAPOLIS, MN 55414 PWHITAKER@SCHULERSHOOK.COM 612.339.5958

60% PRICING SET

NORTHFIELD BRIDGE SQUARE

NORTHFIELD, MN

I hereby certify that this document was prepared by me or under my direct supervision and that I am a duly licensed Landscape Professional Engineer under the laws of the State of Minnesota.

Signature	Date
	05/26/2023
N-R/ Project #	23-009

Registration#

SJG/JAP Drawn/Checked

AS SHOWN

ELECTRICAL TITLE SHEET



GENERAL NOTES:

- A. XCEL ENERGY IS THE ELECTRICAL UTILITY AND ERIC HAGEN (507-334-2938, ERIC.HAGEN@XCELENERGY.COM) WILL BE THE DESIGNER FOR THE PROJECT.
- B. UTILITY IS RESPONSIBLE FOR TRANSFORMER, PRIMARY SIDE CABLE, AND CONNECTIONS. ELECTRICAL CONTRACTOR IS RESPONSIBLE FOR CONNECTIONS TO SECONDARY SIDE OF TRANSFORMER AND ALL OTHER DOWNSTREAM EQUIPMENT AND CONNECTIONS. COST FOR THE EXTENSION OF UTILITY INFRASTRUCTURE TO THE POINT OF UTILITY TRANSFORMER IS THE OWNER'S RESPONSIBILITY.
- C. THE ELECTRICAL CONTRACTOR SHALL FIELD VERIFY ALL SITE CONDITIONS PRIOR TO CONSTRUCTION.
- D. ELECTRICAL CONTRACTOR SHALL VERIFY ALL CONDUIT AND CABLE SIZING AND ADJUST TO COMPENSATE FOR VOLTAGE DROP, AS REQUIRED.
- E. COORDINATE ROUTING OF CONDUIT AND CABLES WITH GC AND CIVIL ENGINEER TO AVOID MAJOR ROOT SYSTEMS OF TREES AND OTHER AREAS, AS REQUIRED.
- F. SEE SPECIFICATIONS FOR ADDITIONAL REQUIREMENTS.
- G. ALL CONNECTION CABINETS SHALL HAVE PANELBOARDS OR OTHER MEANS OF FEEDING LOADS INDICATED LOCATED WITHIN, UNLESS NOTED OTHERWISE.

KEY NOTES:

- 1 PROPOSED UTILITY SERVICE TRANSFORMER LOCATION.
- 2 STAGE ELECTRICAL CONNECTION CABINET. PROVIDE A FEED FOR A 200A, 110/220V TO THE CABINET. SEE DETAIL 2/E200 FOR ADDITIONAL INFORMATION.
- VENDOR PEDESTAL. EATON #CHU2G2G2GS OR APPROVED EQUAL. EC SHALL PROVIDE A WEATHERPROOF NEMA 3R RECEPTACLE ENCLOSURE ATTACHED TO LIGHT POLE OR POST WITH CONCRETE BASE AT LOCATION SHOWN. MOUNT ENCLOSURE AT 24" ABOVE GRADE. CAULK PEDESTAL TO BASE OR POLE, AND SEAL CONDUIT OPENINGS. PROVIDE NEW FEEDER BURIED 24" BELOW GRADE FROM RECEPTACLE TO PANEL XXX. PROVIDE A 3" RIGID STEEL SLEEVE WHERE PVC CONDUIT PASSES BELOW DRIVEWAY OR PARKING AREAS. EC TO PROVIDE A #6 GROUNDING CONDUCTOR AND MAKE CONNECTIONS TO GROUND AT LIGHT POLE. PROVIDE (2) 20A 120V RECEPTACLES IN EACH ENCLOSURE. SEE DETAIL 1/E200 FOR MORE INFORMATION.
- FOOD TRUCK PEDESTAL. EATON #CHU1N4NS OR APPROVED

 EQUAL. EC SHALL PROVIDE A WEATHERPROOF NEMA 3R
 RECEPTACLE ENCLOSURE ON A PEDESTAL AT LOCATION
 SHOWN. MOUNT ENCLOSURE AT 24" ABOVE GRADE. PROVIDE
 REINFORCED CONCRETE BASE FOR PEDESTAL. SEAL CONDUIT
 OPENINGS. PROVIDE NEW FEEDER BURIED 24" BELOW GRADE
 FROM RECEPTACLE TO PANEL XXX. PROVIDE A 3" RIGID STEEL
 SLEEVE WHERE PVC CONDUIT PASSES BELOW DRIVEWAY OR
 PARKING AREAS. EC TO PROVIDE A 10'-0" DRIVEN GROUND ROD
 AND #6 GROUNDING CONDUCTOR AND MAKE CONNECTIONS AT
 PANEL. PROVIDE (1) 30A AND (1) 50A 120V RECEPTACLE IN
 EACH ENCLOSURE. SEE DETAIL 1/E200 FOR MORE
 INFORMATION.
- 5 LOCATION OF SITE LUMINAIRE. REFER TO THE 'AL' SERIES OF DRAWINGS FOR ADDITIONAL INFORMATION.
- (6) IN-WALL LIGHTING. PROVIDE JUNCTION BOXES ALONG THE WALL FOR ELECTRICAL CONNECTIONS.
- The showmobile connection. Provide (1) 20A, 220V RECEPTACLE IN A NEMA 3R ENCLOSURE ON A PEDESTAL. SEAL CONDUIT OPENINGS. PROVIDE NEW FEEDER BURIED 24" BELOW GRADE FROM RECEPTACLE TO PANEL XXX. PROVIDE A 3" RIGID STEEL SLEEVE WHERE PVC CONDUIT PASSES BELOW DRIVEWAY OR PARKING AREAS. EC TO PROVIDE A 10'-0" DRIVEN GROUND ROD AND #6 GROUNDING CONDUCTOR AND MAKE CONNECTIONS AT PANEL.COORDINATE WITH OWNER FOR FINAL LOCATION, AMPERAGE, AND RECEPTACLE CONFIGURATION.
- POPCORN STAND. COORDINATE WITH THE OWNER FOR THE FINAL LOCATION AND POWER REQUIREMENTS OF EXISTING POPCORN STAND AND PROVIDE A RECEPTACLE CONFIGURATION AS REQUIRED IN THIS VENDOR PEDESTAL.
- 9 SITE ELECTRICAL CONNECTION CABINET. PROVIDE A 800A, 220V FEED TO CABINET. ROUTE ALL POWER AND LIGHTING CIRCUITS WITHIN THE DOTTED LINE TO THIS CABINET.
- (10) ELECTRICAL CONNECTION CABINET PROVIDE 600A 220V FEED TO CABINET. ROUTE ALL POWER AND LIGHTING CIRCUITS WITHIN DOTTED LINE TO THIS CABINET.
- ELECTRICAL CONNECTION CABINET PROVIDE 400A 220V FEED TO CABINET. ROUTE ALL POWER AND LIGHTING CIRCUITS WITHIN DOTTED LINE TO THIS CABINET.

Northfield

Minnesota

CITY OF NORTHFIELD

801 WASHINGTON STREET
NORTHFIELD, MINNESOTA 55057
DAVID.BENNETT@CI.NORTHFIELD.MN.US

DAMON FARBER LANDSCAPE ARCHITECTS 310 S 4TH AVE

MINNEAPOLIS, MN 55415 RBLASEG@DAMONFARBER.COM 612.332.7522

BOLTON & MENK

7575 GOLDEN VALLEY ROAD SUITE 200 MINNEAPOLIS, MN 55427 DAVE.REY@BOLTON-MENK.COM 763.544.7129

NELSON-RUDIE & ASSOCIATES, 9100 49TH AVE N, MINNEAPOLIS, MN 55428

MINNEAPOLIS, MN 55428 SARAH.GREFF@NELSONRUDIE.COM 763.367.7600

SCHULER & SHOOK 219 SE MAIN ST

MINNEAPOLIS, MN 55414 PWHITAKER@SCHULERSHOOK.COM 612.339.5958

60% PRICING SET

NORTHFIELD BRIDGE SQUARE

NORTHFIELD, MN

I hereby certify that this document was prepared by me or under my direct supervision and that I am a duly licensed Professional Engineer under the laws of the

State of Minnesota.

Name		
Registration#		

 Signature
 Date


 09/14/2023

 DF/ Project #
 23-009

AS SHOWN


SJG/JAP

Drawn/Checked

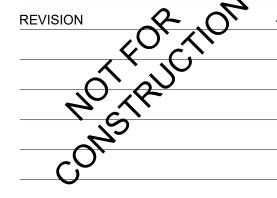


ELECTRICAL SITE PLAN


E100

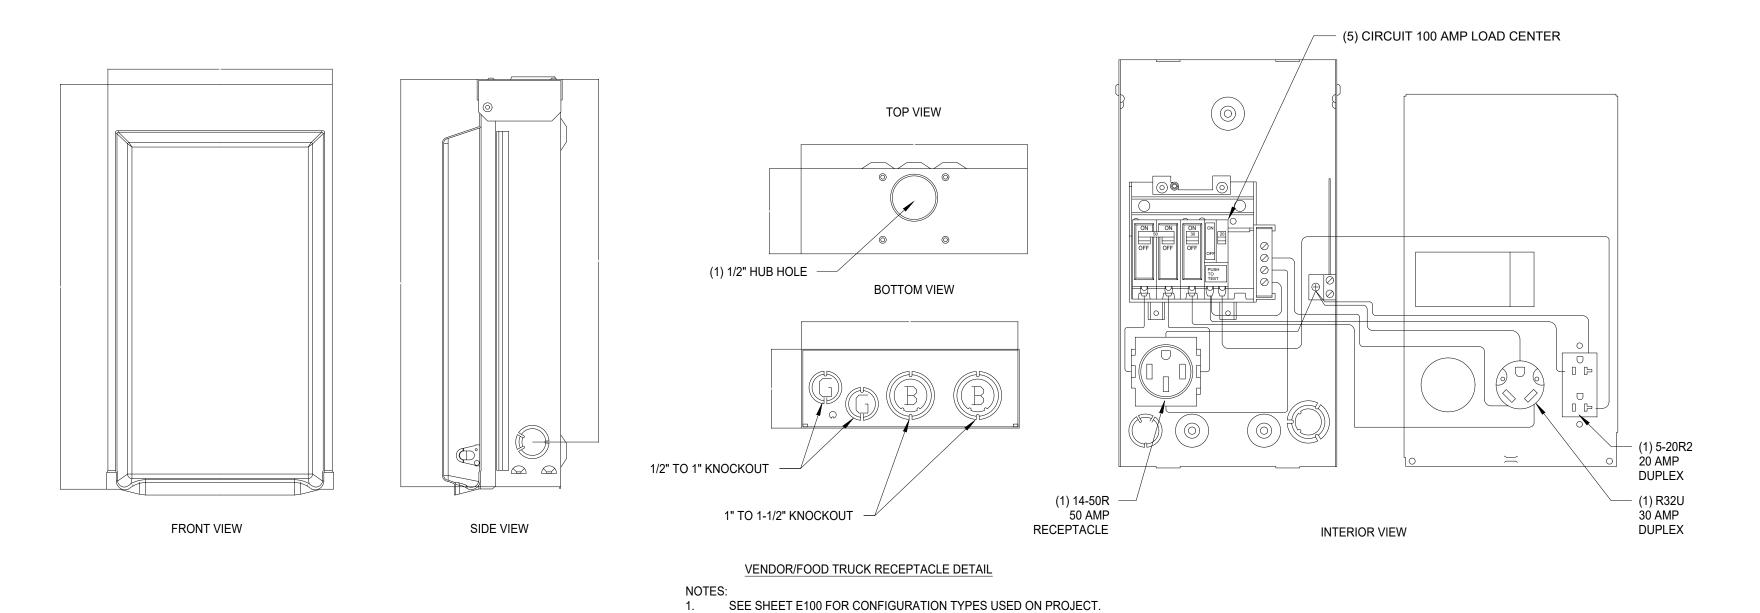


1 VENDOR/FOOD TRUCK RECEPTACLE DETAIL

NOT TO SO

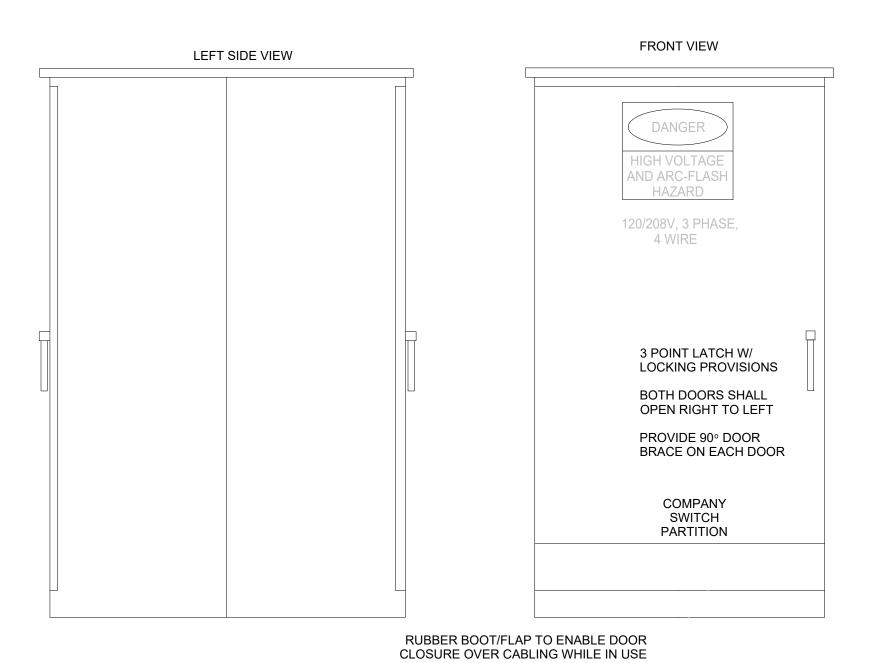

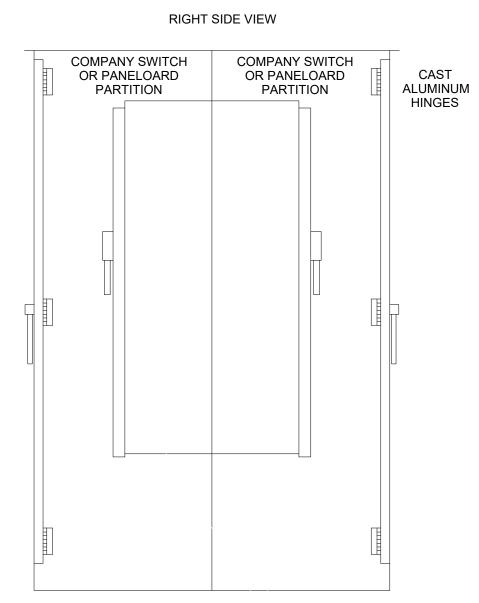

COMPANY SWITCH

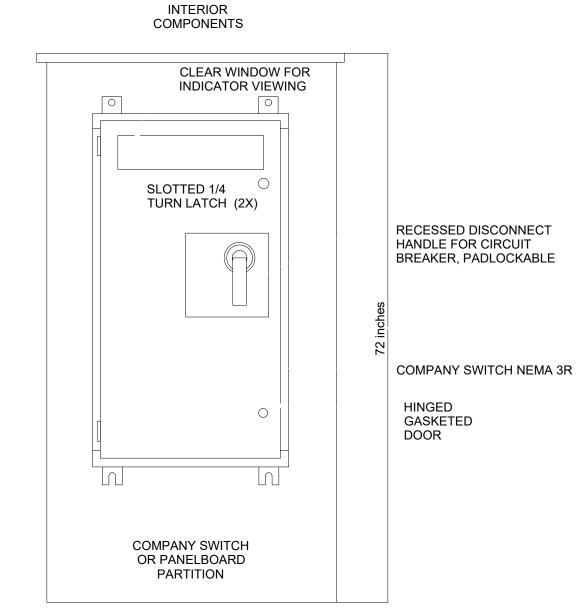

30 inches 28 inches

BASE LAYOUT NOT TO SCALE APPROXIMATE DIMENSIONS

CABINET NOTES:

- PROVIDE 200AMP ESL COMPANY SWITCH WITH TERMINALS FOR 500 KCMIL CABLE AS INDICATED ON E100
- PROVIDE CORD OPENING WITH RUBBER GASKET FOR TEMPORARY SOUND EQUIPMENT CABLING PROVIDE A 25-OHM GROUND AT CABINET AS PER NEC


2 COMPANY SWITCH DETAIL

NOT TO SCALE

- CABINET SHALL BE MANUFACTURED BY POVOLNY SPECIALTIES INC.
 REFER TO SHEET E100 FOR PANEL LOCATIONS AND CONFIGURATIONS PROVIDE PANELBOARDS AS INDICATED ON SHEET E100

CABINET CONSTRUCTION

- INTERIOR COMPONENETS MOUNTED ON BACK PANEL
- 1/8" ANODIZED ALUMINUM DARK DURANODIC BLACK NEOPRENE GASKETED DOORS
- RUBBER BOOT AT BOTTOM OF DOOR TO ENABLE DOOR CLOSURE OVER CABINET WHILE NOT IN
- STAINLESS STEEL HARDWAREETL LISTED IN ACCORDANCE WITH UL508A

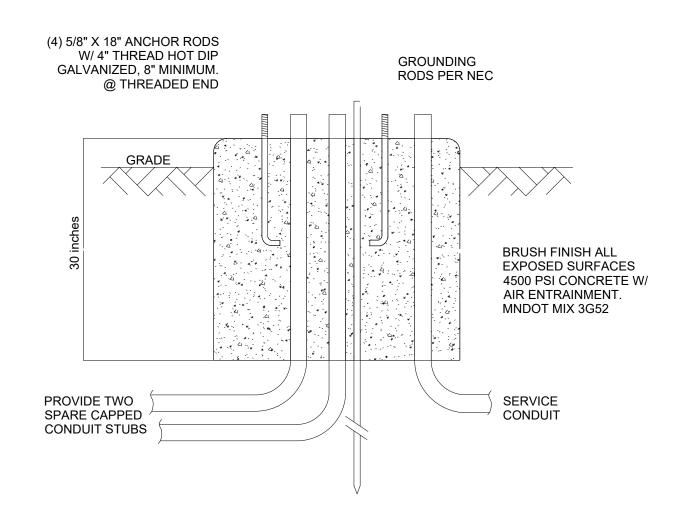

CITY OF NORTHFIELD

Minnesota

801 WASHINGTON STREET NORTHFIELD, MINNESOTA 55057 DAVID.BENNETT@CI.NORTHFIELD.MN.US

DAMON FARBER LANDSCAPE **ARCHITECTS** 310 S 4TH AVE MINNEAPOLIS, MN 55415

RBLASEG@DAMONFARBER.COM 612.332.7522 **BOLTON & MENK**

7575 GOLDEN VALLEY ROAD SUITE 200 MINNEAPOLIS, MN 55427 DAVE.REY@BOLTON-MENK.COM 763.544.7129

> **NELSON-RUDIE & ASSOCIATES,** 9100 49TH AVE N, MINNEAPOLIS, MN 55428 SARAH.GREFF@NELSONRUDIE.COM

763.367.7600 **SCHULER & SHOOK**

219 SE MAIN ST MINNEAPOLIS, MN 55414 PWHITAKER@SCHULERSHOOK.COM 612.339.5958

60% PRICING SET


NORTHFIELD BRIDGE SQUARE

NORTHFIELD, MN

I hereby certify that this document was prepared by me or under my direct supervision and that I am a duly licensed Professional Engineer under the laws of the State of Minnesota.

Registration#	
Signature	Γ
	09/14/2
DF/ Project #	23-0
Scale	AS SHO
Drawn/Checked	SJG/
REVISION	2 04

ELECTRICAL DETAILS

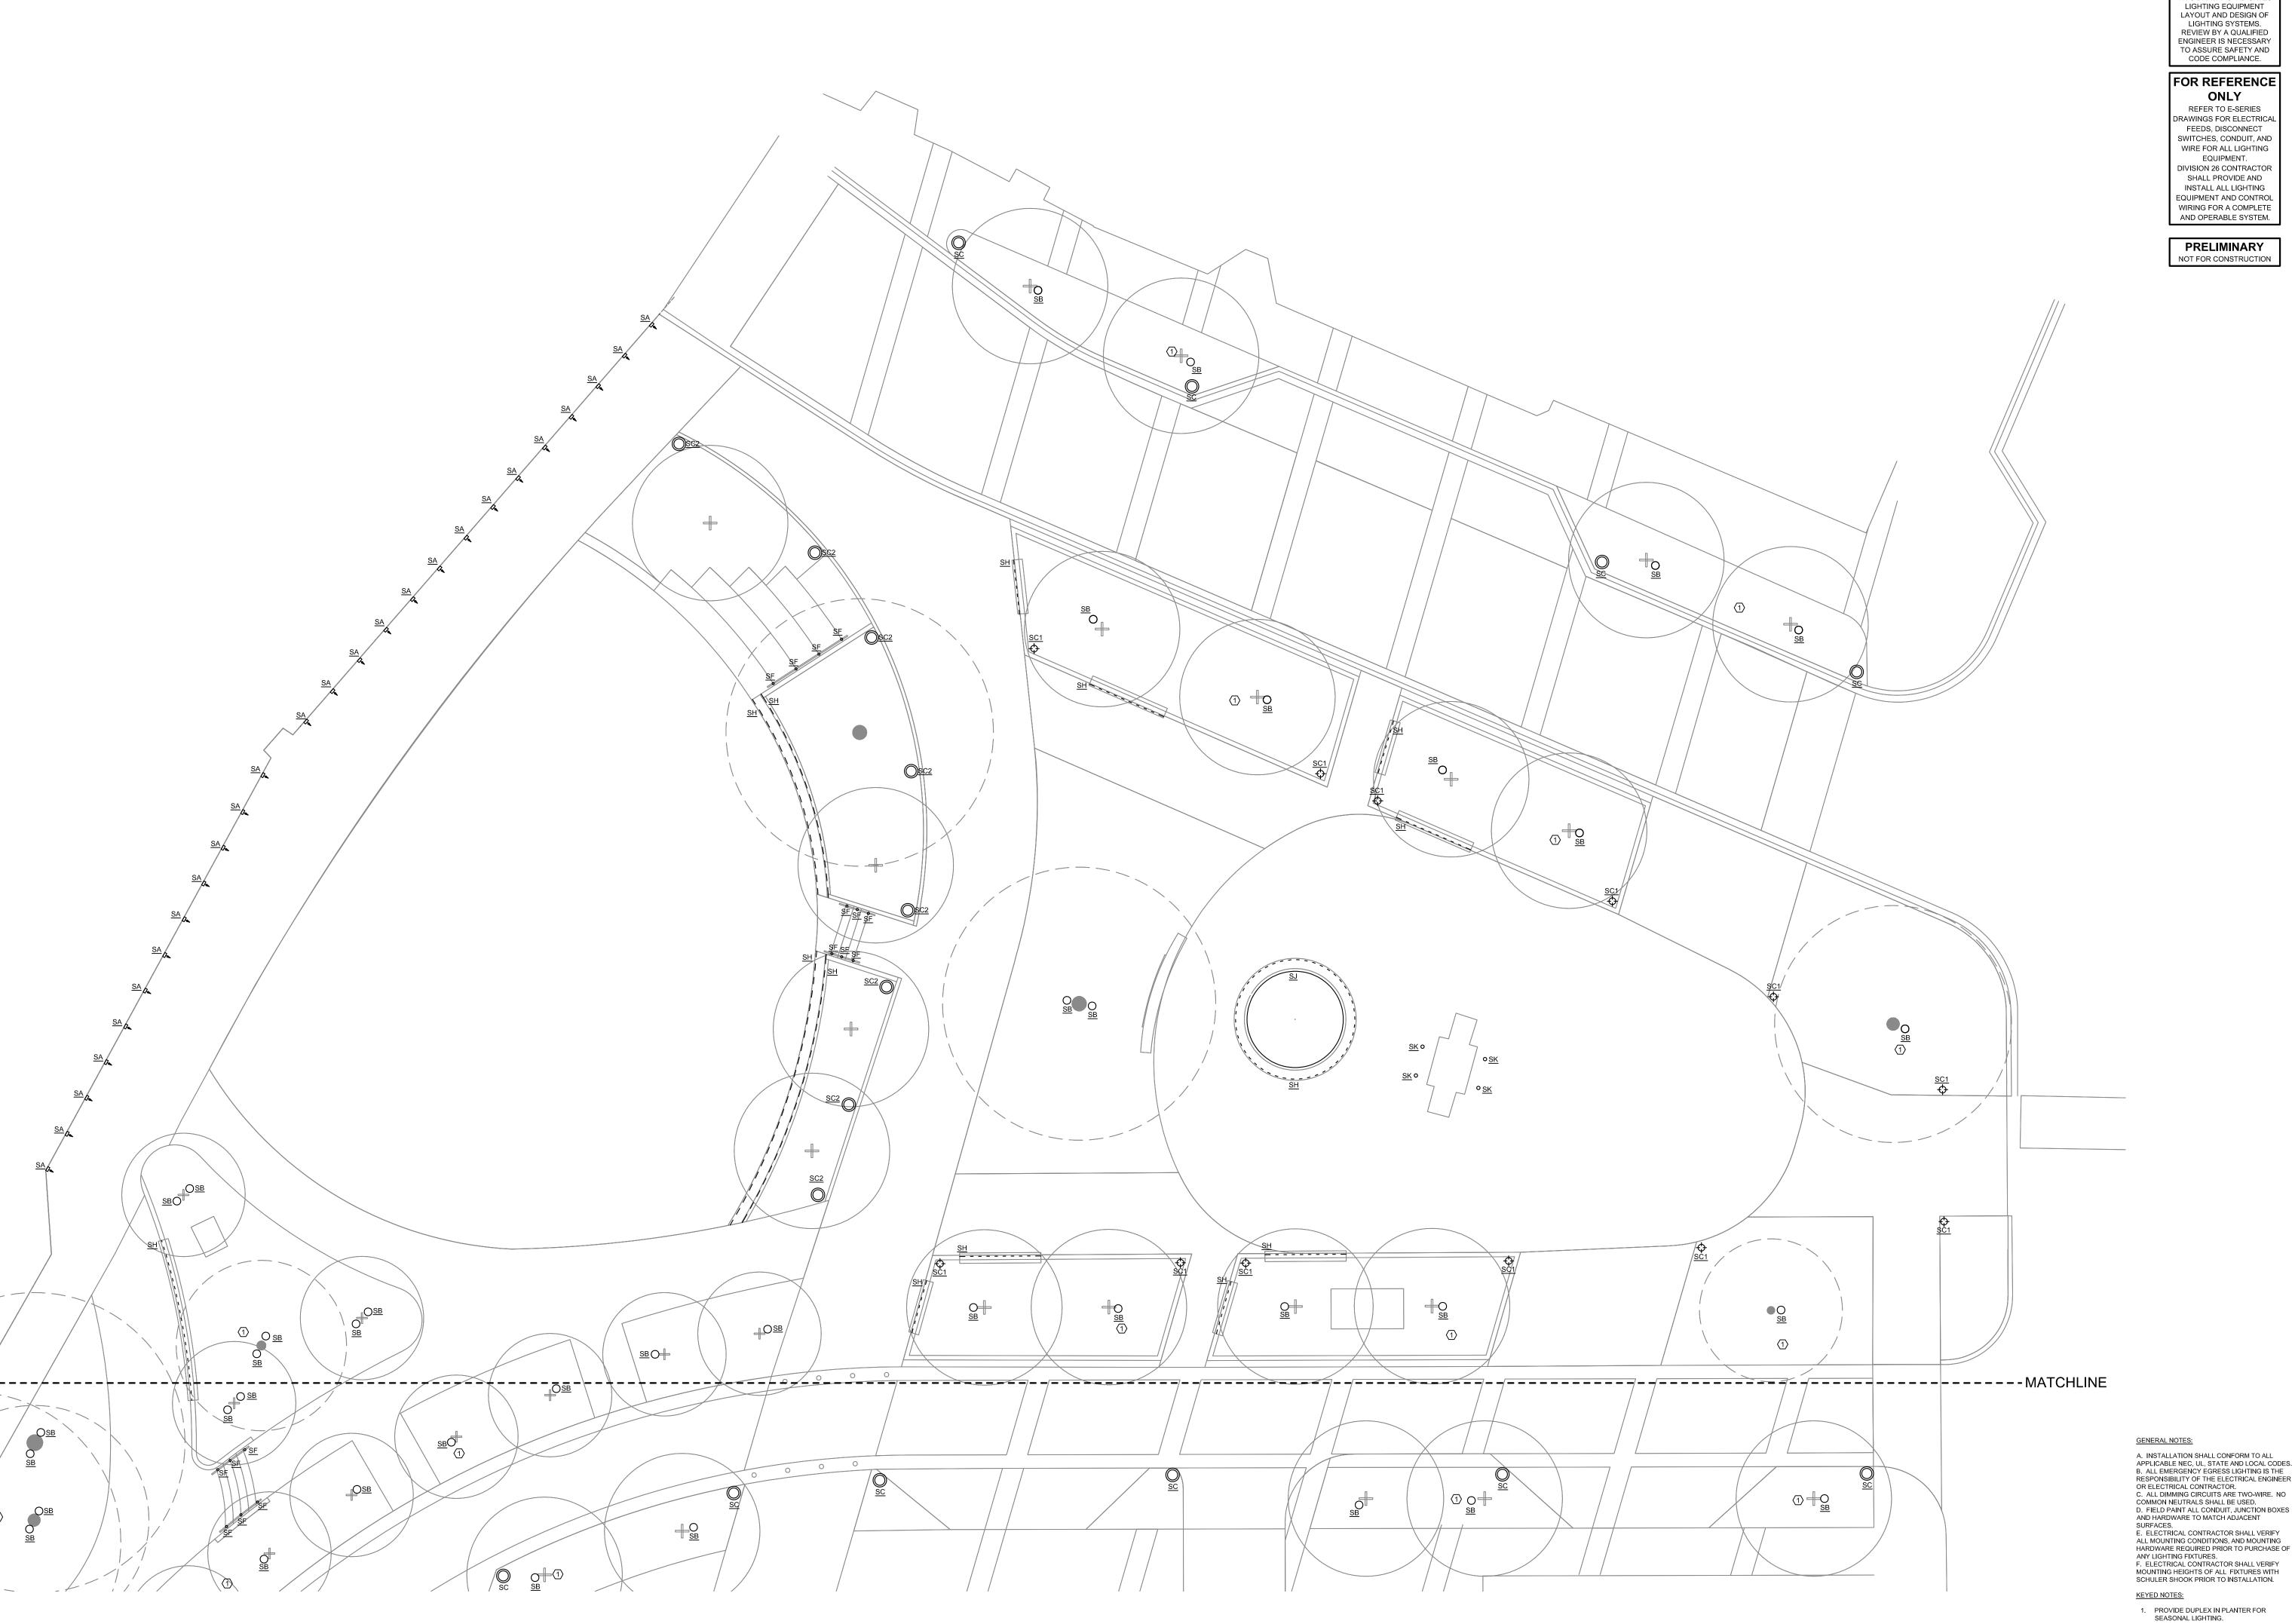

1 SITE LIGHTING - LIGHTING LAYOUT

AL100 SCALE: 3/32" = 1'-0"

THIS DRAWING INDICATES LIGHTING EQUIPMENT LAYOUT AND DESIGN OF LIGHTING SYSTEMS. REVIEW BY A QUALIFIED ENGINEER IS NECESSARY TO ASSURE SAFETY AND CODE COMPLIANCE.

FOR REFERENCE ONLY

REFER TO E-SERIES DRAWINGS FOR ELECTRICAL FEEDS, DISCONNECT SWITCHES, CONDUIT, AND WIRE FOR ALL LIGHTING EQUIPMENT. DIVISION 26 CONTRACTOR SHALL PROVIDE AND INSTALL ALL LIGHTING EQUIPMENT AND CONTROL WIRING FOR A COMPLETE AND OPERABLE SYSTEM.

PRELIMINARY

NOT FOR CONSTRUCTION

CITY OF NORTHFIELD 801 WASHINGTON STREET NORTHFIELD, MINNESOTA 55057 DAVID.BENNETT@CI.NORTHFIELD.MN.US

Minnesota

DAMON FARBER LANDSCAPE **ARCHITECTS**

310 S 4TH AVE MINNEAPOLIS, MN 55415 RBLASEG@DAMONFARBER.COM 612.332.7522

BOLTON & MENK 7575 GOLDEN VALLEY ROAD SUITE 200 MINNEAPOLIS, MN 55427 DAVE.REY@BOLTON-MENK.COM 763.544.7129

NELSON-RUDIE & ASSOCIATES, 9100 49TH AVE N, MINNEAPOLIS, MN 55428 SARAH.GREFF@NELSONRUDIE.COM 763.367.7600

SCHULER & SHOOK

219 SE MAIN ST MINNEAPOLIS, MN 55414 PWHITAKER@SCHULERSHOOK.COM 612.339.5958

60% PRICING SET


NORTHFIELD BRIDGE SQUARE

NORTHFIELD, MN


I hereby certify that this document was prepared by me or under my direct supervision and that I am a duly licensed Landscape Architect under the laws of the State of Minnesota.

Rachel Blaseg

Registration# Date 09/14/2023 22-184 DF/ Project # AS SHOWN

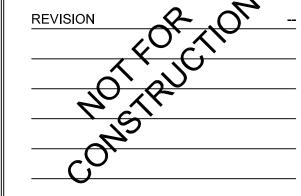

Drawn/Checked

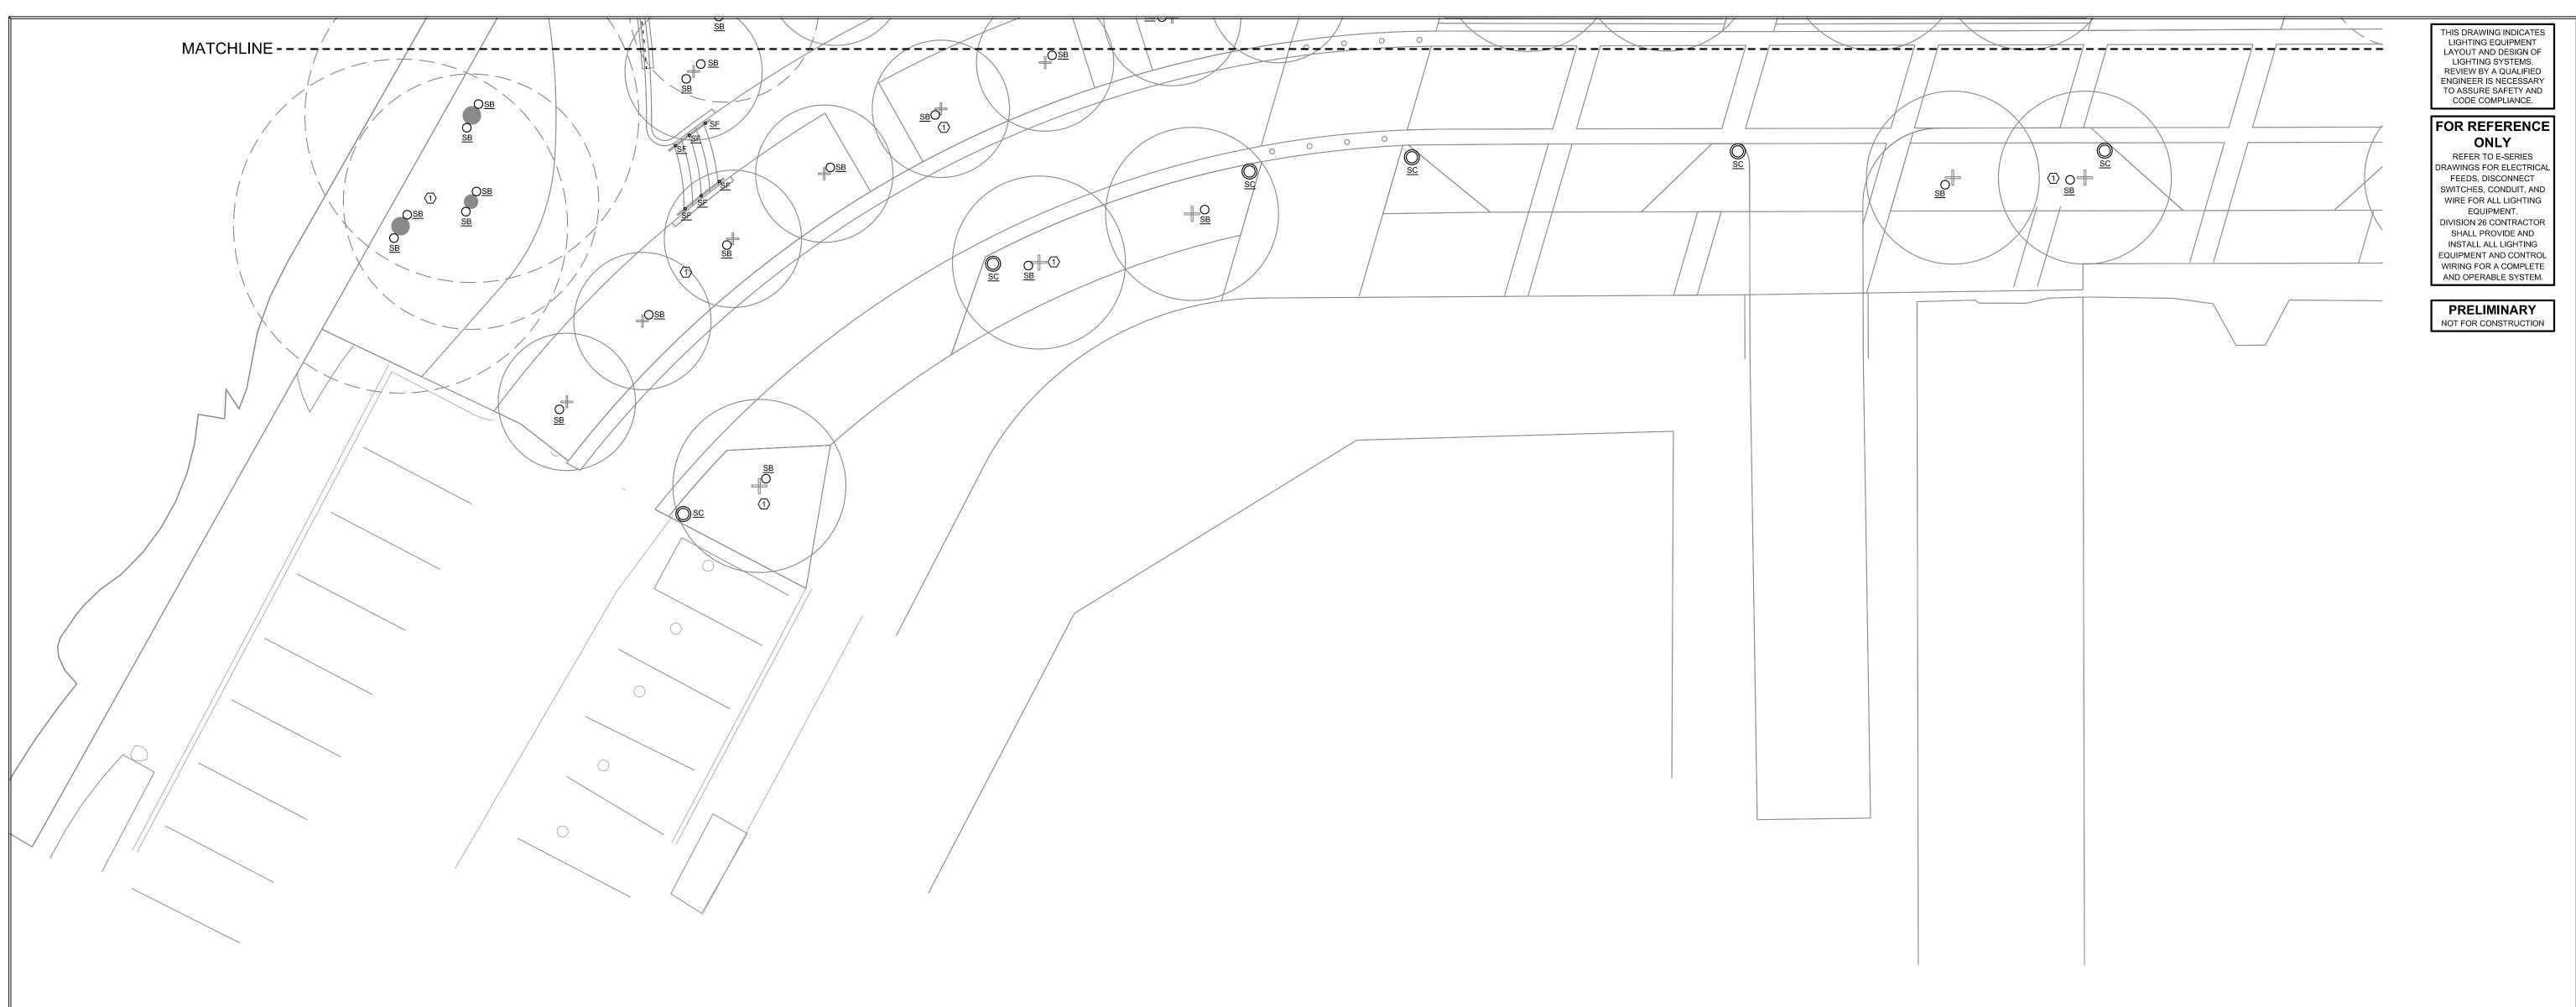



1 SITE LIGHTING - LIGHTING LAYOUT

TYPE	REV	FIXTURE DESCRIPTION	CATALOG NUMBER	VOLTS	WATTS	CONTROL TYPE	DIMMING RANGE	DRIVER REMARKS	SOURCE	DELIVERED LUMENS	ССТ	CRI	DISTRIBUTION	FIXTURE REMARKS
SA		BOLLARD	BEGA 77221 K3 BLK	240	7.8	NON-DIM			LED	643	3000	>90		BOLLARD
SA OPTION 2		BOLLARD	LOUIS POULSEN FLINDT BOLLARD 43.3- NATURAL PAINT ALUMINUM-POST W/ BASE PLATE - LED 3000K-784-120	240	15	NON-DIM			LED	591	3000	>80		BOLLARD
SB		TREE MOUNTED FLOODLIGHT	(2) BK LIGHTING DE-LED-x68-FL-BLP-12-11-45 / B-TS-TMC-BLP-19 / RM-D27INC-BLP-MT	240	27	NON-DIM			LED	1597	3000	>90		TREE MOONLIGHT
sc		CITY STANDARD STREET POLE	CITY STANDARD STREET POLE	240					LED	6730	3000	>80		STREET POLES
SC1		POLE WITH MULLTIPLE HEADS	SELUX OLPL-F40-SB5-2G350-30-BK-240-DS-0G- 0S-0M-1G-1S-0-AT535-156-16-BK-RN5-BC3-REC2	240	70	NON-DIM			LED	6730	3000	>80		PLAZA POLES
SC2		DECORATIVE POLE	DECORATIVE POLE TBD											COLONADE POLE
SD		COLUMN DOWNLIGHT	BK LIGHTING AR-LED-RM-x53-SP-WHP-9-11-90-3"- WM / RM-INC-WHP-MT. Contractor is responsible for remote power suppy, feeds, and fittings as required for a complete and operable system.	240	10	NON-DIM			LED	1230	3000	>80		PERGOLA COLUMN DOWNLIGHT
SE SF		NOT USED INTEGRAL HANDRAIL	ALPHABET: 750S 27K VA IP68 CF. PROVIDE P70414 500 ECO DRIVERS AS REQUIRED.	240	2.2W	NON-DIM			LED	180	3000			INTEGRAL HANDRAIL LIGHT
SG SH SI		LINEAR SURFACE MOUNT LED NOT USED	LUMINII KBX-SF-H-30K-IEPF-IPEF-X'-XX". MOUNT POWER SUPPLY UNDER BENCH. POWER SUPPLY LOCATION TBD AT FOUNTAIN	240	5W/FT	NON-DIM			LED	335 LM/FT	3000			BENCH AND OUTER FOUNTAIN LED
SJ		SUBMERSIBLE LINEAR	LUMINII KBL-SF-V-PL-30K-SBPF-SBPF-X'-XX". MOUNT POWER SUPPLY UNDER BENCH. POWER SUPPLY LOCATION TBD	240	3.7W/FT	NON-DIM			LED	178	3000			FOUNTAIN SUBMERSIBLE LINEAR
SK		INGRADE UPLIGHT	BK LIGHTING HP2-LED-TR-X44-FL-XXX-10-11-TC-GS	240	34	NON-DIM			LED	2814	3000	>80		MONUMENT UPLIGHT

GENERAL NOTES:

- A CONTRACTOR SHALL VERIFYALL MOUNTING AND RECESS CONDITIONS PRIOR TO ORDERING FIXTURES B - CONTRACTOR SHALL PROVIDE ALL HARDWARE, BRACKETS, WIRING, TRANSFORMERS, REMOTE BOXES AND EQUIPMENT TO INSTALL A COMPLETE AND FUNCTIONAL SYSTEM
- C NO SUBSTITUTIONS SHALL BE ACCEPTED WITHOUT PRIOR REVIEW AND WRITTEN APPROVAL BY SCHULER SHOOK
- D LIGHT FIXTURE MANUFACTURERS AND ELECTRICAL CONTRACTORS TO VERIFY COMPATIBILITY OF ALL DIMMING TRANSFORMERS, DRIVERS AND BALLASTS WITH THE LIGHTING CONTROL SYSTEM.
- E PRICES SHOWN ARE DISTRIBUTOR NET PRICING AND DO NOT INCLUDE TAXES, FREIGHT, MARK-UP (DISTRIBUTOR OR CONTRACTOR) OR INSTALLATION COST. PRICES ARE PER FIXTURE OR LINEAR FOOT.
- F PRIOR TO ORDERING LUMINAIRES, CONTRACTORS SHALL VERIFY THE COMPATIBILITY OF ALL LED DRIVERS WITH THE CONTROLS BEING ORDERED. WHERE DIMMING IS REQUIRED, CONTROL DEVISES SHALL BE COMPATIBLE TO ACCESS THE FULL DIMMING CAPABILITY OF THE SPECIFIED LED FIXTURE AND DRIVER COMBINATION, WITH NO VISIBLE FLICKER OR STEPPING (CLARIFY STEPPING). FAILURE TO COORDINATE DIMMERS AND DRIVERS THAT RESULT IN POOR DIMMING PERFORMANCE, AS DETERMINED BY THE LIGHTING DESIGNER AND/OR OWNER OR ELECTRICAL ENGINEER, SHALL BE RECTIFIED BY THE CONTRACTOR AT NO COST TO THE OWNER.
- G CONTRACTOR WILL FAMILIARIZE THEMSELVES WITH ADDRESSING OF LED FIXTURES AT BEGINNING OF PROJECT, PRIOR TO INSTALLATION. CONTRACTOR SHALL PROVIDE A SYSTEMS INTEGRATOR FOR ALL DIMMING SYSTEM.

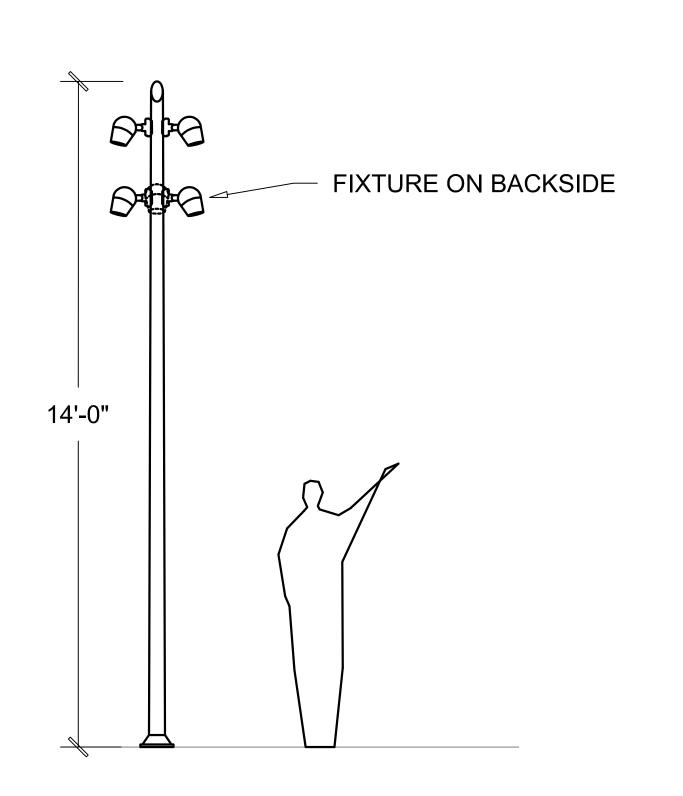

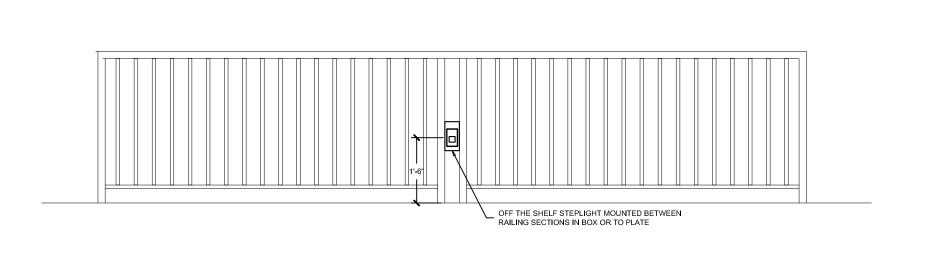

4 SITE LIGHTING - TYPE SA FIXTURE ELEVATION
SCALE: NO SCALE

GENERAL NOTES:

A. INSTALLATION SHALL CONFORM TO ALL APPLICABLE NEC, UL, STATE AND LOCAL CODES. B. ALL EMERGENCY EGRESS LIGHTING IS THE RESPONSIBILITY OF THE ELECTRICAL ENGINEER OR ELECTRICAL CONTRACTOR. OR ELECTRICAL CONTRACTOR.
C. ALL DIMMING CIRCUITS ARE TWO-WIRE. NO COMMON NEUTRALS SHALL BE USED.
D. FIELD PAINT ALL CONDUIT, JUNCTION BOXES AND HARDWARE TO MATCH ADJACENT SURFACES.
E. ELECTRICAL CONTRACTOR SHALL VERIFY ALL MOUNTING CONDITIONS, AND MOUNTING HARDWARE REQUIRED PRIOR TO PURCHASE OF ANY LIGHTING FIXTURES.
F. ELECTRICAL CONTRACTOR SHALL VERIFY MOUNTING HEIGHTS OF ALL FIXTURES WITH SCHULER SHOOK PRIOR TO INSTALLATION.

KEYED NOTES: 1. PROVIDE DUPLEX IN PLANTER FOR

SEASONAL LIGHTING.

3 SITE LIGHTING - TYPE SC1 FIXTURE ELEVATION



CITY OF NORTHFIELD 801 WASHINGTON STREET

NORTHFIELD, MINNESOTA 55057 DAVID.BENNETT@CI.NORTHFIELD.MN.US

DAMON FARBER LANDSCAPE **ARCHITECTS** 310 S 4TH AVE MINNEAPOLIS, MN 55415

RBLASEG@DAMONFARBER.COM 612.332.7522 **BOLTON & MENK**

7575 GOLDEN VALLEY ROAD SUITE 200 MINNEAPOLIS, MN 55427 DAVE.REY@BOLTON-MENK.COM 763.544.7129

763.367.7600

NELSON-RUDIE & ASSOCIATES, 9100 49TH AVE N, MINNEAPOLIS, MN 55428 SARAH.GREFF@NELSONRUDIE.COM

SCHULER & SHOOK 219 SE MAIN ST MINNEAPOLIS, MN 55414 PWHITAKER@SCHULERSHOOK.COM 612.339.5958

60% PRICING SET

NORTHFIELD BRIDGE SQUARE

NORTHFIELD, MN


prepared by me or under my direct supervision and that I am a duly licensed Landscape Architect under the laws of the State of Minnesota.

Rachel Blaseg

I hereby certify that this document was

Registration# Signature Date 09/14/2023 22-184 DF/ Project # AS SHOWN ATP/PPW

Drawn/Checked

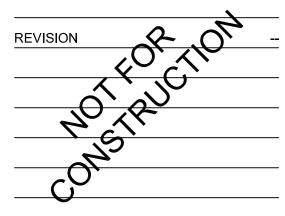

2 SITE LIGHTING - LIGHT FIXTURE SCHEDULE AL101 SCALE: NO SCALE

AL101 SCALE: NO SCALE