

SUBSURFACE UTILITY INFORMATION

THE SUBSURFACE UTILITY INFORMATION SHOWN ON THE DRAWINGS CONCERNING TYPE AND LOCATION OF UTILITIES HAS BEEN DESIGNATED UTILITY QUALITY LEVEL 'C'. THESE QUALITY LEVELS WERE DETERMINED ACCORDING TO THE GUIDELINES OF CI/ASCE 38-02. ENTITLED "STANDARD GUIDELINES FOR THE COLLECTION AND DEPICTION OF EXISTING SUBSURFACE UTILITY DATA".

— PROJECT CONTACTS =

DEVELOPER TRENT SOBERG **POST BRANDS** 701 W. 5TH STREET NORTHFIELD, MN 55057 TEL: 507-645-6681 EXT. 4302 TEL: 612-269-4221 (C)

CITY SUBMITTAL **2025 SURFACE LOT REPLACEMENT** FOR **POST BRANDS - LOT AMES MILLS** NORTHFIELD, MINNESOTA

	Sheet List Table
Sheet Number	Sheet Title
C000	COVER SHEET
C001	CONSTRUCTION NOTES
C100	EXISTING CONDITIONS
C101	REMOVALS
C200	EROSION & SEDIMENT CONTROL
C201	EROSION & SEDIMENT CONTROL DETAILS
C300	SITE PLAN
C400	GRADING PLAN
C900	CONSTRUCTION DETAILS
S1.0	TUNNEL REMOVAL AND WALL REPAIR PLAN
S2.0	DETAILS AND GENERAL STRUCTURAL NOTES

CIVIL ENGINEER KATHY MELODY, PE SOLUTION BLUE, INC. 6110 BLUE CIRCLE DRIVE SUITE 230 MINNETONKA, MN 55343 TEL: 651-294-0038 (O) TEL: 651-235-5154 (C)

SURVEYOR W. BROWN LAND SURVEYING. INC. 8030 OLD CEDAR AVENUE S. SUITE 228 BLOOMINGTON, MN 55425 TEL: 952-854-4055

CONTRACTOR LUKE CAPISTRANT LOEFFLER CONTRACTING & CONSULTING 9202 202ND ST W LAKEVILLE, MN 55044 TEL: 612-400-3750

STRUCTURAL PAUL DIETER, PE **TEKTON ENGINEERS** 105 EAST 4TH STREET SUITE 200 NORTHFIELD, MN 55057 TEL: 952-300-3340



LOEFFLER CONSTRUCTION AND CONSULTING LAKEVILLE, MN

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Kathryn K Relody	
KATH CLODY, PE	
DATE: 2/14/2025 REG. NO. 21770	

COVER SHEET

SOLUTION BLUE PROJECT NO: 240602



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BENCHMARK(S) ((BMs)

BENCHMARK #1: T.N.H. = 911.13 BENCHMARK #2: T.N.H. = 910.87

FAILS

CTURAL NOTES

REPAIR PLAN

GENERAL NOTES

- 1. THE DESIGN SHOWN IS BASED ON ENGINEER'S UNDERSTANDING OF EXISTING CONDITIONS BASED UPON THE FIELD SURVEY COMPLETED BY W. BROWN. IF THE CONTRACTOR DOES NOT ACCEPT EXISTING TOPOGRAPHY AS SHOWN ON THE PLANS WITHOUT EXCEPTION, CONTRACTOR SHALL HAVE MADE, AT OWN EXPENSE, A TOPOGRAPHIC SURVEY BY A REGISTERED LAND SURVEYOR AND SUBMIT IT TO THE OWNER FOR REVIEW.
- 2. ALL CONTROL OF WATER AND EROSION AND SEDIMENT CONTROL MEASURES SHALL BE SEQUENCED, INSTALLED, AND MAINTAINED BY THE CONTRACTOR.
- 3. ALL WORK SHALL BE PERFORMED IN ACCORDANCE WITH THE STORMWATER POLLUTION PREVENTION PLAN (SWPPP) FOR THE PROJECT. SEE SWPPP PLAN AND NOTES FOR ADDITIONAL INFORMATION.
- 4. THE CONTRACTOR SHALL MINIMIZE DISTURBANCE OF TREES/SHRUBS NOT MARKED FOR REMOVAL, INCLUDING MINIMIZING DISTURBANCE OF SOILS WITHIN THE TREES' DRIPLINE ZONES. CONTRACTOR SHALL NOT STOCKPILE MATERIAL INSIDE THE TREE DRIPLINES.
- 5. NO CONCRETE OR RUBBLE SHALL BE BACKFILLED ONSITE. BURNING OF DEBRIS ON SITE SHALL NOT BE ALLOWED.

GENERAL SITE DEMOLITION AND CLEARING NOTES

- DEMOLITION NOTES ARE NOT COMPREHENSIVE. CONTRACTOR SHALL VISIT THE SITE PRIOR TO CONSTRUCTION TO OBTAIN A CLEAR UNDERSTANDING OF THE INTENDED SCOPE OF WORK.
- CONTRACTOR SHALL COORDINATE LIMITS OF REMOVALS WITH PROPOSED IMPROVEMENTS AND SHALL BE RESPONSIBLE FOR PROTECTING EXISTING SITE FEATURES (STRUCTURES, CURBS, WALKS, PAVEMENTS, UTILITIES, SIGNAGE, FENCES, ETC.) WHICH ARE TO REMAIN. REPAIR OR REPLACE, TO OWNER'S SATISFACTION, ANY DAMAGE TO EXISTING PROPERTY OR SITE FEATURES WHICH ARE TO REMAIN, AT NO ADDITIONAL COST.
- 3. COORDINATE DISRUPTION OF UTILITY SERVICES WITH THE OWNER'S PROJECT REPRESENTATIVE AND UTILITY OWNER, PUBLIC OR PRIVATE. CONTRACTOR TO PROVIDE TEMPORARY UTILITIES AS NECESSARY TO MAINTAIN BUILDING SERVICES.
- CONTRACTOR MUST PROTECT THE PUBLIC AT ALL TIMES WITH FENCING, BARRICADES, ENCLOSURES, ETC. TO THE BEST PRACTICES.
- PRIOR TO START OF ANY WORK, ALL EROSION AND SEDIMENT CONTROL PROTECTION MEASURES SHALL BE IN PLACE. SEE EROSION CONTROL PLAN OR SWPPP FOR DETAILS.
- 6. CONTRACTOR SHALL PRESERVE ALL VEGETATION NOT TO BE REMOVED BY CONSTRUCTION. CONTRACTOR SHALL BE RESPONSIBLE FOR RE-SEEDING OR SODDING AREAS DISTURBED BY CONSTRUCTION.
- 7. CLEARLY IDENTIFY AND LABEL EACH TREE THAT IS TO REMAIN PRIOR TO STARTING SITE CLEARING. CONTACT OWNER'S PROJECT REPRESENTATIVE FOR SITE INSPECTION AFTER ALL "TO REMAIN" TREES HAVE BEEN IDENTIFIED. TREES THAT ARE TO BE PROTECTED SHALL HAVE TEMPORARY FENCING PLACED AT THE DRIP LINE AROUND EACH TREE.
- 8. STOCKPILE TOPSOIL FOR REUSE ON SITE, VERIFY THE STRIPPED TOPSOIL MEETS SPECIFICATIONS FOR THE PROPOSED USE. VERIFY THE AMOUNT OF TOPSOIL NEEDED AND REMOVE EXCESS FROM SITE.
- ALL MATERIAL REMOVED SHALL BE DISPOSED OF OFF-SITE AND IN A LEGAL MANNER.
- 10. MATERIAL TO BE SALVAGED FOR REUSE BY OWNER SHALL BE REMOVED UNDAMAGED IN USABLE CONDITION. TEMPORARY PROTECTED STORAGE ON-SITE MAY BE REQUIRED.
- 11. ON-SITE BROKERAGE OF MATERIALS SALVAGED BY CONTRACTOR FROM MATERIALS TO BE REMOVED IS NOT PERMITTED WITHOUT PRIOR OWNER APPROVAL.
- 12. LOCATION AND ELEVATIONS OF IMPROVEMENTS TO BE MET SHALL BE CONFIRMED BY THE CONTRACTOR THROUGH FIELD EXPLORATIONS PRIOR TO CONSTRUCTION. CONTRACTOR SHALL REPORT TO THE ENGINEER ANY DISCREPANCIES BETWEEN THEIR MEASUREMENTS AND THESE PLANS. CONTRACTOR SHALL ALSO MAKE EXPLORATION EXCAVATIONS AND LOCATE EXISTING UNDERGROUND UTILITIES SUFFICIENTLY AHEAD OF CONSTRUCTION TO PERMIT REVISIONS TO PLANS. IF REVISIONS ARE NECESSARY BECAUSE OF ACTUAL LOCATION OF EXISTING FACILITIES, CONTRACTOR IS REQUIRED TO TAKE PRECAUTIONARY MEASURES TO PROTECT THE UTILITY LINES SHOWN AND ANY OTHER EXISTING LINES NOT OF RECORD OR NOT SHOWN ON THESE PLANS.
- 13. CONTRACTOR SHALL LIMIT SAW-CUT AND PAVEMENT REMOVAL TO ONLY THOSE AREAS WHERE IT IS REQUIRED AS SHOWN ON THESE CONSTRUCTION PLANS. IF ANY DAMAGE IS INCURRED ON ANY OF THE SURROUNDING PAVEMENT, ETC. THE CONTRACTOR SHALL BE **RESPONSIBLE FOR ITS REMOVAL AND REPAIR.**

GENERAL GEOMETRIC AND PAVING NOTES

- 1. SITE DIMENSIONS SHOWN ON THIS PLAN SHALL BE USED FOR ALL LAYOUT WORK. CHECK ALL PLAN AND DETAIL DIMENSIONS. PAVING SHALL BE LAID OUT ON SITE BY A **REGISTERED LAND SURVEYOR.**
- 2. ALL PAVING DIMENSIONS ARE TO FACE OF CURB UNLESS NOTED OTHERWISE. THE FACE OF CURB IS ASSUMED TO BE 6 INCHES FROM THE BACK OF CURB, ALL CURB & GUTTER TO BE B612 UNLESS OTHERWISE NOTED. SEE DETAIL SHEET C900.
- 3. ALL SIDEWALKS SHALL HAVE POSITIVE SLOPE AWAY FROM THE BUILDING. THE MAXIMUM CROSS SLOPE SHALL BE 2.0% AND THE MAXIMUM LONGITUDINAL SLOPE SHALL BE 5.0% UNLESS OTHERWISE SHOWN ON THE DRAWINGS.
- 4. FOR ALL PEDESTRIAN CURB RAMPS, SEE MNDOT STANDARD PLANS FOR CONSTRUCTION DETAILS. SEE GRADING PLAN SHEET C400 FOR CURB TAPERS.
- 5. DETECTABLE WARNING SHALL BE USED ON ALL ACCESSIBLE ROUTE RAMPS.
- 6. NO SLOPE IN ANY DIRECTION SHALL EXCEED 2% IN ACCESSIBLE PARKING AND LOADING AREAS.
- 7. MATCH NEW AND EXISTING PAVEMENT SURFACES, SIDEWALKS AND CURBS AT SAWCUT LINES, ALLOWING NO PONDING OF WATER AT JOINTS. PROVIDE SMOOTH GRADE TRANSITION ACROSS NEW AND EXISTING JOINTS.
- 8. ALLOW MINIMUM OF SEVEN DAYS CURE FOR CURB AND GUTTER PRIOR TO PAVING.
- 9. ALLOW MINIMUM OF 24 HOUR COOLING PRIOR TO ALLOWING TRAFFIC ON **BITUMINOUS PAVING.**
- 10. SEE DETAIL SHEET C900 FOR BITUMINOUS & CONCRETE PAVEMENT SECTION DEPTHS AND SPECIFICATIONS.
- 11. SEE ELECTRICAL PLANS BY OTHERS FOR SITE LIGHTING.

GEOTECHNICAL EXPLORATION & REVIEW

CONTRACTOR SHALL COMPLETE THE SITE GRADING IN ACCORDANCE WITH THE REQUIREMENTS OF THE OWNER'S SOILS ENGINEER. ALL SOIL TESTING SHALL BE COMPLETED BY THE OWNER'S SOILS ENGINEER. CONTRACTOR SHALL BE RESPONSIBLE FOR COORDINATING ALL REQUIRED SOIL TESTS AND INSPECTIONS WITH THE SOILS ENGINEER.

A GEOTECHNICAL ENGINEERING SOILS REPORT HAS BEEN COMPLETED BY:

COMPANY: AMERICAN ENGINEERING TESTING ADDRESS: 550 CLEVELAND AVENUE NORTH ST. PAUL, MN 55114-1804 PHONE: 800-972-6364 DATE: JULY 30, 2024

CONTRACTOR SHALL OBTAIN A COPY OF THIS REPORT.

GENERAL UTILITY NOTES

- 1. CONTRACTOR TO ADJUST ALL EXISTING AND PROPOSED CATCH BASINS AND MANHOLES TO BE FLUSH WITH FINAL GRADE.
- 2. THE CONTRACTOR SHALL CLEAN ALL SURFACE FLOW CHANNELS, PIPES AND STRUCTURES AFTER FINAL SURFACES ARE ESTABLISHED AND PRIOR TO PROJECT CLOSEOUT.

GENERAL GRADING NOTES

1. ALL EROSION AND SEDIMENTATION CONTROL MEASURES SHALL BE IN PLACE BEFORE BEGINNING SITE GRADING ACTIVITIES.

- 2. THE CONTRACTOR SHALL BE RESPONSIBLE FOR COMPLETING & SUBMITTING THE APPLICATION FOR THE MPCA GENERAL STORMWATER PERMIT FOR CONSTRUCTION ACTIVITY WHEN CONSTRUCTION ACTIVITY FOR THE PROJECT DISTURBS GREATER THAN 1 ACRE. ALL CONTRACTORS AND SUBCONTRACTORS INVOLVED WITH STORMWATER POLLUTION PREVENTION SHALL OBTAIN A COPY OF THE SWPPP AND THE STATE OF MINNESOTA NATIONAL POLLUTANT DISCHARGE ELIMINATION SYSTEM GENERAL PERMIT (NPDES PERMIT) AND BECOME FAMILIAR WITH THE CONTENTS. THE SWPPP AND ALL OTHER RELATED DOCUMENTS MUST BE KEPT AT THE SITE DURING CONSTRUCTION.
- 3. CONTRACTOR SHALL BE RESPONSIBLE FOR DETERMINING QUANTITIES OF CUT, FILL AND WASTE MATERIAL TO BE HANDLED, AND FOR THE AMOUNT OF GRADING TO BE DONE. ALL COSTS ASSOCIATED WITH IMPORTING SUITABLE MATERIAL AND EXPORTING UNSUITABLE/EXCESS/WASTE MATERIAL SHALL BE INCLUDED IN THE BID PRICE.
- 4. CONTRACTOR SHALL TAKE ALL PRECAUTIONS NECESSARY TO AVOID PROPERTY DAMAGE TO ADJACENT PROPERTIES DURING THE CONSTRUCTION PHASES OF THIS PROJECT. CONTRACTOR WILL BE HELD SOLELY RESPONSIBLE FOR ANY DAMAGES TO THE ADJACENT PROPERTIES OCCURRING DURING THE CONSTRUCTION PHASES OF THIS PROJECT.
- 5. SAFETY NOTICE TO CONTRACTORS: IN ACCORDANCE WITH GENERALLY ACCEPTED CONSTRUCTION PRACTICES, CONTRACTOR WILL BE SOLELY AND COMPLETELY RESPONSIBLE FOR CONDITIONS ON THE JOB SITE, INCLUDING SAFETY OF ALL PERSONS AND PROPERTY DURING PERFORMANCE OF THE WORK. THIS REQUIREMENT WILL APPLY CONTINUOUSLY AND NOT BE LIMITED TO NORMAL WORKING HOURS. THE DUTY OF THE ENGINEER OR THE DEVELOPER TO CONDUCT CONSTRUCTION REVIEW OF THE CONTRACTOR'S PERFORMANCE IS NOT INTENDED TO INCLUDE REVIEW OF THE ADEQUACY OF THE CONTRACTOR'S SAFETY MEASURES IN, ON OR NEAR THE CONSTRUCTION SITE.
- PRIOR TO PLACEMENT OF THE AGGREGATE BASE, A TEST ROLL SHALL BE PERFORMED ON THE PARKING AREA SUBGRADE. CONTRACTOR SHALL PROVIDE A LOADED TANDEM AXLE TRUCK WITH A GROSS WEIGHT OF 25 TONS. THE TEST ROLLING SHALL BE AT THE DIRECTION OF THE SOILS ENGINEER AND SHALL BE COMPLETED IN AREAS AS DIRECTED BY THE SOILS ENGINEER. CORRECTION OF THE SUBGRADE SOILS SHALL BE COMPLETED IN ACCORDANCE WITH THE REQUIREMENTS OF THE SOILS ENGINEER.
- REPLACE ALL SUBGRADE SOIL DISTURBED DURING CONSTRUCTION THAT HAVE BECOME UNSUITABLE AND WILL NOT PASS A TEST ROLL. REMOVE UNSUITABLE SOIL FROM THE SITE AND IMPORT SUITABLE SOIL AT NO ADDITIONAL COST TO THE OWNER.
- 8. CONTRACTOR SHALL STRIP, STOCKPILE AND RE-SPREAD EXISTING ONSITE TOPSOIL, IF MATERIAL IS APPROVED BY THE LANDSCAPE ARCHITECT AND/OR SPECIFICATIONS. PROVIDE A UNIFORM THICKNESS OF 6" MINIMUM IN ALL DISTURBED AREAS TO BE LANDSCAPED.
- 9. CONTRACTOR SHALL DISPOSE OF ANY EXCESS SOIL MATERIAL UNLESS OTHERWISE DIRECTED.
- 10. MAINTAIN TEMPORARY PROTECTION MEASURES DURING CONSTRUCTION ACTIVITIES. SEE SITE REMOVALS PLAN FOR ADDITIONAL INFORMATION. PROVIDE ADDITIONAL PROTECTION AS NECESSARY AS WORK PROGRESSES.
- 11. PROPOSED CONTOURS AND SPOT ELEVATIONS ARE TO FINISHED SURFACE GRADE.
- 12. PROVIDE POSITIVE DRAINAGE AWAY FROM BUILDINGS AT ALL TIMES.
- 13. CONTRACTOR SHALL REVIEW PAVEMENT GRADIENT AND CONSTRUCT "GUTTER OUT" WHERE WATER DRAINS AWAY FROM CURB. ALL OTHER AREAS SHALL BE CONSTRUCTED AS "GUTTER IN" CURB.
- 14. NO GRADED SLOPES SHALL EXCEED 3:1 (HORIZONTAL TO VERTICAL) UNLESS OTHERWISE NOTED
- 15. UNIFORMLY GRADED AREAS WITHIN LIMITS OF GRADING AND PROVIDE A SMOOTH FINISHED SURFACE WITH UNIFORM SLOPES BETWEEN POINTS WHERE ELEVATIONS ARE SHOWN OR BETWEEN SUCH POINTS AND EXISTING GRADES.
- 16. LIMIT THE DISTURBED AREA AS MUCH AS POSSIBLE AND CONDUCT GRADING OPERATIONS IN A MANNER TO MINIMIZE THE POTENTIAL FOR EROSION.
- 17. SEE DETAIL SHEET C201 FOR BMP CONSTRUCTION DETAILS.

GENERAL EROSION AND SEDIMENT CONTROL NOTES

- AS FEASIBLE.
- THE ROCK FROM BELOW.
- LOCATION PORTABLE FACILITIES, OFFICE TRAILERS AND TOILET FACILITIES.
- ADJACENT PROPERTIES.
- FILTER FABRIC WRAPPED GRATES ARE NOT ALLOWED FOR INLET PROTECTION.
- DRAINAGE/GUTTER LINE AND SHALL BE COVERED IF LEFT MORE THAN 24 HOURS.
- REMOVAL IS 70% ESTABLISHED COVER OVER DENUDED AREA.
- ADJUSTING THE EROSION CONTROL MEASURES TO PREVENT EROSION.
- DEVICES.
- CONSTRUCTION

1. INSTALL PERIMETER EROSION CONTROL AT THE LOCATIONS SHOWN ON THE PLANS PRIOR TO COMMENCEMENT OF ANY LAND DISTURBANCE OR CONSTRUCTION ACTIVITIES. SILT FENCE SHALL FOLLOW EXISTING CONTOURS AS CLOSELY

2. BEFORE BEGINNING CONSTRUCTION, INSTALL A TEMPORARY ROCK CONSTRUCTION ENTRANCE AT EACH POINT WHERE VEHICLES EXIT THE CONSTRUCTION SITE. USE 1.5 INCH OR GREATER DIAMETER ROCK IN A LAYER AT LEAST 6 INCHES THICK ACROSS THE ENTIRE WIDTH OF THE ENTRANCE. EXTEND THE ROCK ENTRANCE AT LEAST 50 FEET INTO THE CONSTRUCTION ZONE USING A GEO-TEXTILE FABRIC BENEATH THE AGGREGATE TO PREVENT MIGRATION OF SOIL INTO

3. GENERAL CONTRACTOR SHALL DENOTE ON PLAN THE TEMPORARY PARKING AND STORAGE AREA WHICH SHALL ALSO BE USED AS THE EQUIPMENT MAINTENANCE AND CLEANING AREA, EMPLOYEE PARKING AREA, AND AREA FOR

4. REMOVE ALL SOILS AND SEDIMENTS TRACKED OR OTHERWISE DEPOSITED ONTO PUBLIC AND PRIVATE PAVEMENT AREAS. REMOVAL SHALL BE ON A DAILY BASIS WHEN TRACKING OCCURS. SWEEPING SHALL BE MAINTAINED THROUGHOUT THE DURATION OF THE CONSTRUCTION AND DONE IN A MANNER TO PREVENT DUST BEING BLOWN TO

5. INSTALL INLET PROTECTION AT ALL PUBLIC AND PRIVATE CATCH BASIN INLETS, WHICH RECEIVE RUNOFF FROM THE DISTURBED AREAS. CONTRACTOR SHALL CLEAN, REMOVE SEDIMENT OR REPLACE STORM DRAIN INLET PROTECTION DEVICES ON A ROUTINE BASIS SUCH THAT THE DEVICES ARE FULLY FUNCTIONAL FOR THE NEXT RAIN EVENT. SEDIMENT DEPOSITED IN AND/OR PLUGGING DRAINAGE SYSTEMS IS THE RESPONSIBILITY OF THE CONTRACTOR. HAY BALES OR

6. LOCATE SOIL OR DIRT STOCKPILES NO LESS THAN 25 FEET FROM ANY PUBLIC OR PRIVATE ROADWAY OR DRAINAGE CHANNEL. IF REMAINING FOR MORE THAN 48 HOURS, STABILIZE THE STOCKPILES BY MULCHING, VEGETATIVE COVER, TARPS, OR OTHER MEANS. CONTROL EROSION FROM ALL STOCKPILES BY PLACING SILT BARRIERS AROUND THE PILES. TEMPORARY STOCKPILES LOCATED ON PAVED SURFACES MUST BE NO LESS THAN TWO FEET FROM THE

7. MAINTAIN ALL TEMPORARY EROSION AND SEDIMENT CONTROL DEVICES IN PLACE UNTIL THE CONTRIBUTING DRAINAGE AREA HAS BEEN STABILIZED. INSPECT TEMPORARY EROSION AND SEDIMENT CONTROL DEVICES ON A DAILY BASIS AND REPLACE DETERIORATED, DAMAGED, OR ROTTED EROSION CONTROL DEVICES IMMEDIATELY.

8. TEMPORARILY OR PERMANENTLY STABILIZE ALL CONSTRUCTION AREAS WHICH HAVE UNDERGONE FINAL GRADING, AND ALL AREAS IN WHICH GRADING CONSTRUCTION OPERATIONS ARE NOT ACTIVELY UNDERWAY AGAINST EROSION DUE TO RAIN, WIND AND RUNNING WATER WITHIN 7 DAYS. USE SEED AND MULCH, EROSION CONTROL MATTING, AND/OR SODDING AND STAKING IN GREEN SPACE AREAS. REMOVE ALL TEMPORARY SYNTHETIC, STRUCTURAL, NON-BIODEGRADABLE EROSION AND SEDIMENT CONTROL DEVICES AFTER THE SITE HAS UNDERGONE FINAL STABILIZATION WITH PERMANENT VEGETATION ESTABLISHMENT. FINAL STABILIZATION FOR PURPOSES OF THIS

9. READY MIXED CONCRETE AND CONCRETE BATCH/MIX PLANTS ARE PROHIBITED WITHIN THE PUBLIC RIGHT OF WAY. ALL CONCRETE RELATED PRODUCTION, CLEANING AND MIXING ACTIVITIES SHALL BE DONE IN THE DESIGNATED CONCRETE MIXING/WASHOUT LOCATIONS AS DETERMINED BY THE CONTRACTOR. UNDER NO CIRCUMSTANCES MAY WASHOUT WATER DRAIN INTO THE PUBLIC RIGHT OF WAY OR INTO ANY PUBLIC OR PRIVATE STORM DRAIN CONVEYANCE.

10. DUE TO THE GRADE CHANGES DURING THE DEVELOPMENT OF THE PROJECT, CONTRACTOR SHALL BE RESPONSIBLE FOR

11. CHANGES TO APPROVED EROSION CONTROL PLAN MUST BE APPROVED BY THE EROSION CONTROL INSPECTOR PRIOR TO IMPLEMENTATION. CONTRACTOR TO PROVIDE INSTALLATION AND DETAILS FOR ALL PROPOSED ALTERNATE TYPE

12. ALL CONSTRUCTION SHALL BE STABILIZED AT THE END OF EACH WORKING DAY, THIS INCLUDES BACKFILLING OF TRENCHES FOR UTILITY CONSTRUCTION AND PLACEMENT OF GRAVEL OR BITUMINOUS PAVING FOR ROAD



LOEFFLER CONSTRUCTION AND CONSULTING LAKEVILLE, MN



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SUMMARY

DESIGNED: KMM DRAWN: KMM REVIEWED: KMM PHASE: CITY SUB. INITIAL ISSUE: 2/14/2025

	ISSUE AND REVISION HISTORY		
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CERTIFICATION


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Kathryn M Relody	
KATHEN DELODY, P.E.	
DATE: 2/14/2025 REG. NO. 21770	

CONSTRUCTION NOTES

SOLUTION BLUE PROJECT NO: 240602

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STATE LAW: 48 HOURS BEFORE EXCAVATING OR DEMOLISHING BUILDINGS, CALL 811 FOR FIELD LOCATION OF UNDERGROUND UTILITY LINES. THIS SERVICE LOCATES UTILITY OWNED LINES BUT NOT PRIVATE LINES. THE LOCATIONS OF UNDERGROUND UTILITIES ARE SHOWN

THE LOCATIONS OF UNDERGROUND UTILITIES ARE SHOWN IN AN APPROXIMATE WAY ONLY AND HAVE NOT BEEN INDEPENDENTLY VERIFIED. THE EXACT LOCATION OF ALL UTILITIES (PUBLIC AND PRIVATE) MUST BE DETERMINED BEFORE COMMENCING WORK.

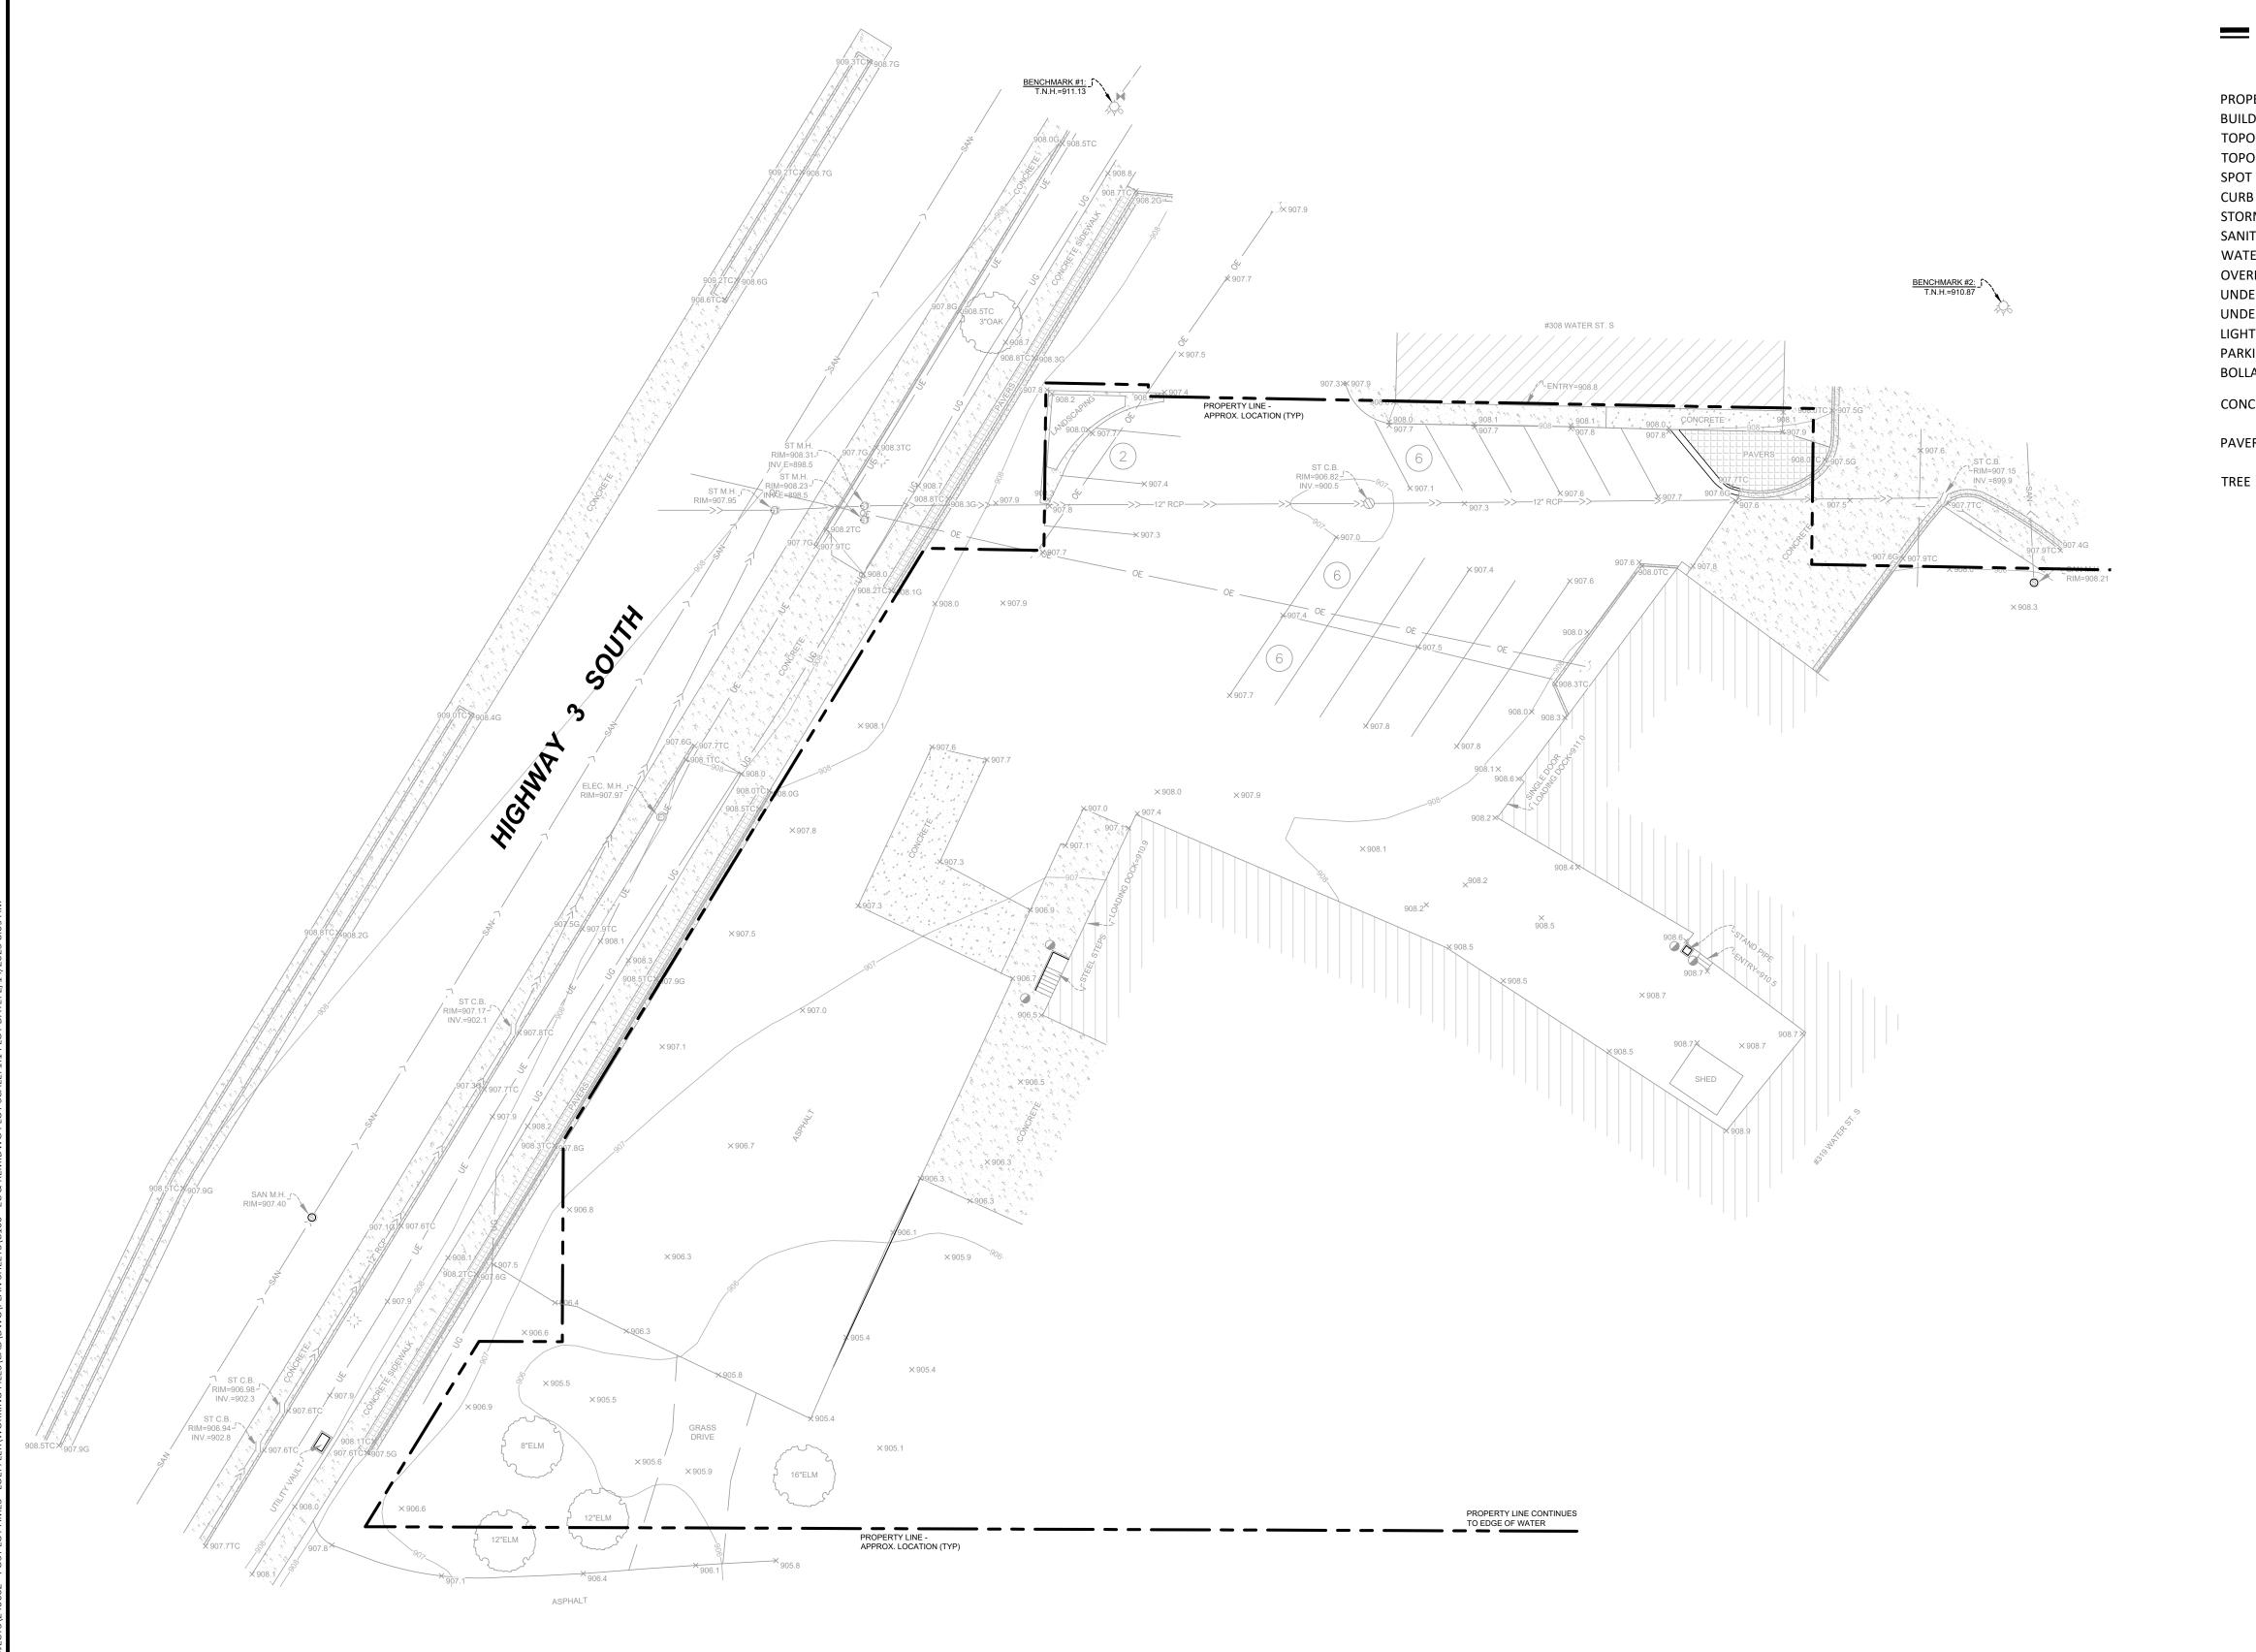
PROPERTY LINE - APPROXIMATE BUILDING TOPOGRAPHIC INDEX CONTOUR TOPOGRAPHIC CONTOUR SPOT ELEVATION CURB & GUTTER STORM SEWER SANITARY SEWER WATERMAIN	EXISTING $ \begin{array}{c} $	Solution water matters Minnetonka, MN 55343 UWWW.SolutionBlue.com LOEFFLER CONSTRUCTION AND CONSULTING LAKEVILLE, MN
OVERHEAD ELECTRIC UNDERGROUND ELECTRIC UNDERGROUND GAS LIGHT POLE PARKING STALL COUNT BOLLARDS CONCRETE PAVERS TREE		POST BRANDS - LOT AMES MILLS 319 WATER ST. SOUTH NORTHFIELD, MN 55057 PERMITTING PLANS
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BENCHMARK(S) (BMs)

BENCHMARK #1: T.N.H. = 911.13 BENCHMARK #2: T.N.H. = 910.87 C100

CONDITIONS

SOLUTION BLUE PROJECT NO: 240602

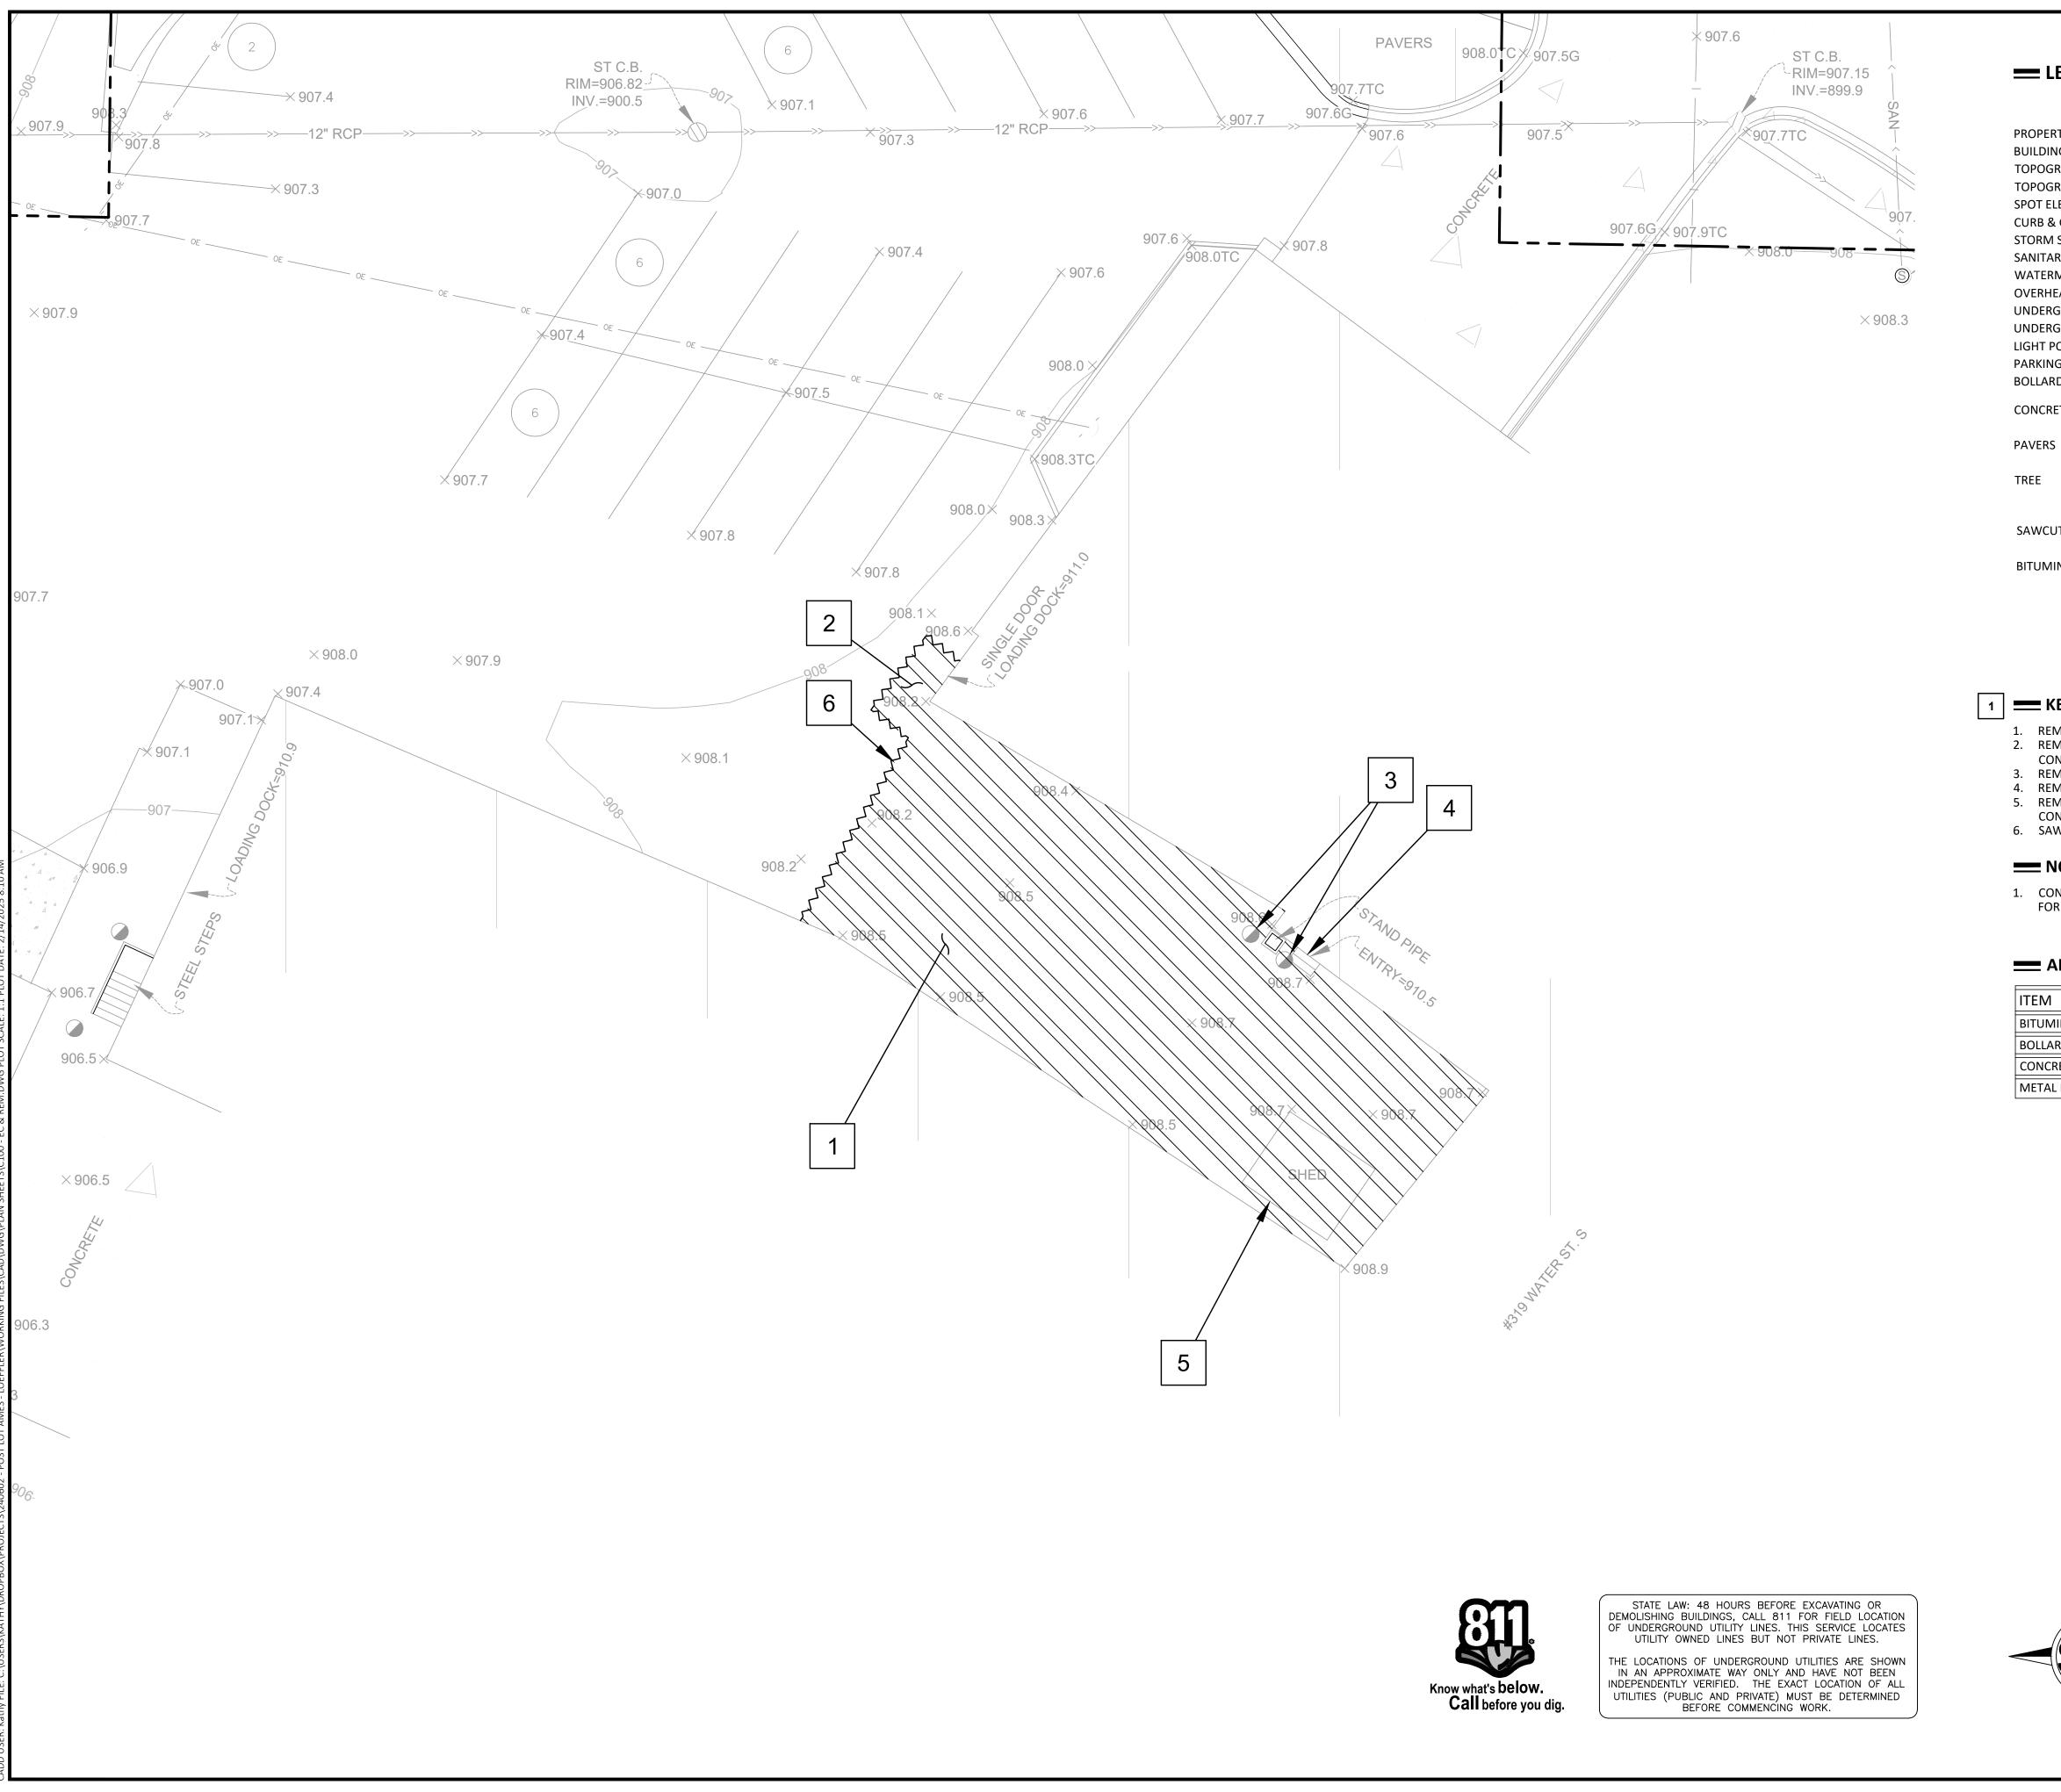

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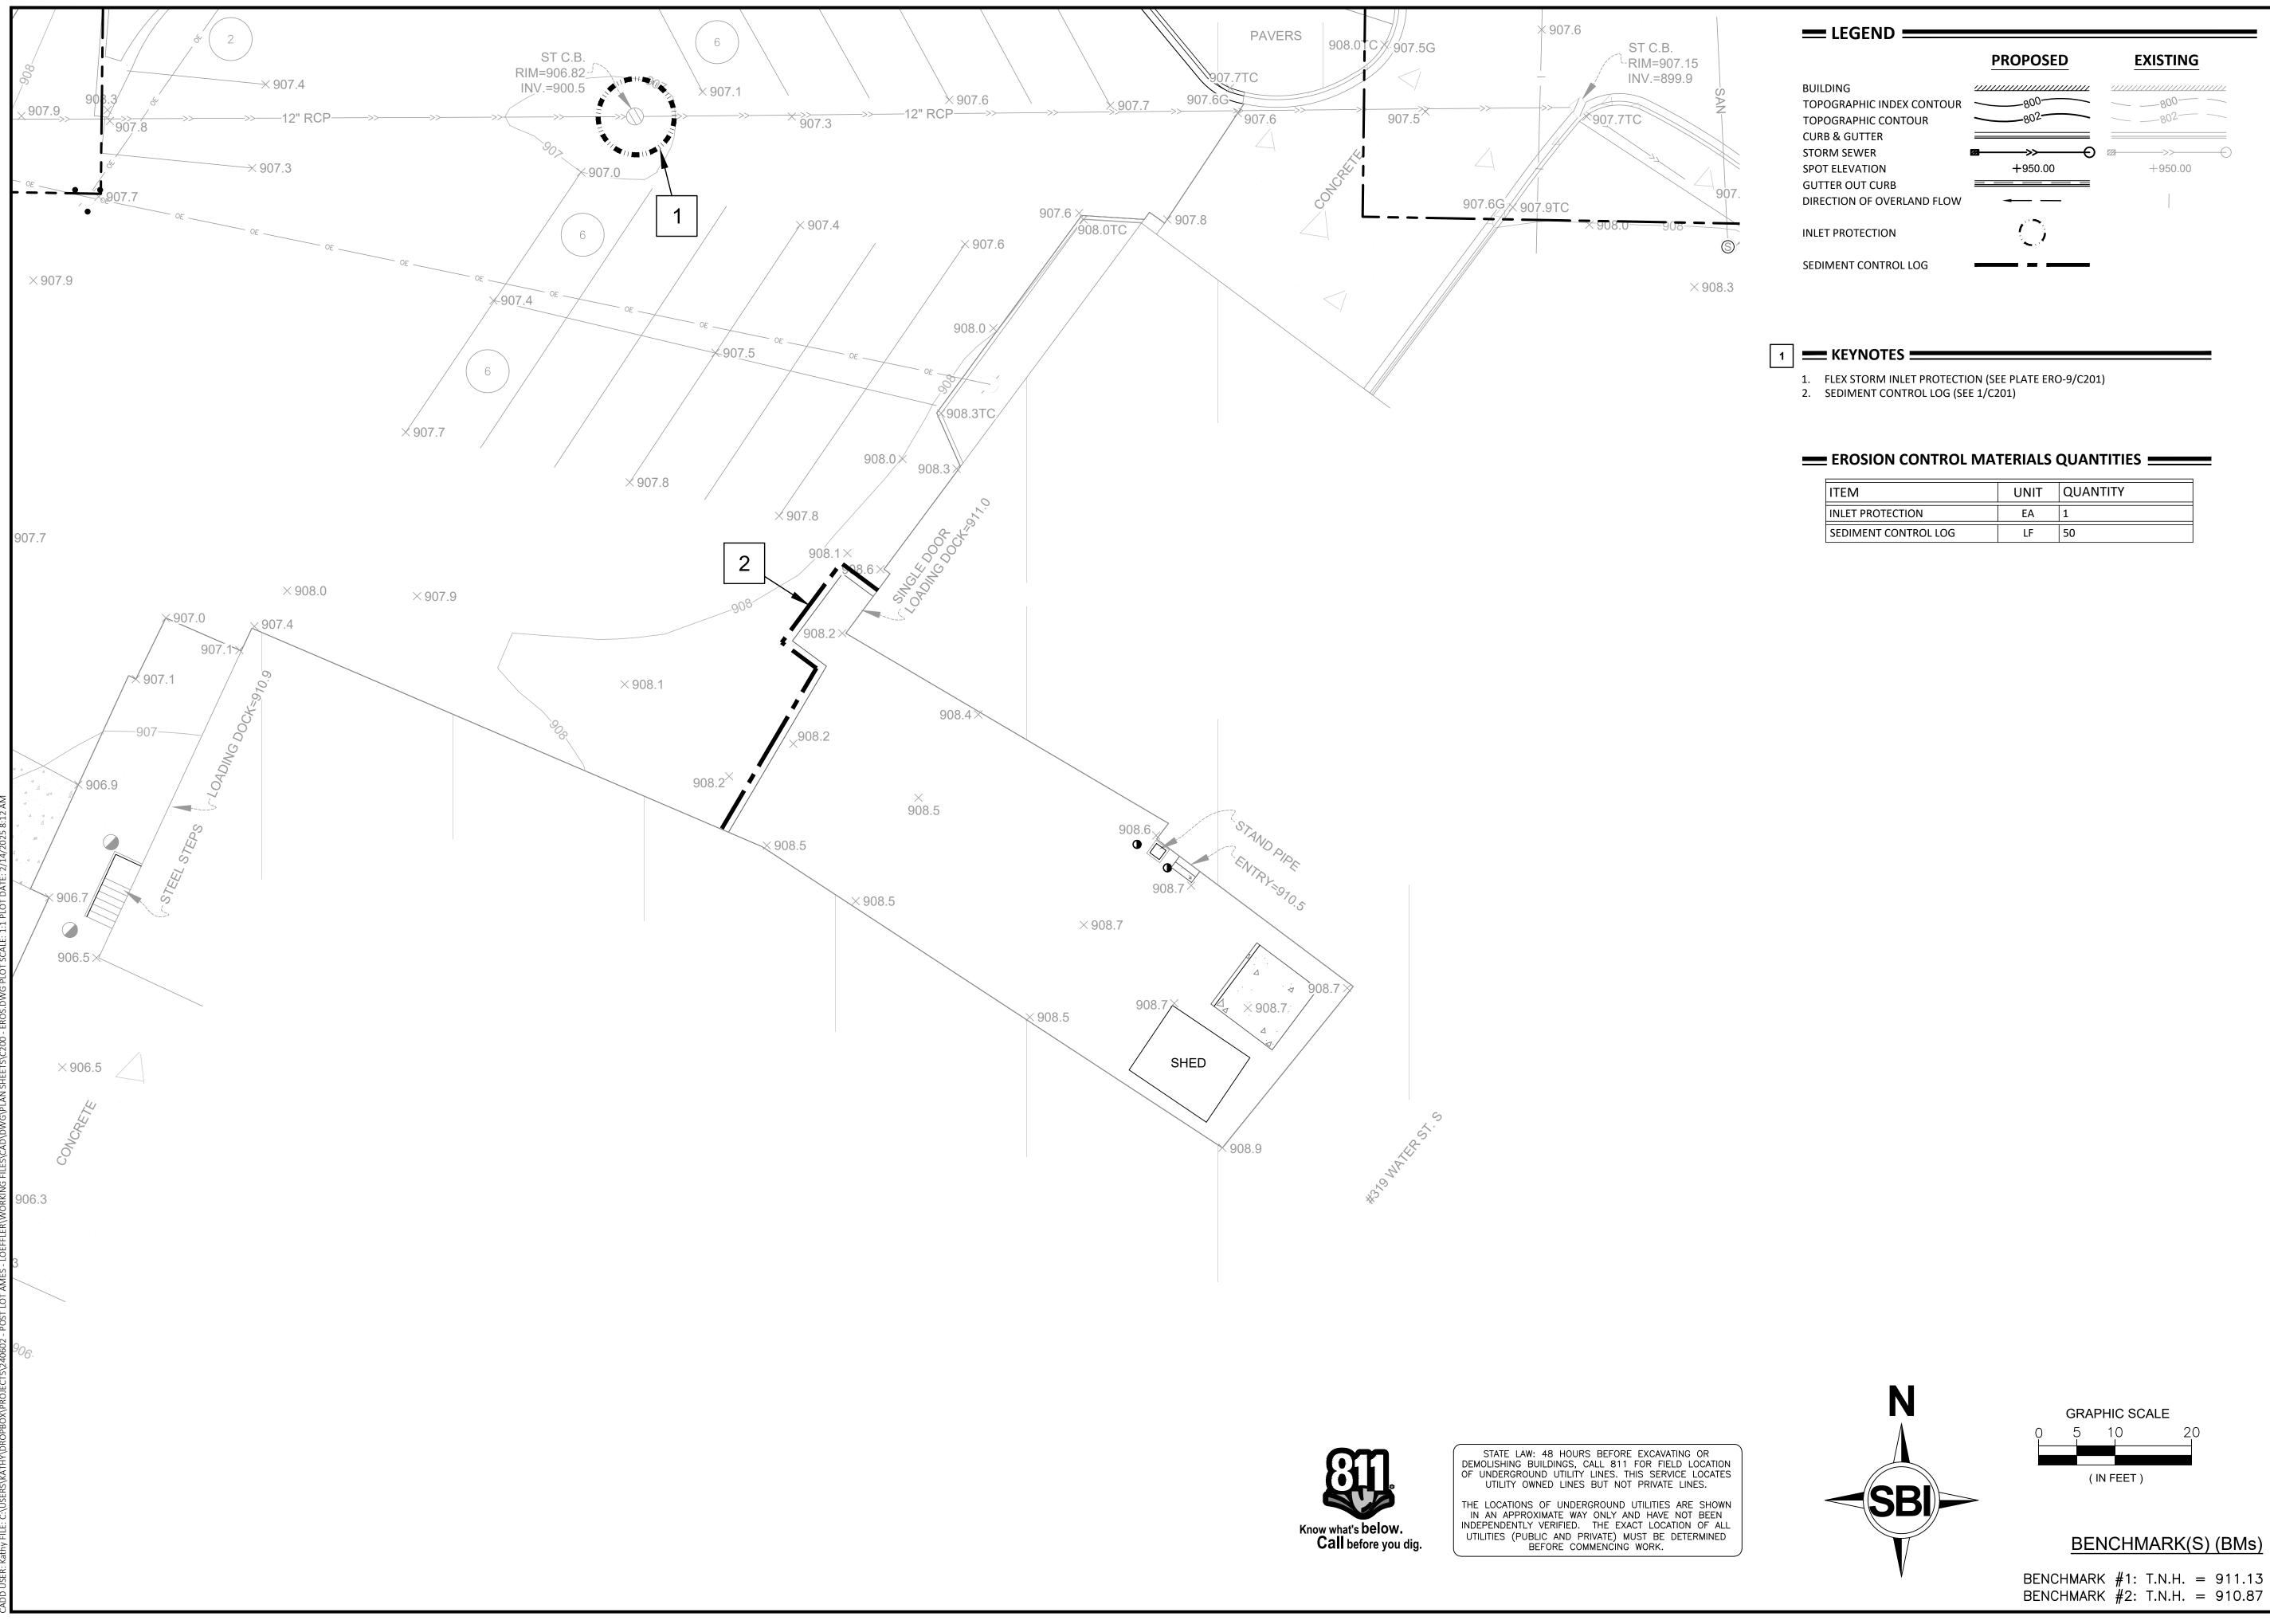
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LOEFFLER CONSTRUCTION AND CONSULTING LAKEVILLE, MN

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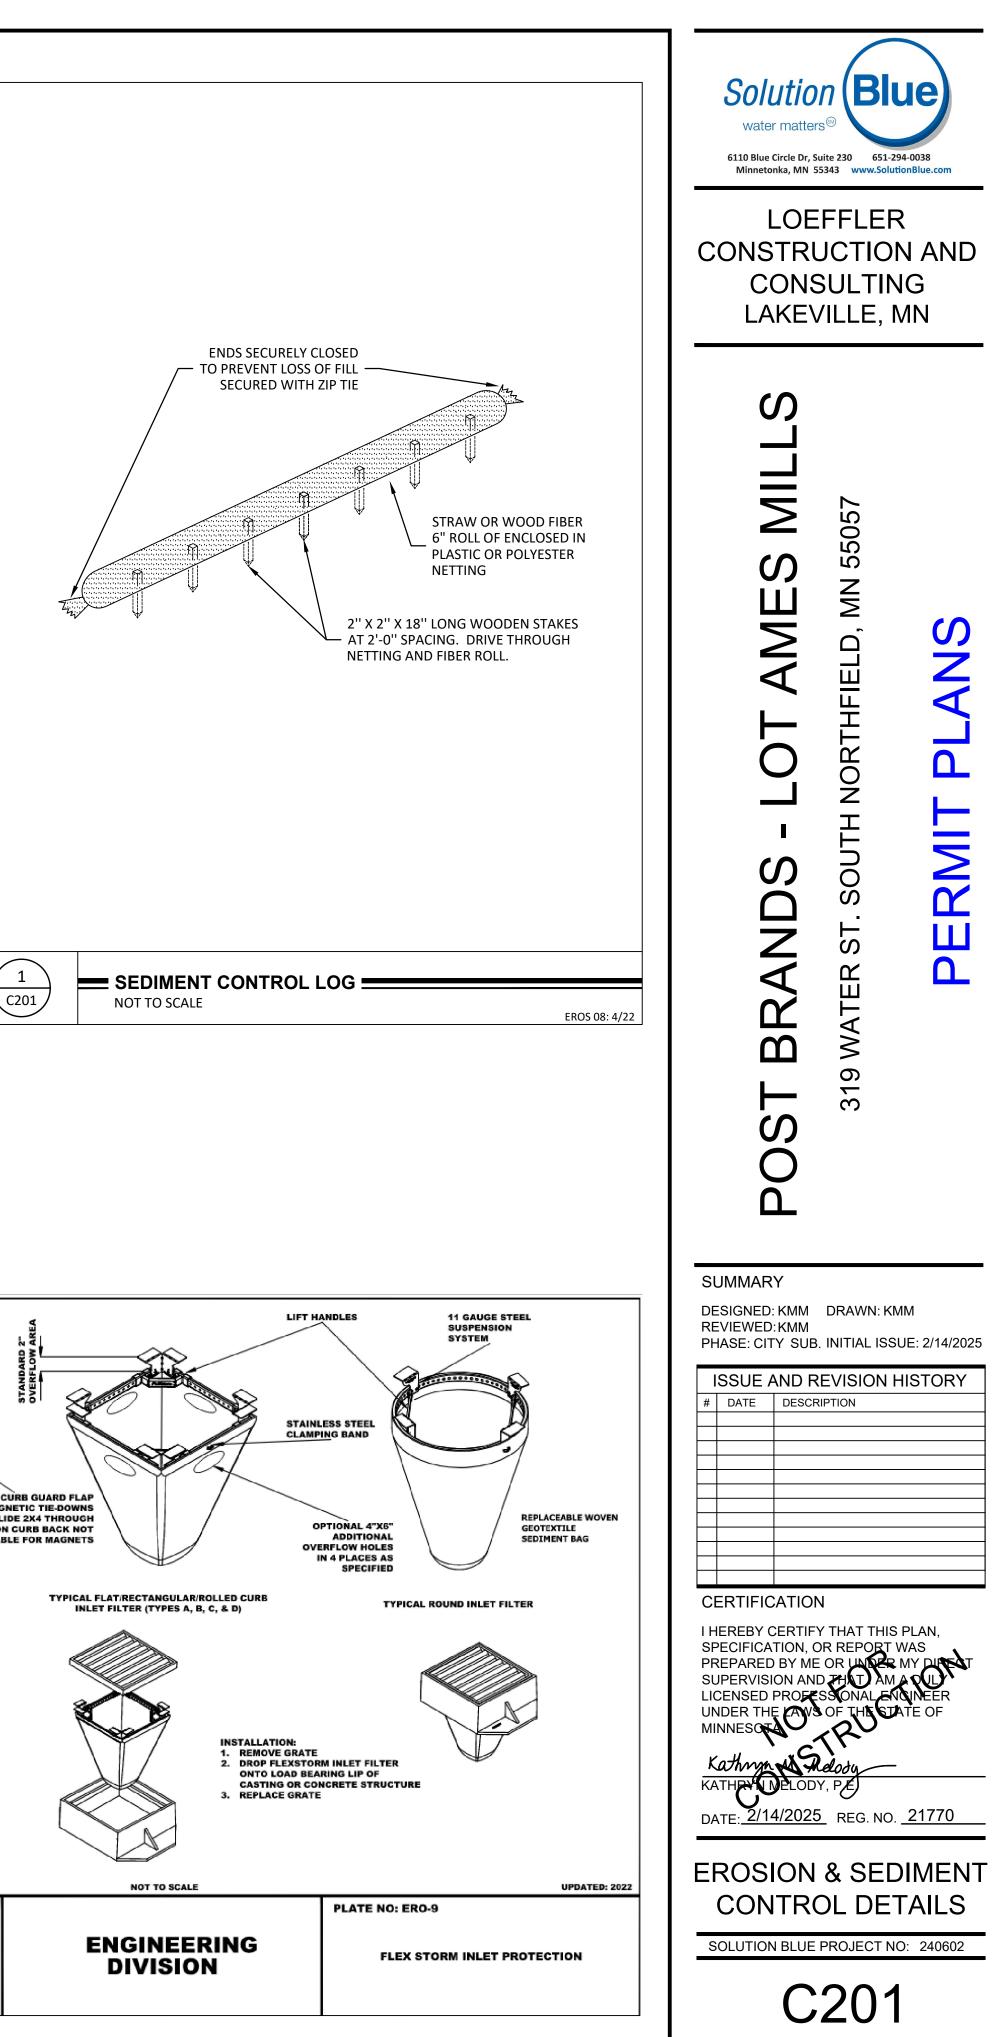
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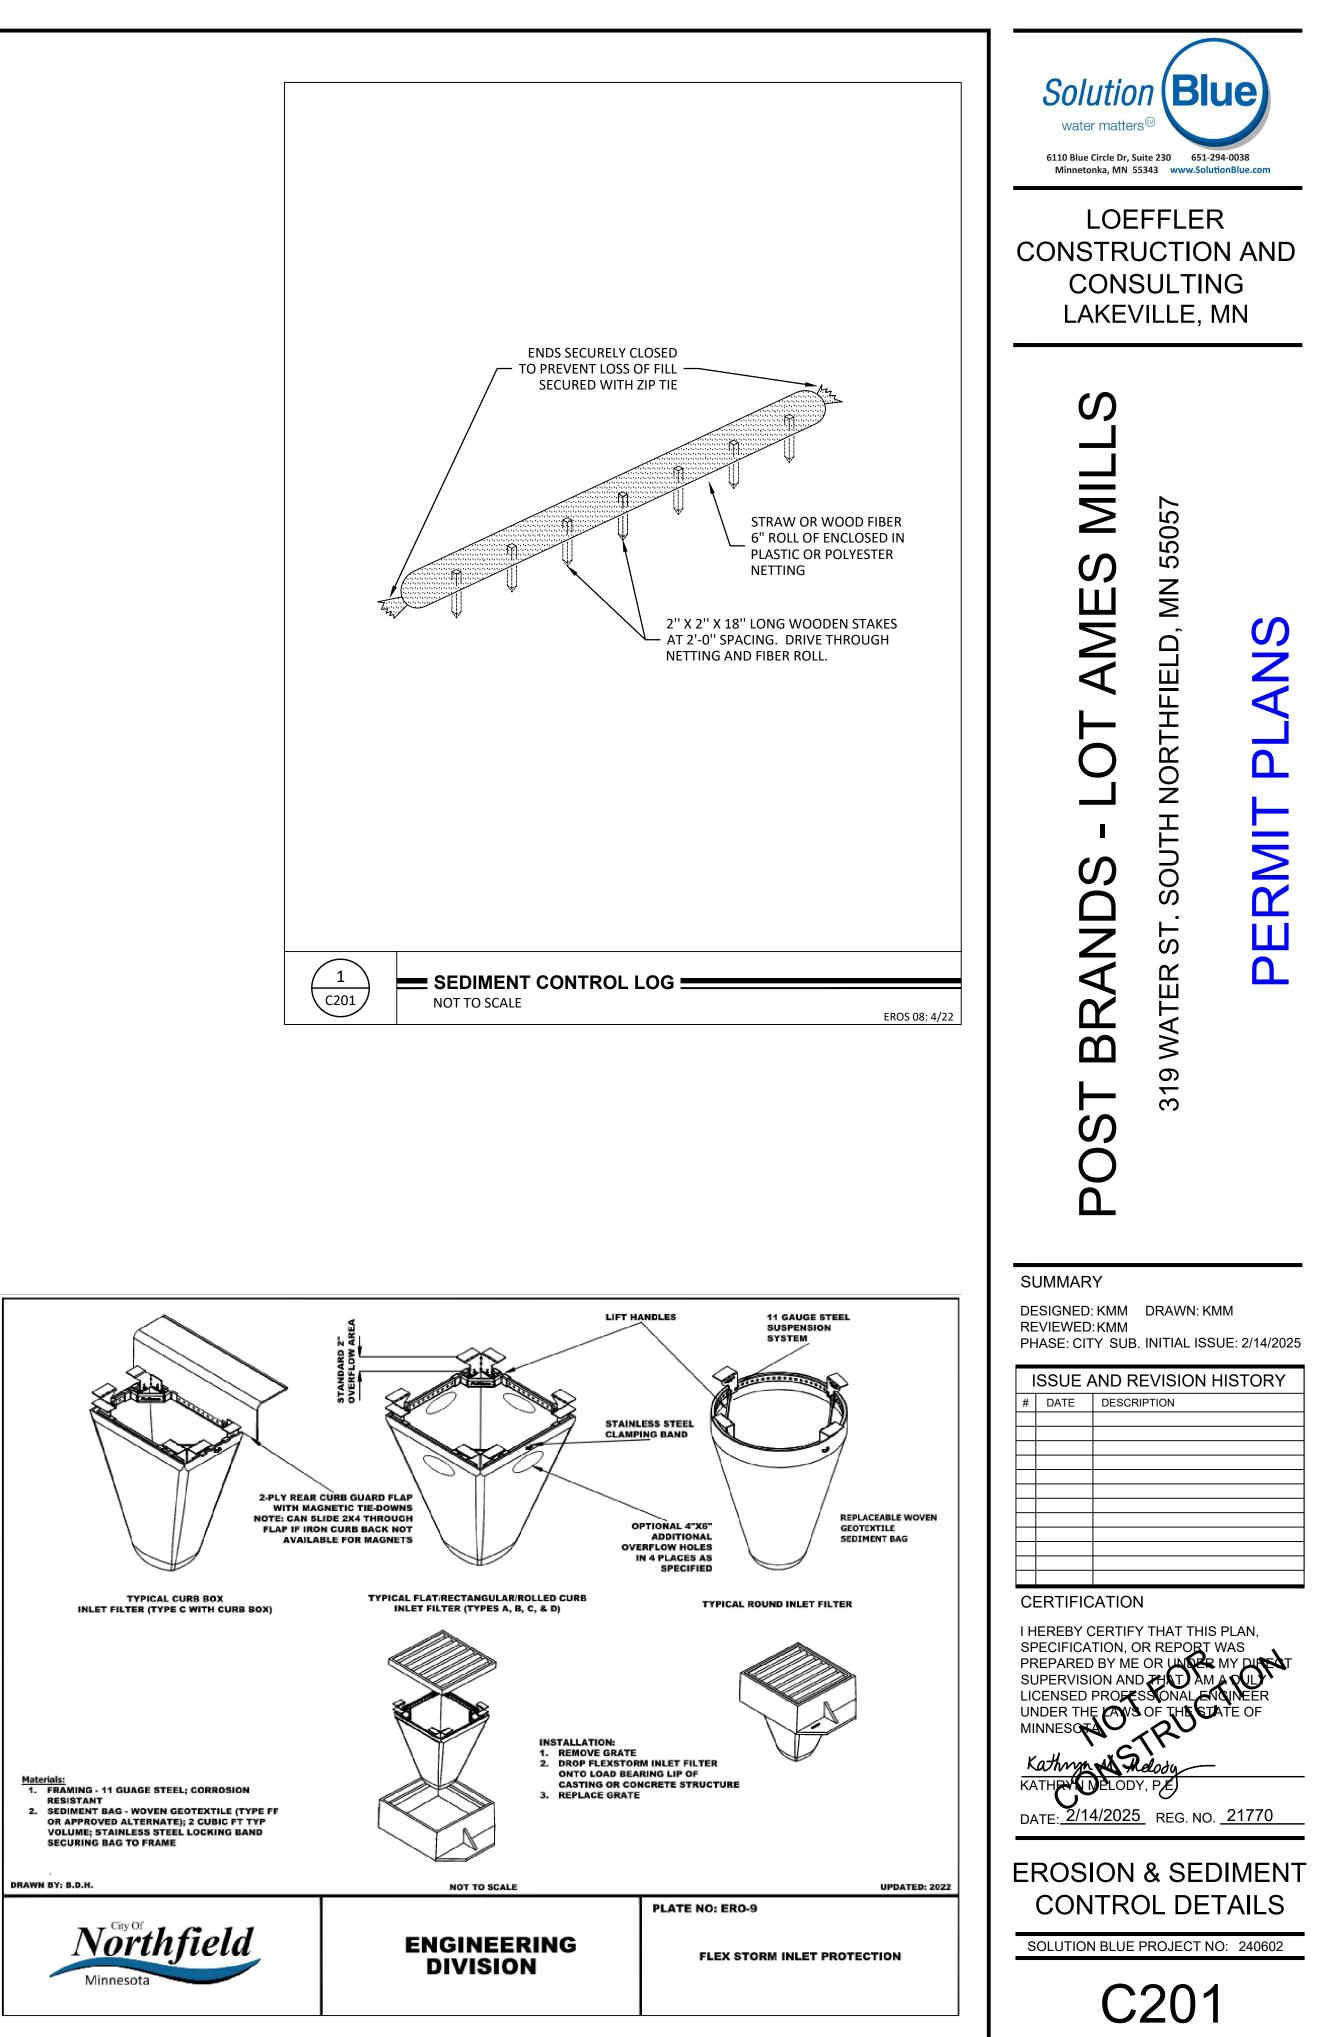
Kathryn H Adody KATHRYN NELODY, PE DATE: 2/14/2025 REG. NO. 21770


**EROSION & SEDIMENT** CONTROL

SOLUTION BLUE PROJECT NO: 240602







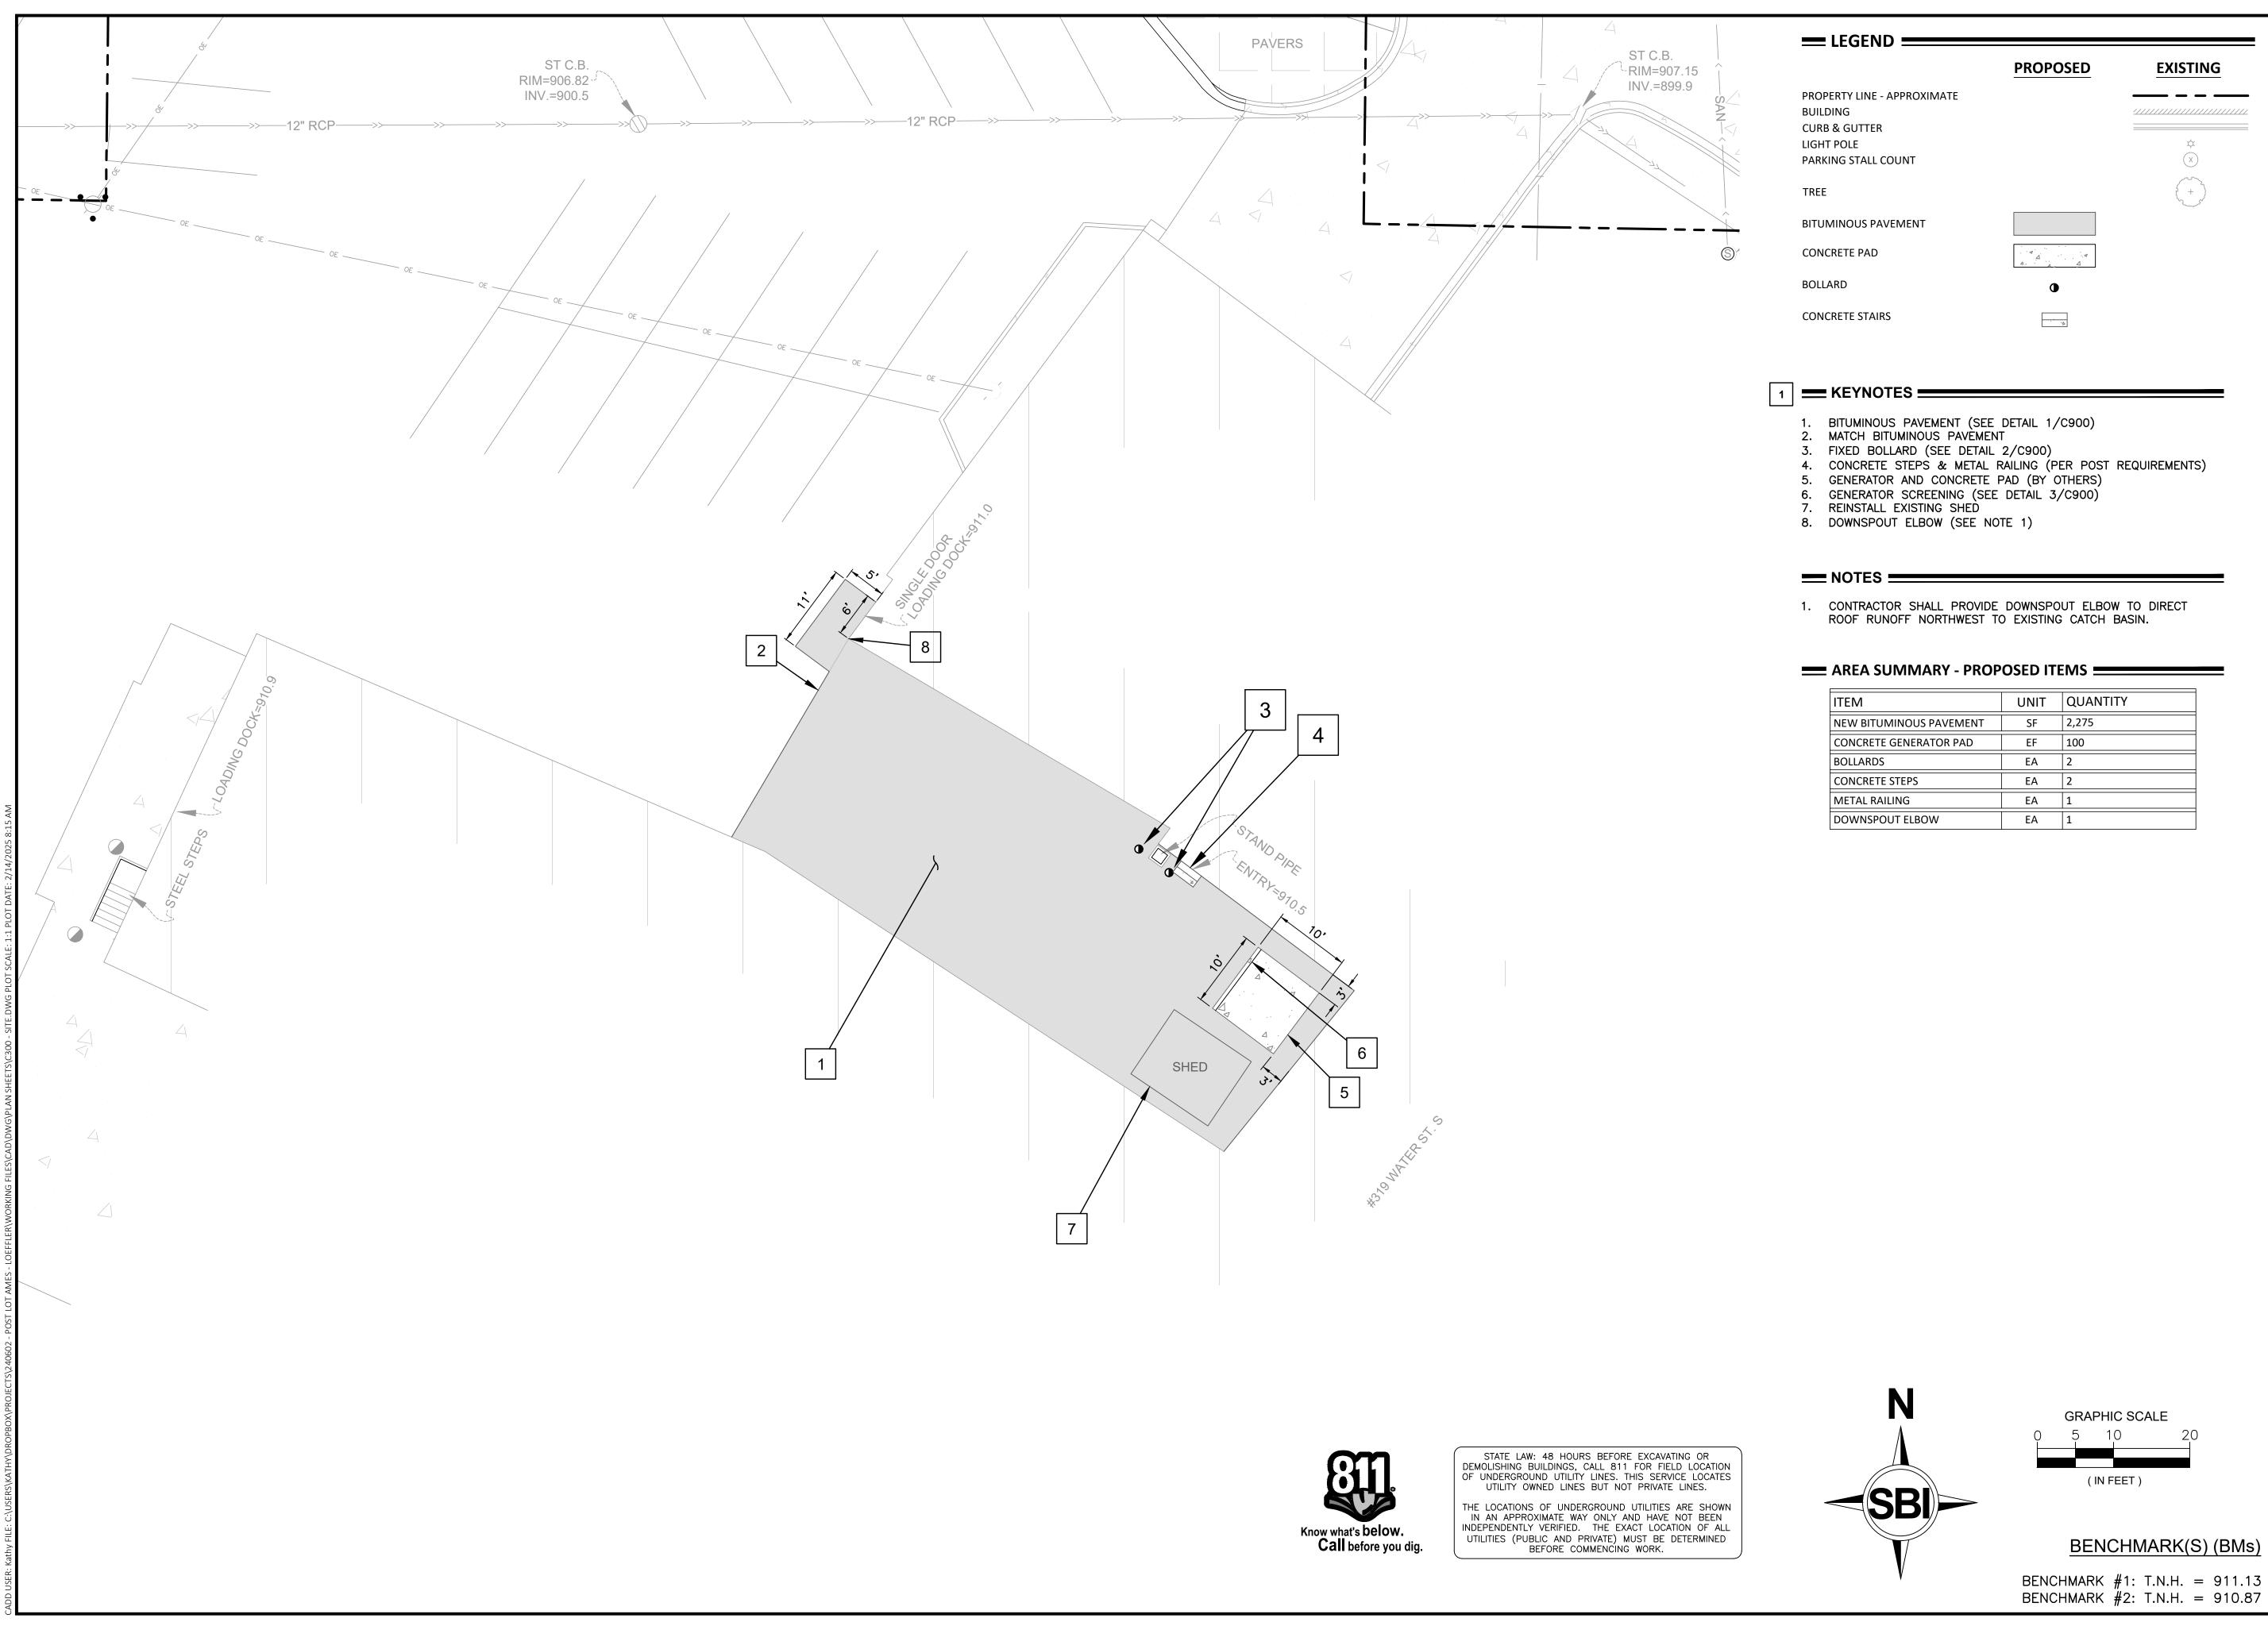


1	UNIT	QUANTITY
BITUMINOUS PAVEMENT	SF	2,275
CRETE GENERATOR PAD	EF	100
ARDS	EA	2
CRETE STEPS	EA	2
AL RAILING	EA	1
NSPOUT ELBOW	EA	1

6110 Blue Circle Dr, Suite 230 651-294-0038 Minnetonka, MN 55343 www.SolutionBlue.com								
LOEFFLER CONSTRUCTION AND CONSULTING LAKEVILLE, MN								
POST BRANDS - LOT AMES MILLS 319 WATER ST. SOUTH NORTHFIELD, MN 55057 PERMITTING PLANS								
SUMMARY         DESIGNED: KMM       DRAWN: KMM         REVIEWED: KMM         PHASE: CITY SUB. INITIAL ISSUE: 2/14/2025         ISSUE AND REVISION HISTORY         #         DATE         DESCRIPTION         H         DATE         ZORNARY								
SOLUTION BLUE	E PLA							
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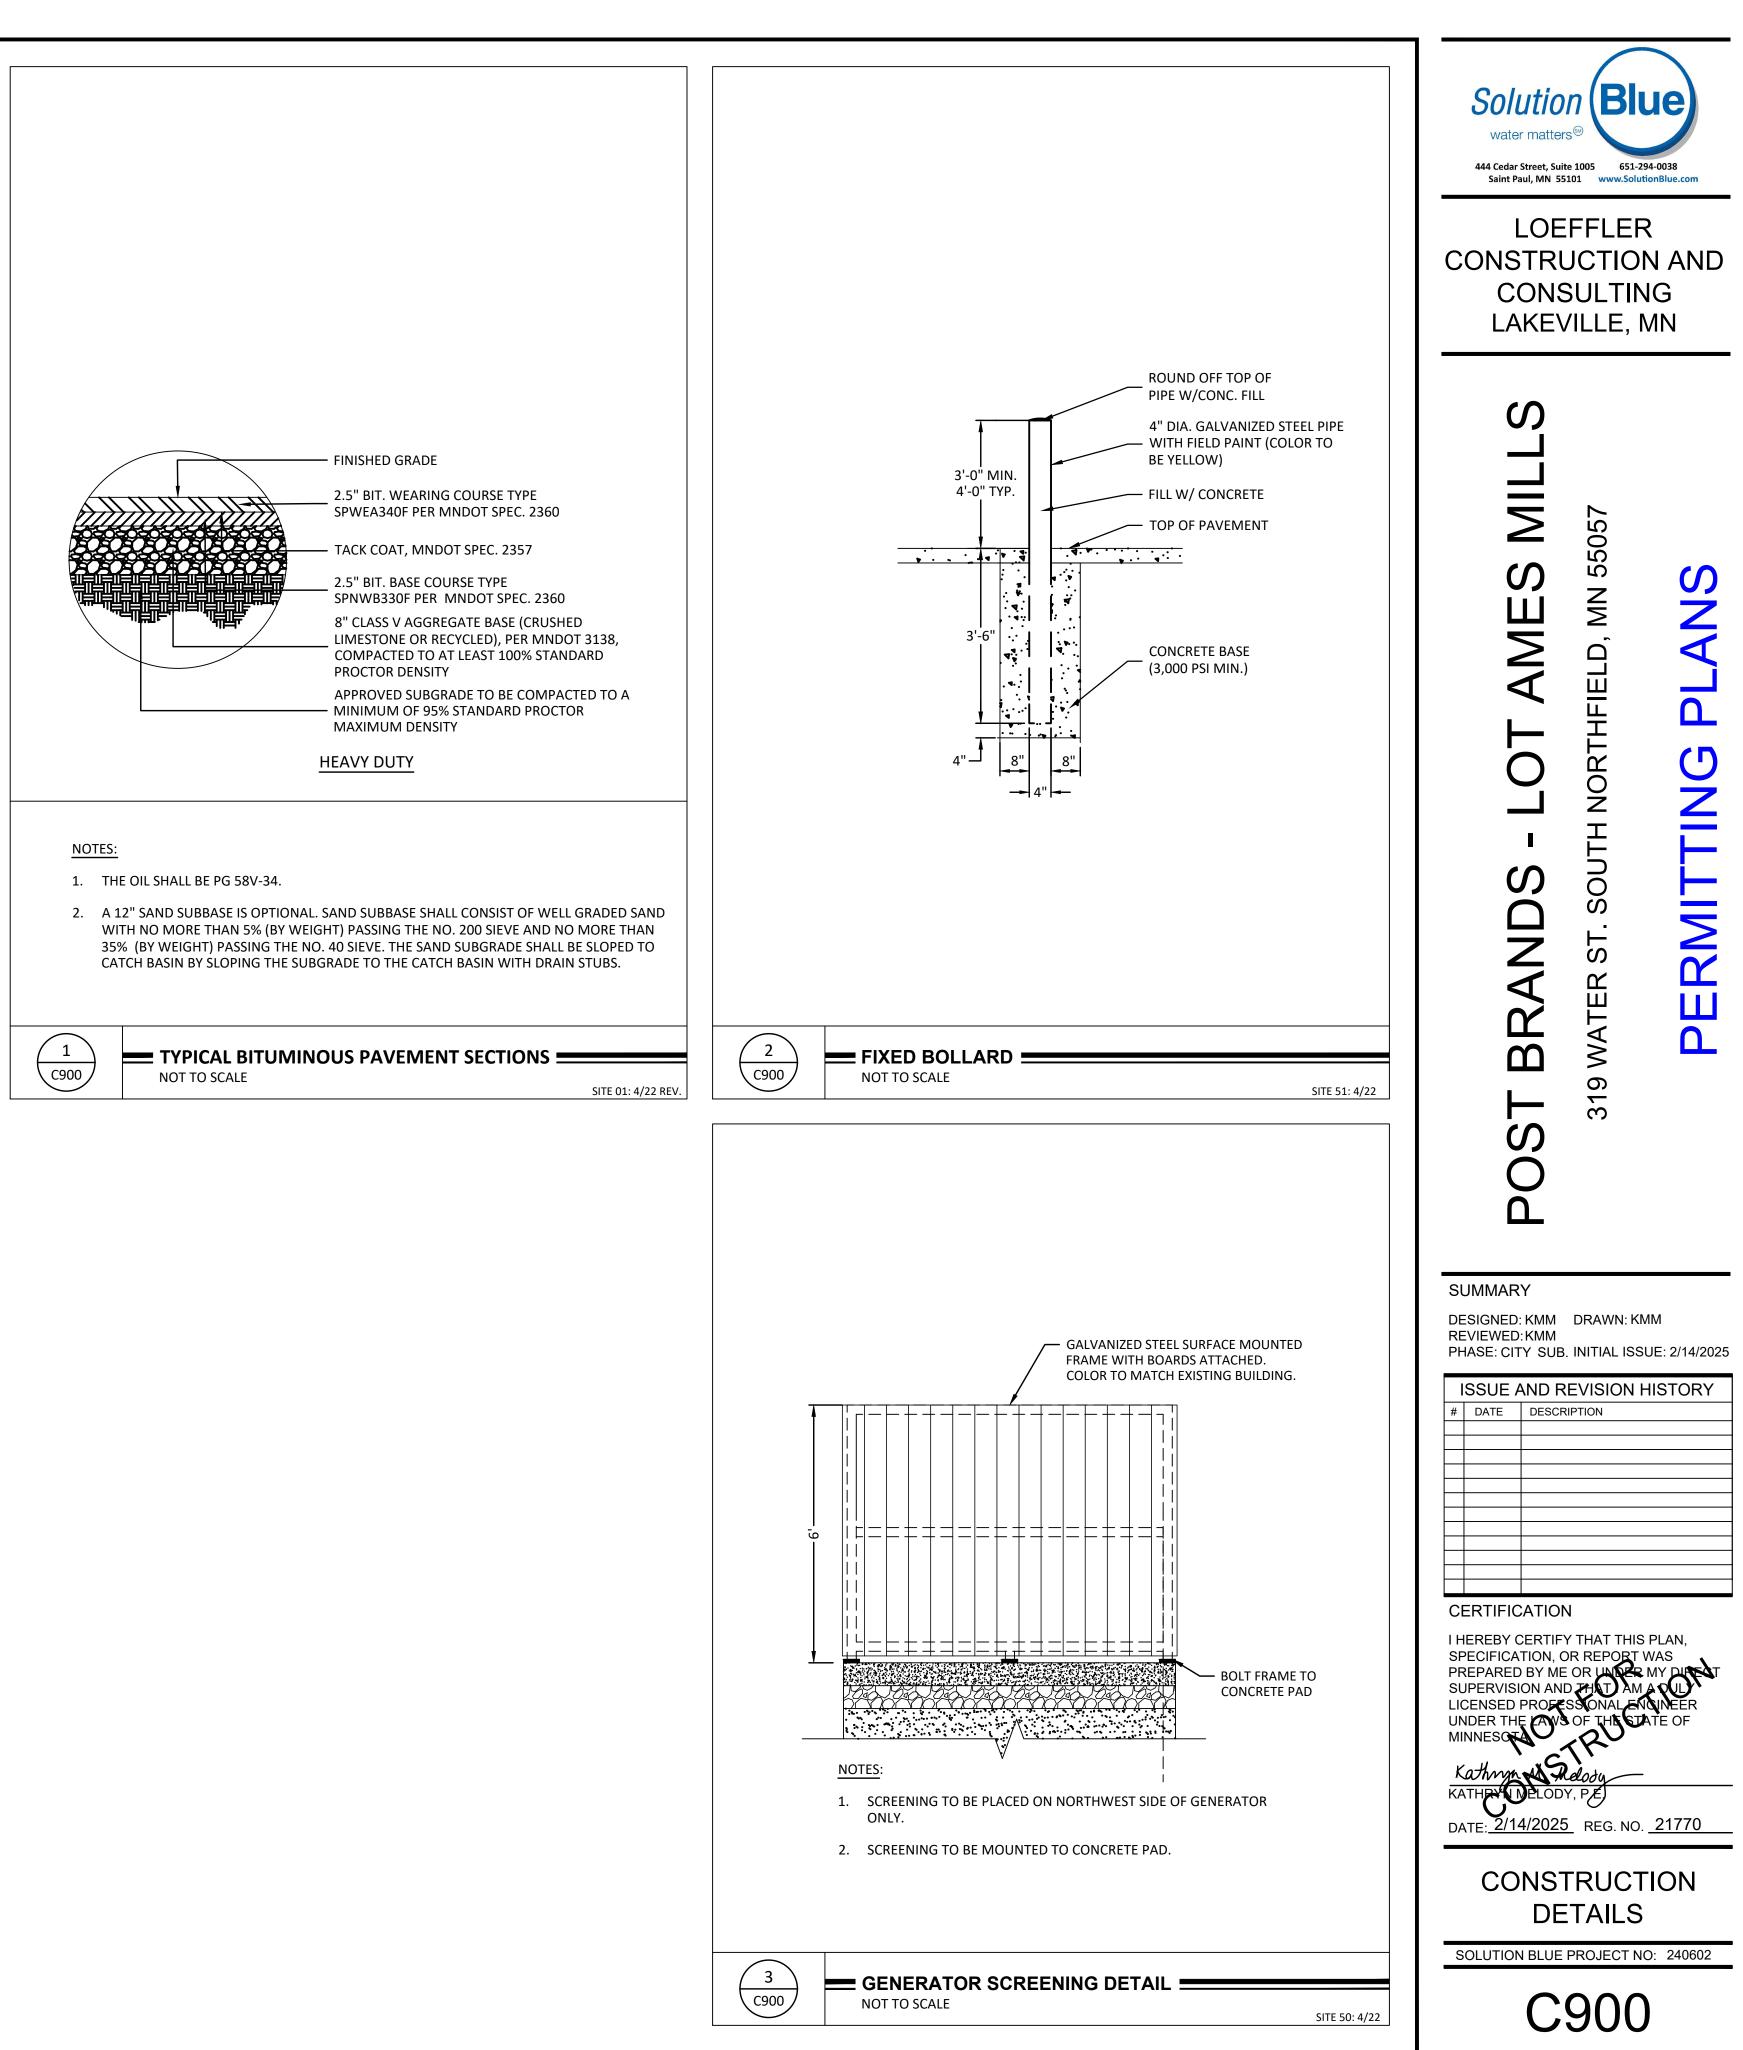
water matters®





	PROPOSED	EXISTING
LINE - APPROXIMATE		<u> </u>
JTTER PHIC INDEX CONTOUR PHIC CONTOUR ATION	+950.00 (ME)	910 908 +950.00
STING SLOPE NCREASE OVER EXISTING	(₩E) <b>4</b> % (+3")	
PAD		
STAIRS	4	

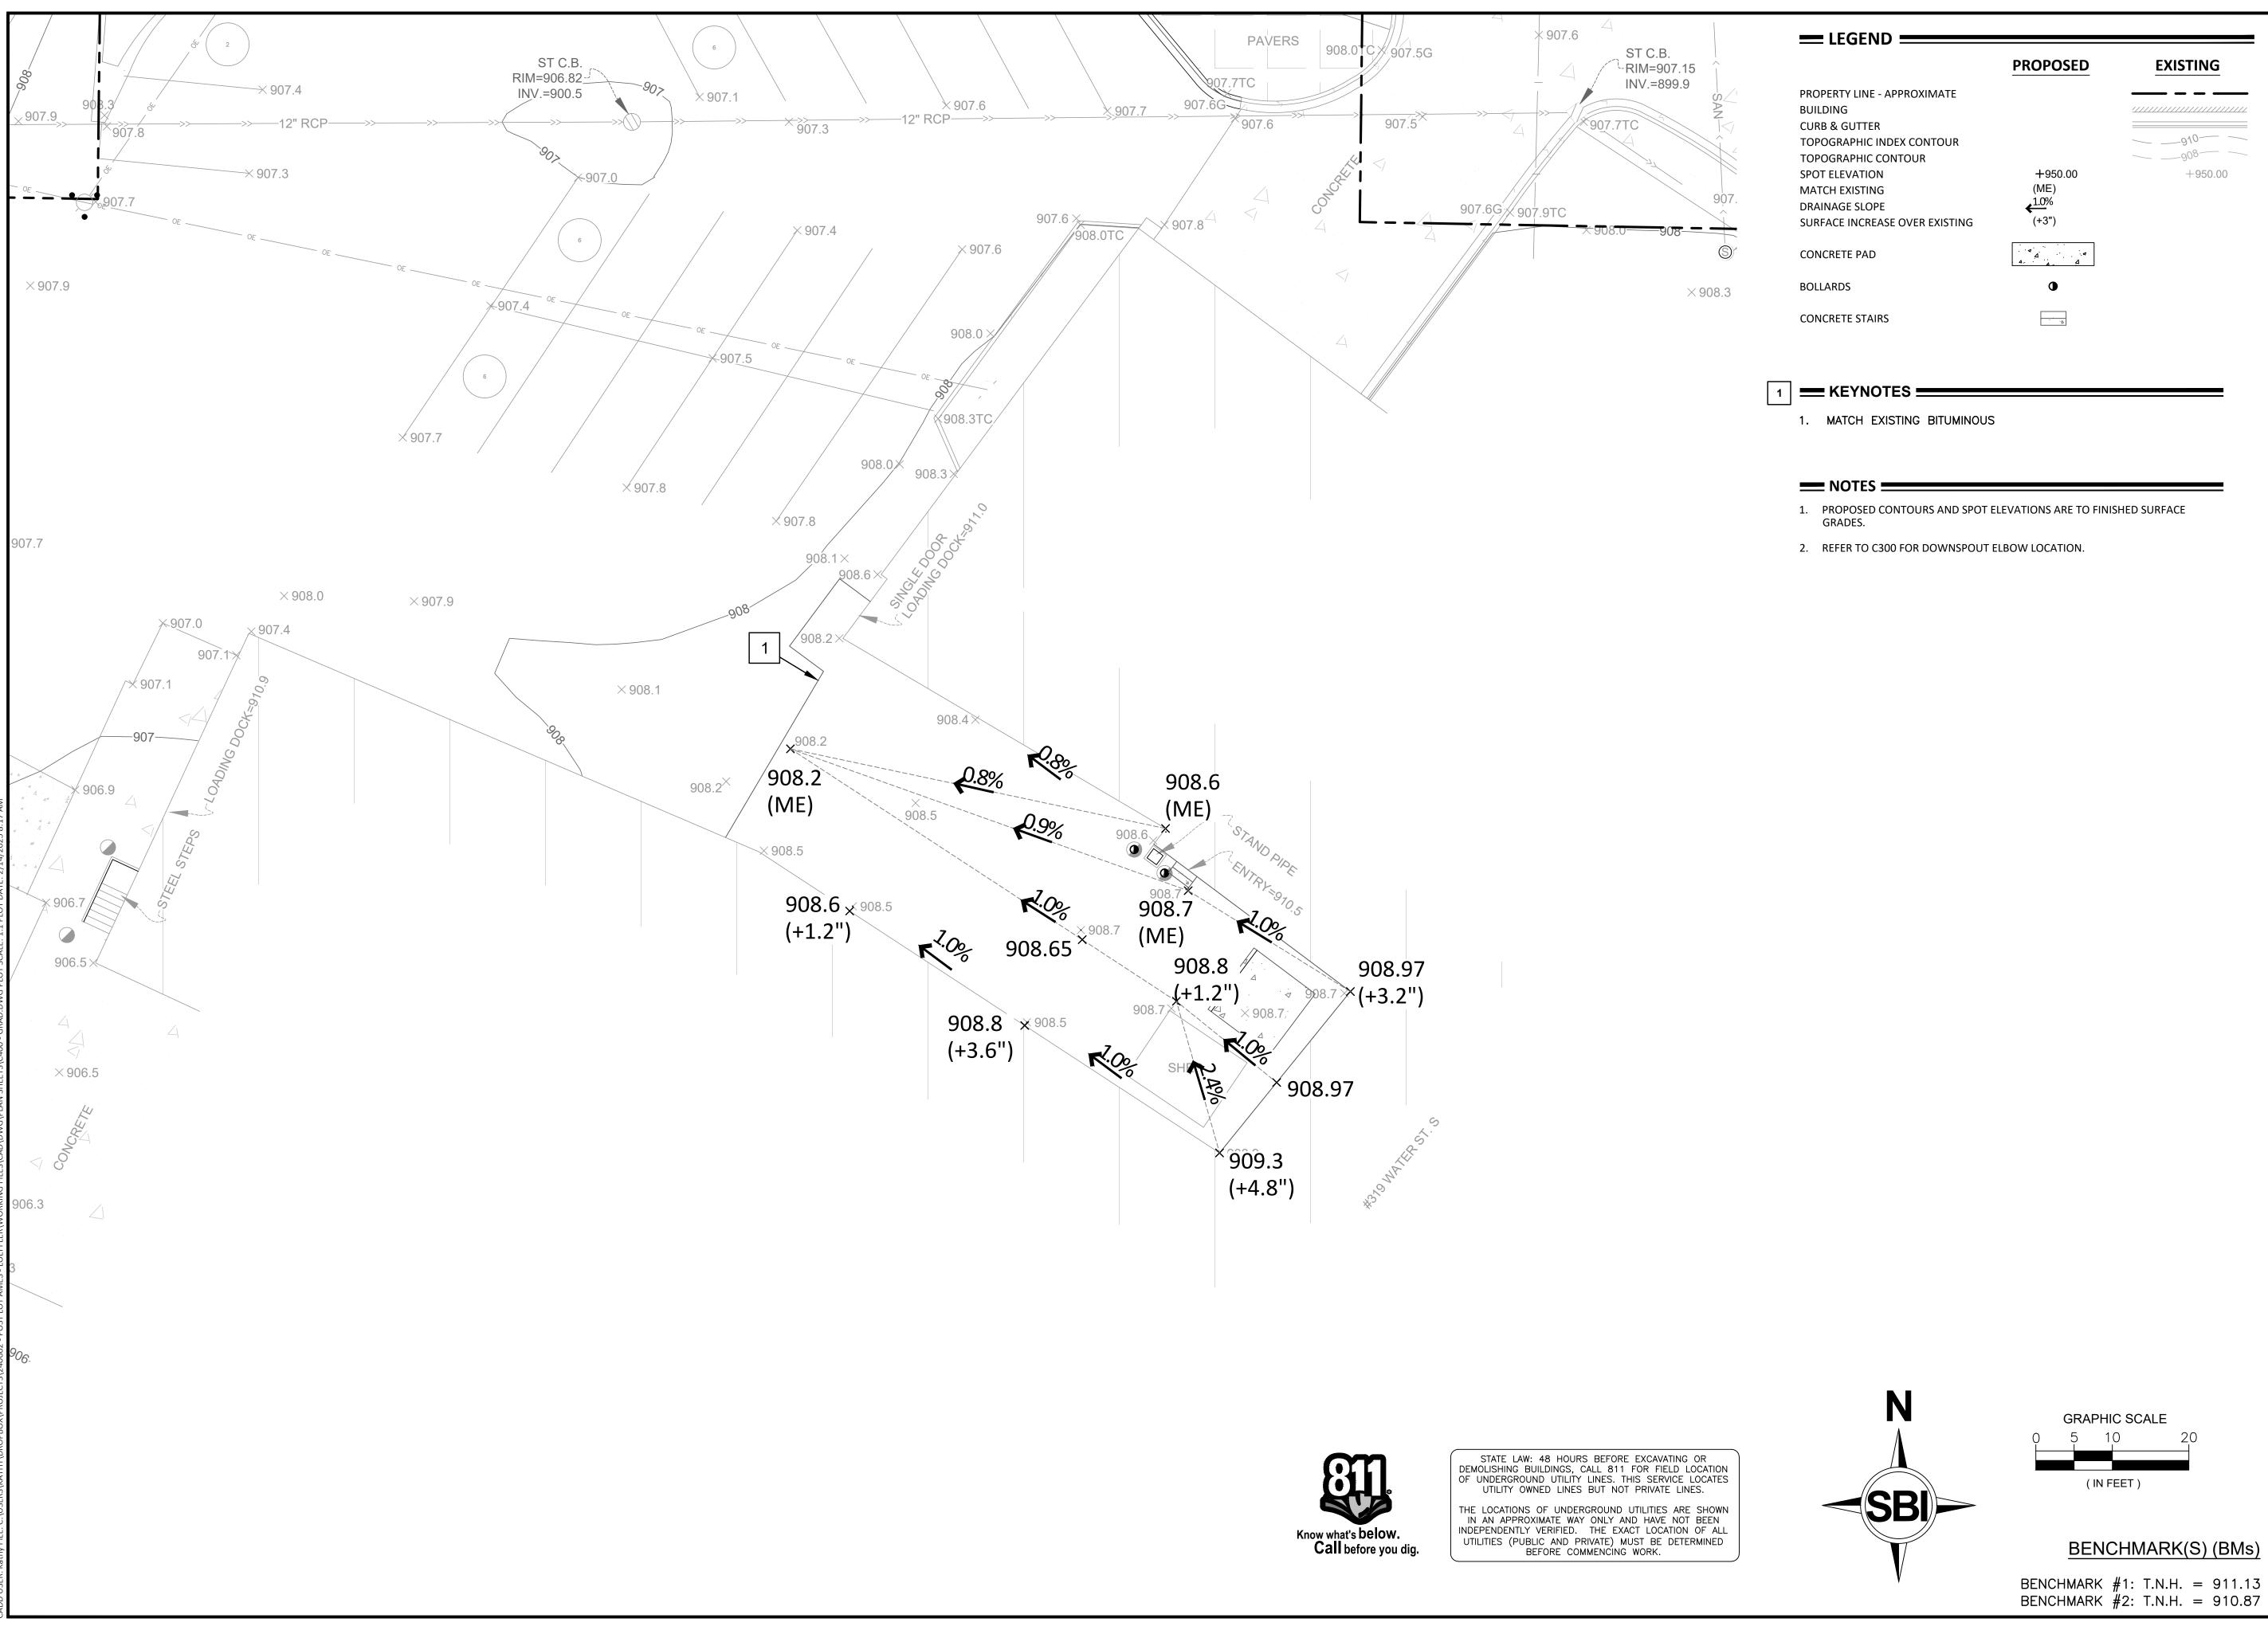
Solution Blue water matters® 6110 Blue Circle Dr, Suite 230 651-294-0038									
6110 Blue Circle Dr, Suite 230 Minnetonka, MN 55343 WWW.SolutionBlue.com									
POST BRANDS - LOT AMES MILLS	319 WATER ST. SOUTH NORTHFIELD, MN 55057	BERMITTING PLANS							
DESIGNED: KMM REVIEWED: KMM PHASE: CITY SUB. ISSUE AND R # DATE DESCR	INITIAL ISS	SUE: 2/14/2025							
CERTIFICATION I HEREBY CERTIFY THAT THIS PLAN, SPECIFICATION, OR REPORT WAS PREPARED BY ME OR UNDER MY DIRECT SUPERVISION AND THAT AM A OUL LICENSED PROFESSIONAL ENGINEER UNDER THE AVS OF THE STATE OF MINNESOTS KATHENE DELODY, P.E. DATE: 2/14/2025 REG. NO. 21770									
GRAD	ING P	LAN							
	PROJECT N								

20



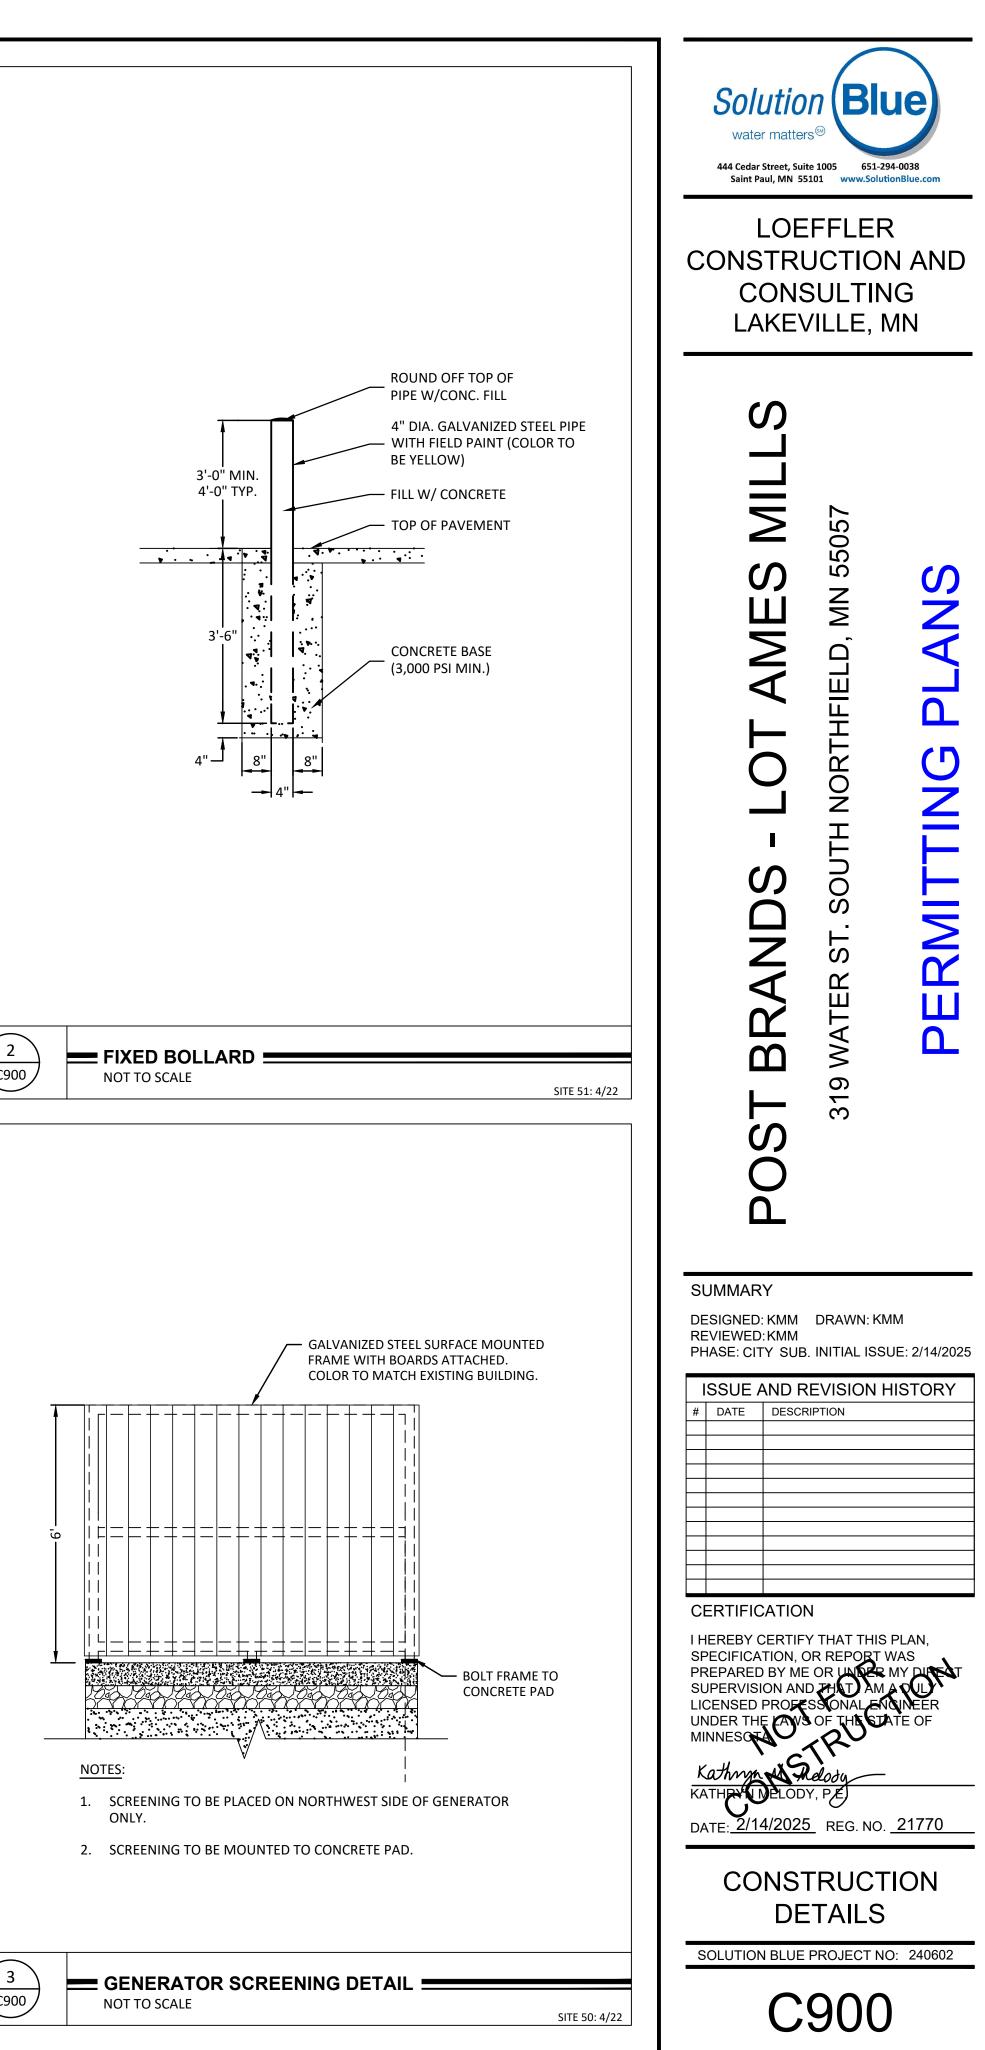

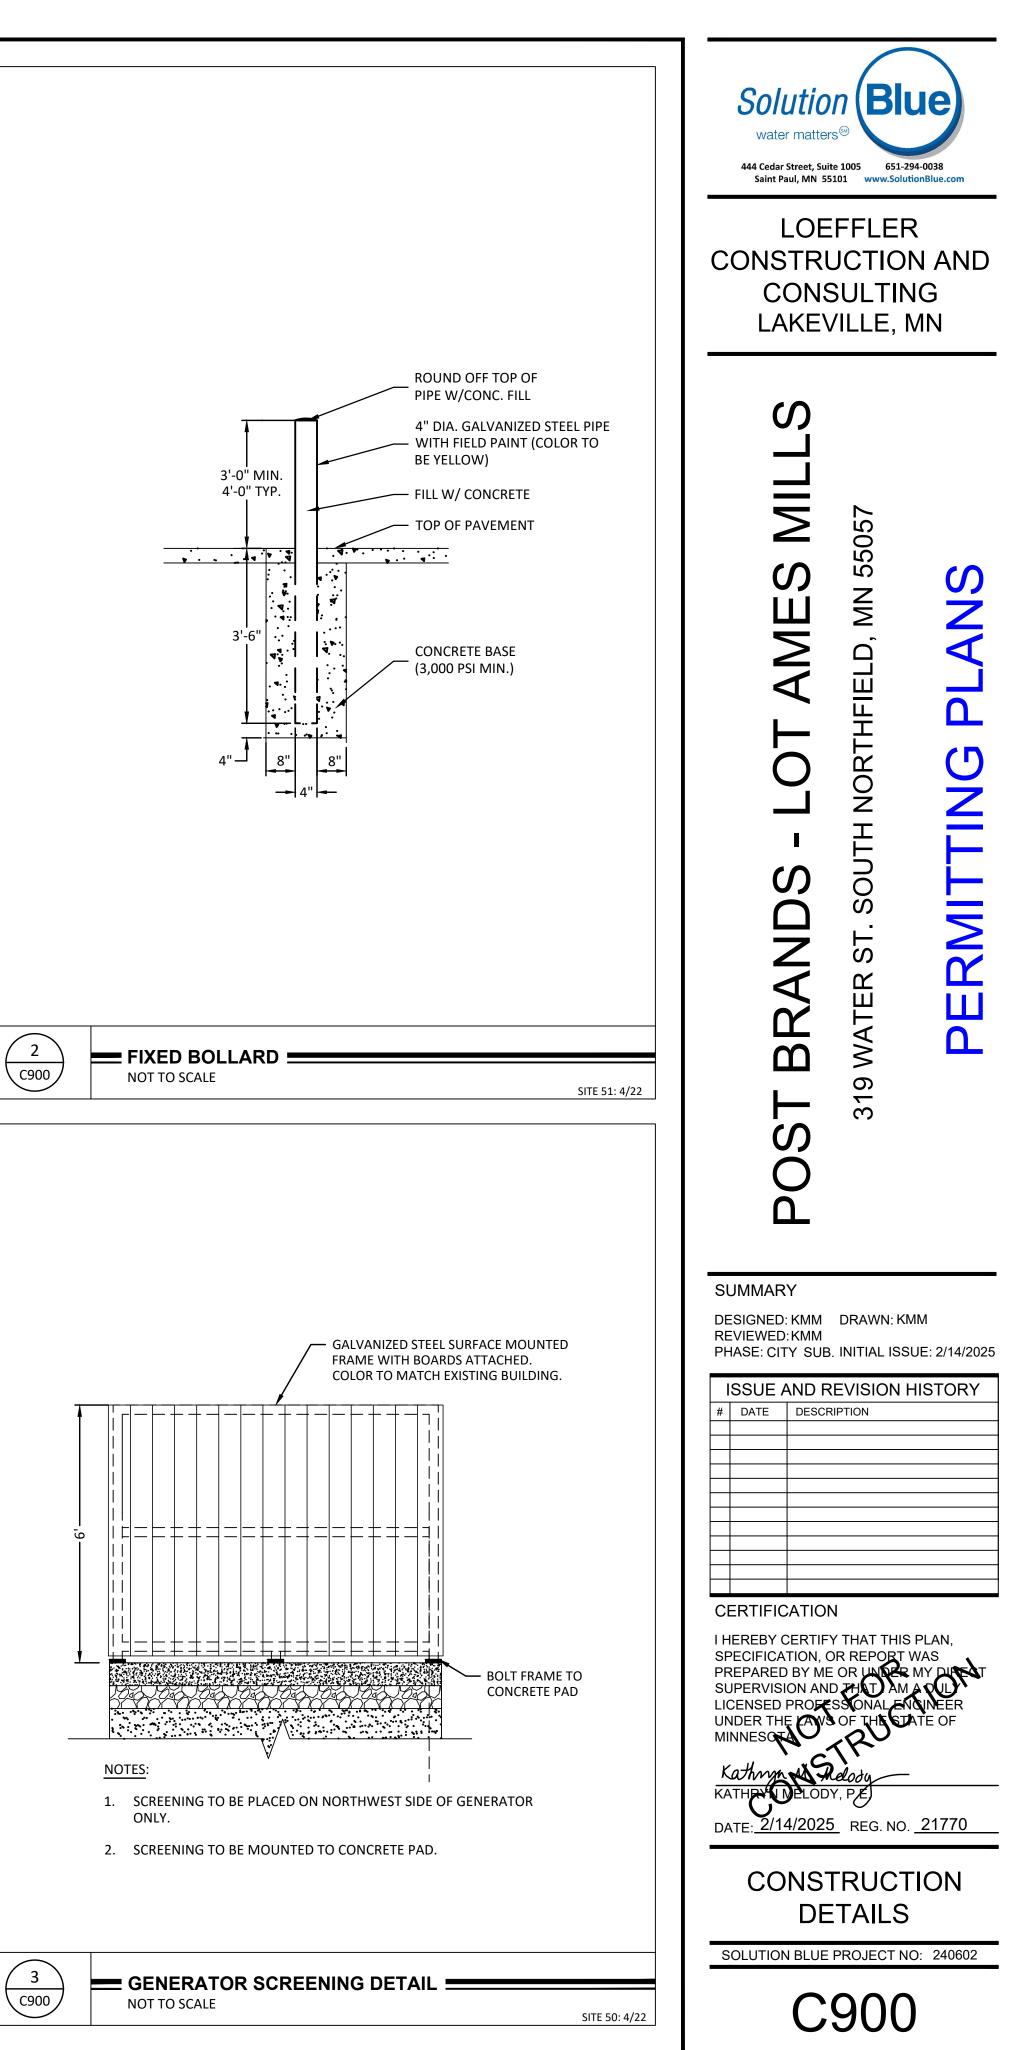

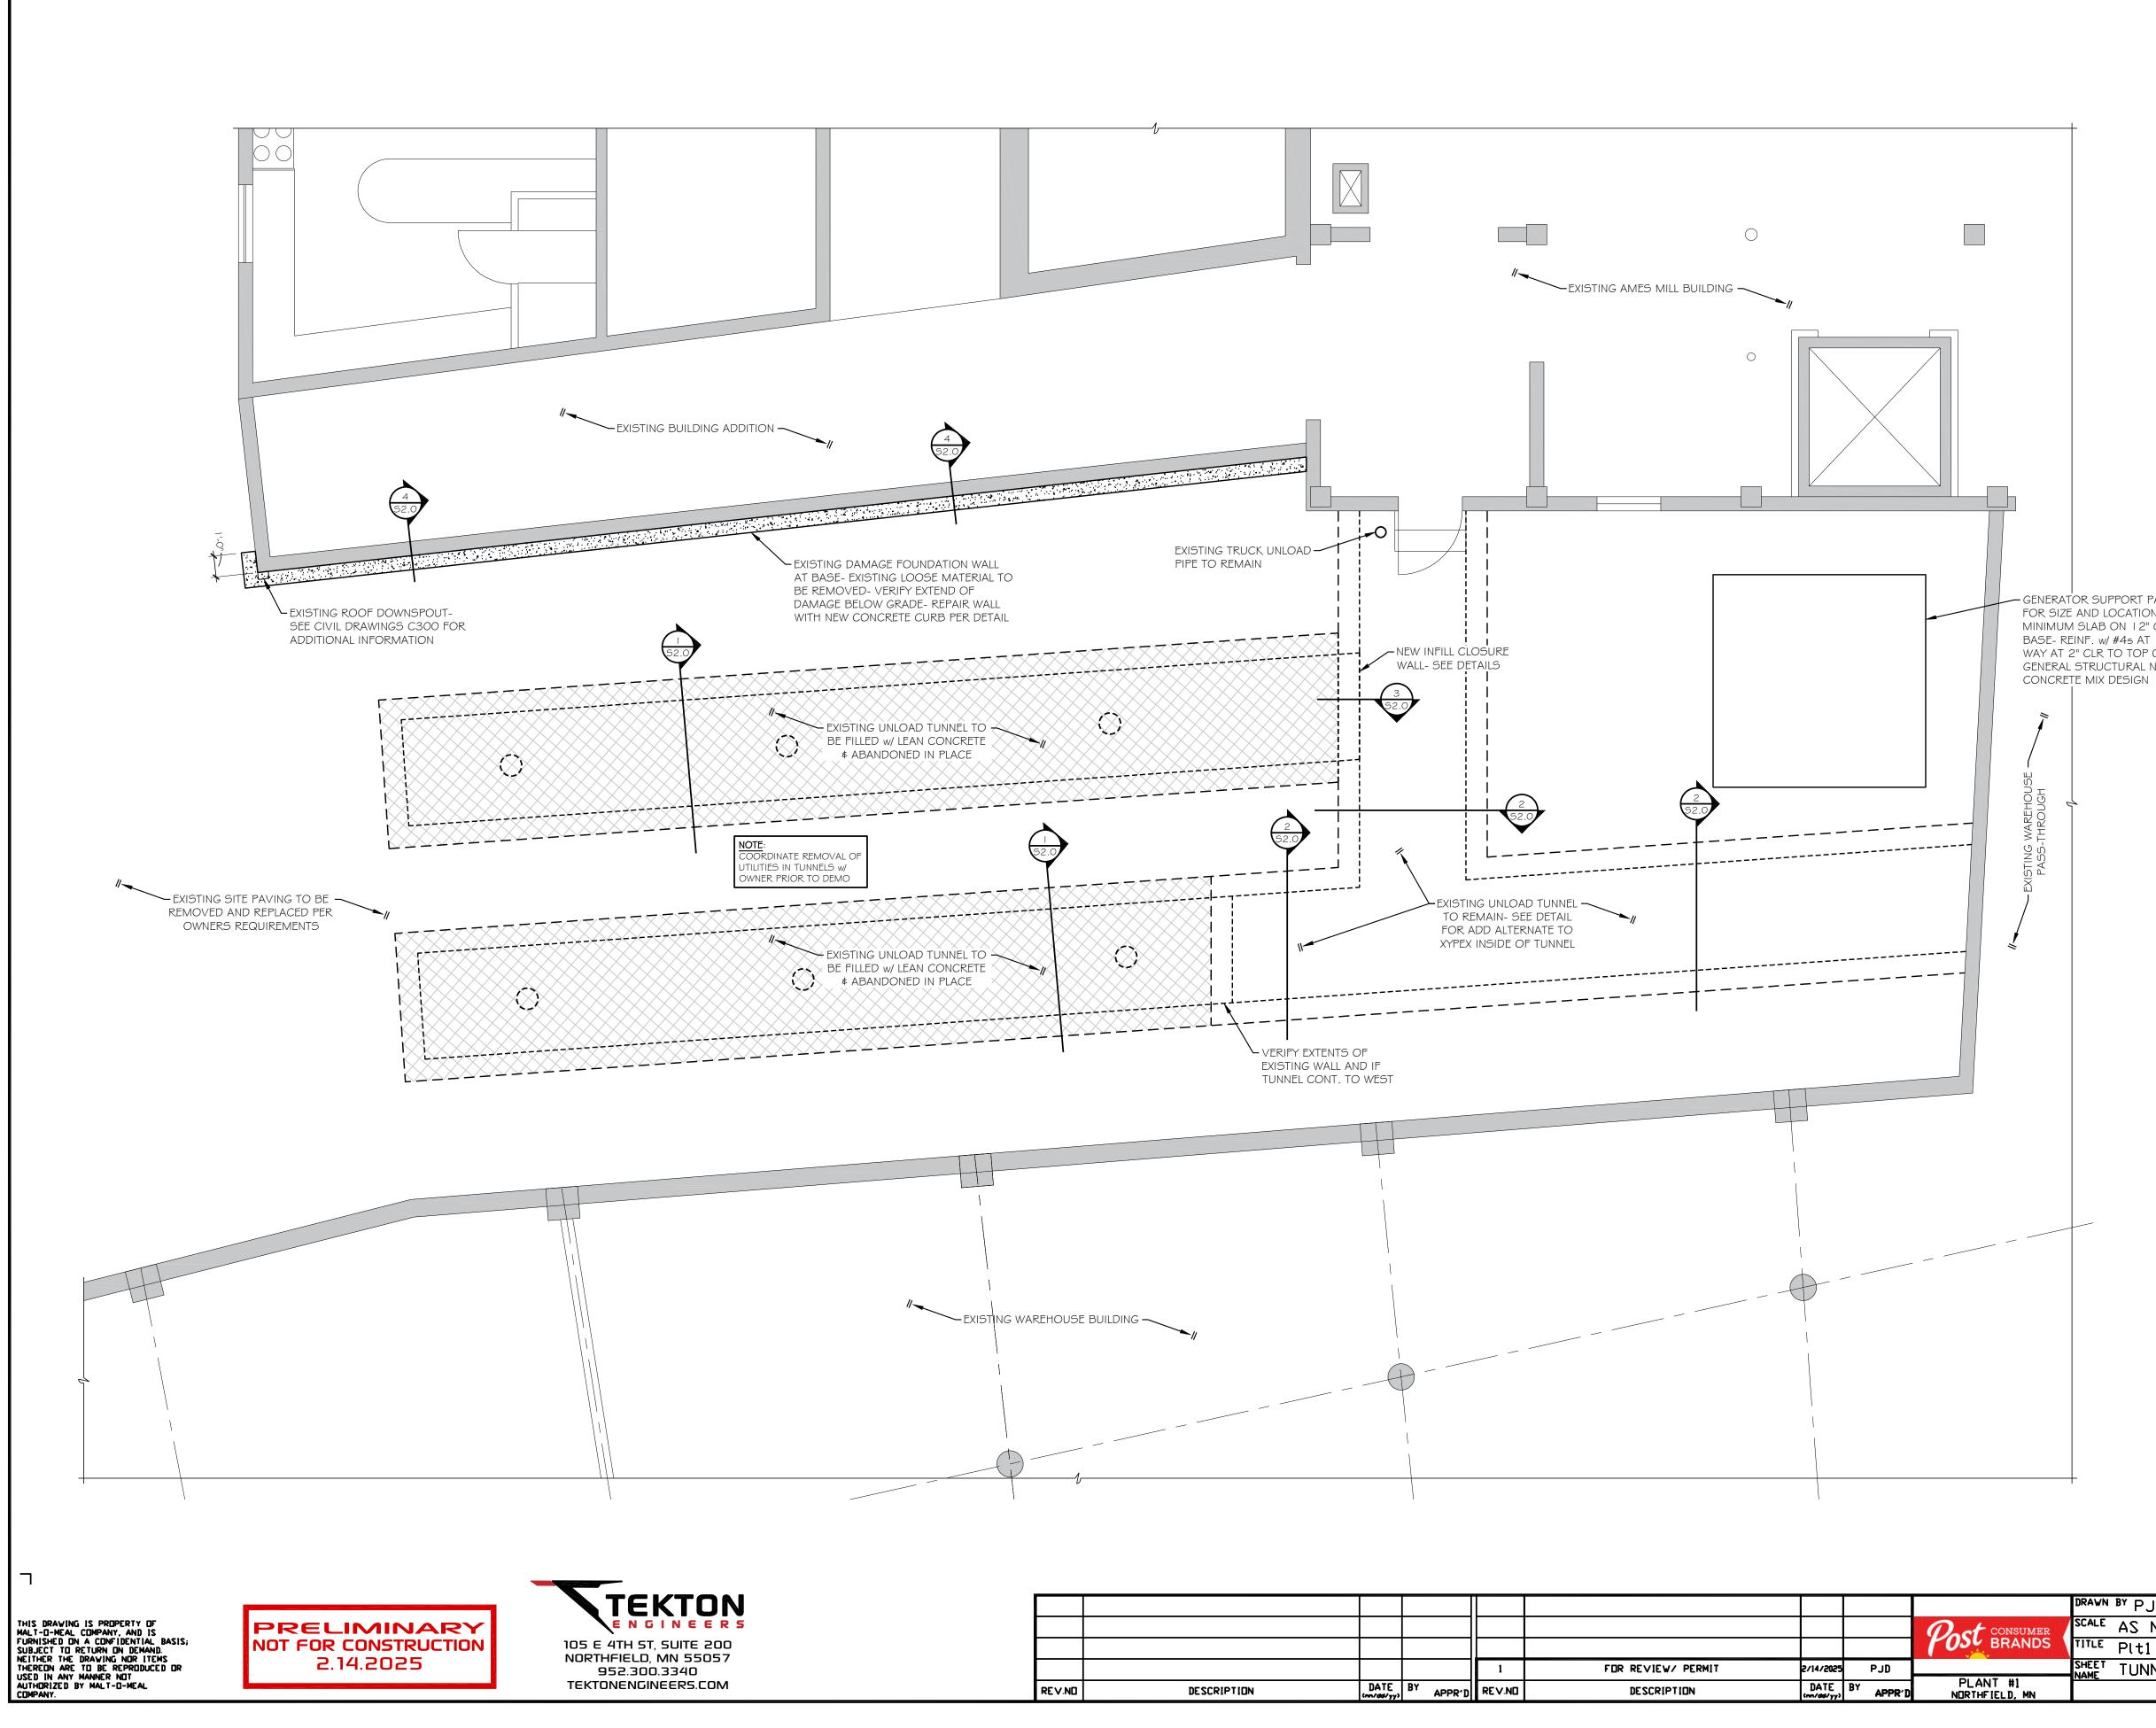

	IMPORTANT: DRAWING SCALE APPLICABLE TO ANSI D (34×22) SIZED PLOTS											
									DRAWN BY PJD - TEKTON ENGINEERS ORIGINAL PROJ. # XXXXXXX	LINE/PHASE	REVISION	
									SCALE AS NOTED CREATED 3/20/2024 CURRENT PROJ. # XXXXXXX	N.A. FLOOR/LEVEL	1	
								BRANDS	TITLE Plt1 Ames Mill Rail Unload Tunnel Removal		⊥	
				1	FOR REVIEW/ PERMIT	2/14/2025	PJD		SHEET TUNNEL REMOVAL AND WALL REPAIR PLAN	DRAWING NUMBER		
RE V.N□	DESCRIPTION	DATE (nn/dd/yy)	BY APPR'D	RE V.ND	DESCRIPTION	DATE (nn/dd/yy)	BY APP	PLANT #1 R'D NORTHFIELD, MN		S1.0		

- GENERATOR SUPPORT PAD- SEE CIVIL FOR SIZE AND LOCATION: PROVIDE 8" MINIMUM SLAB ON 12" GRANULAR BASE- REINF. w/ #45 AT 16"o.c. EACH WAY AT 2" CLR TO TOP OF SLAB- SEE GENERAL STRUCTURAL NOTES FOR




## RAIL UNLOAD TUNNEL REMOVAL AND FOUNDATION REPAIR PLAN

SCALE: 1/4" = 1'-0"

### FOUNDATION PLAN NOTES:

- I. F.F.E. INDICATES FINISHED FLOOR ELEVATION. EX. F.F.E. INDICATES EXISTING FINISHED FLOOR ELEVATION- VERIFY AS REQUIRED.
- 2. • ****** T.O.F. INDICATES TOP OF FOOTING ELEVATION (T.O.F.). EXISTING TOP OF FOOTING ELEVATIONS ARE ASSUMED AND SHOULD BE FIELD VERIFIED AS REQUIRED.
- 4. "EX." & "EXIST'G" INDICATES EXISTING CONSTRUCTION. EXIST'G MEMBER SIZES & DIMENSIONS ARE ASSUMED- FIELD VERIFY AS REQ'D. "F.V." & "VER." INDICATES THAT DIMENSION IS TO BE FIELD VERIFIED PRIOR TO MATERIAL FABRICATION, CONCRETE CONSTRUCTION, OR STEEL FABRICATION ETC... THE CONTRACTOR IS RESPONSIBLE FOR VERIFYING THE EXISTING STRUCTURE TO ENSURE PROPER FIT-UP OF ALL NEW CONSTRUCTION INFLUENCED BY EXISTING CONDITIONS. ALL DIMENSIONS MUST BE VERIFIED.
- 5. M.E. INDICATES MATCH EXISTING. CONTRACTOR TO VERIFY EXISTING ELEVATIONS, DIMENSIONS, ETC. AND MATCH NEW CONSTRUCTION TO EXISTING PRIOR TO MATERIAL FABRICATION.

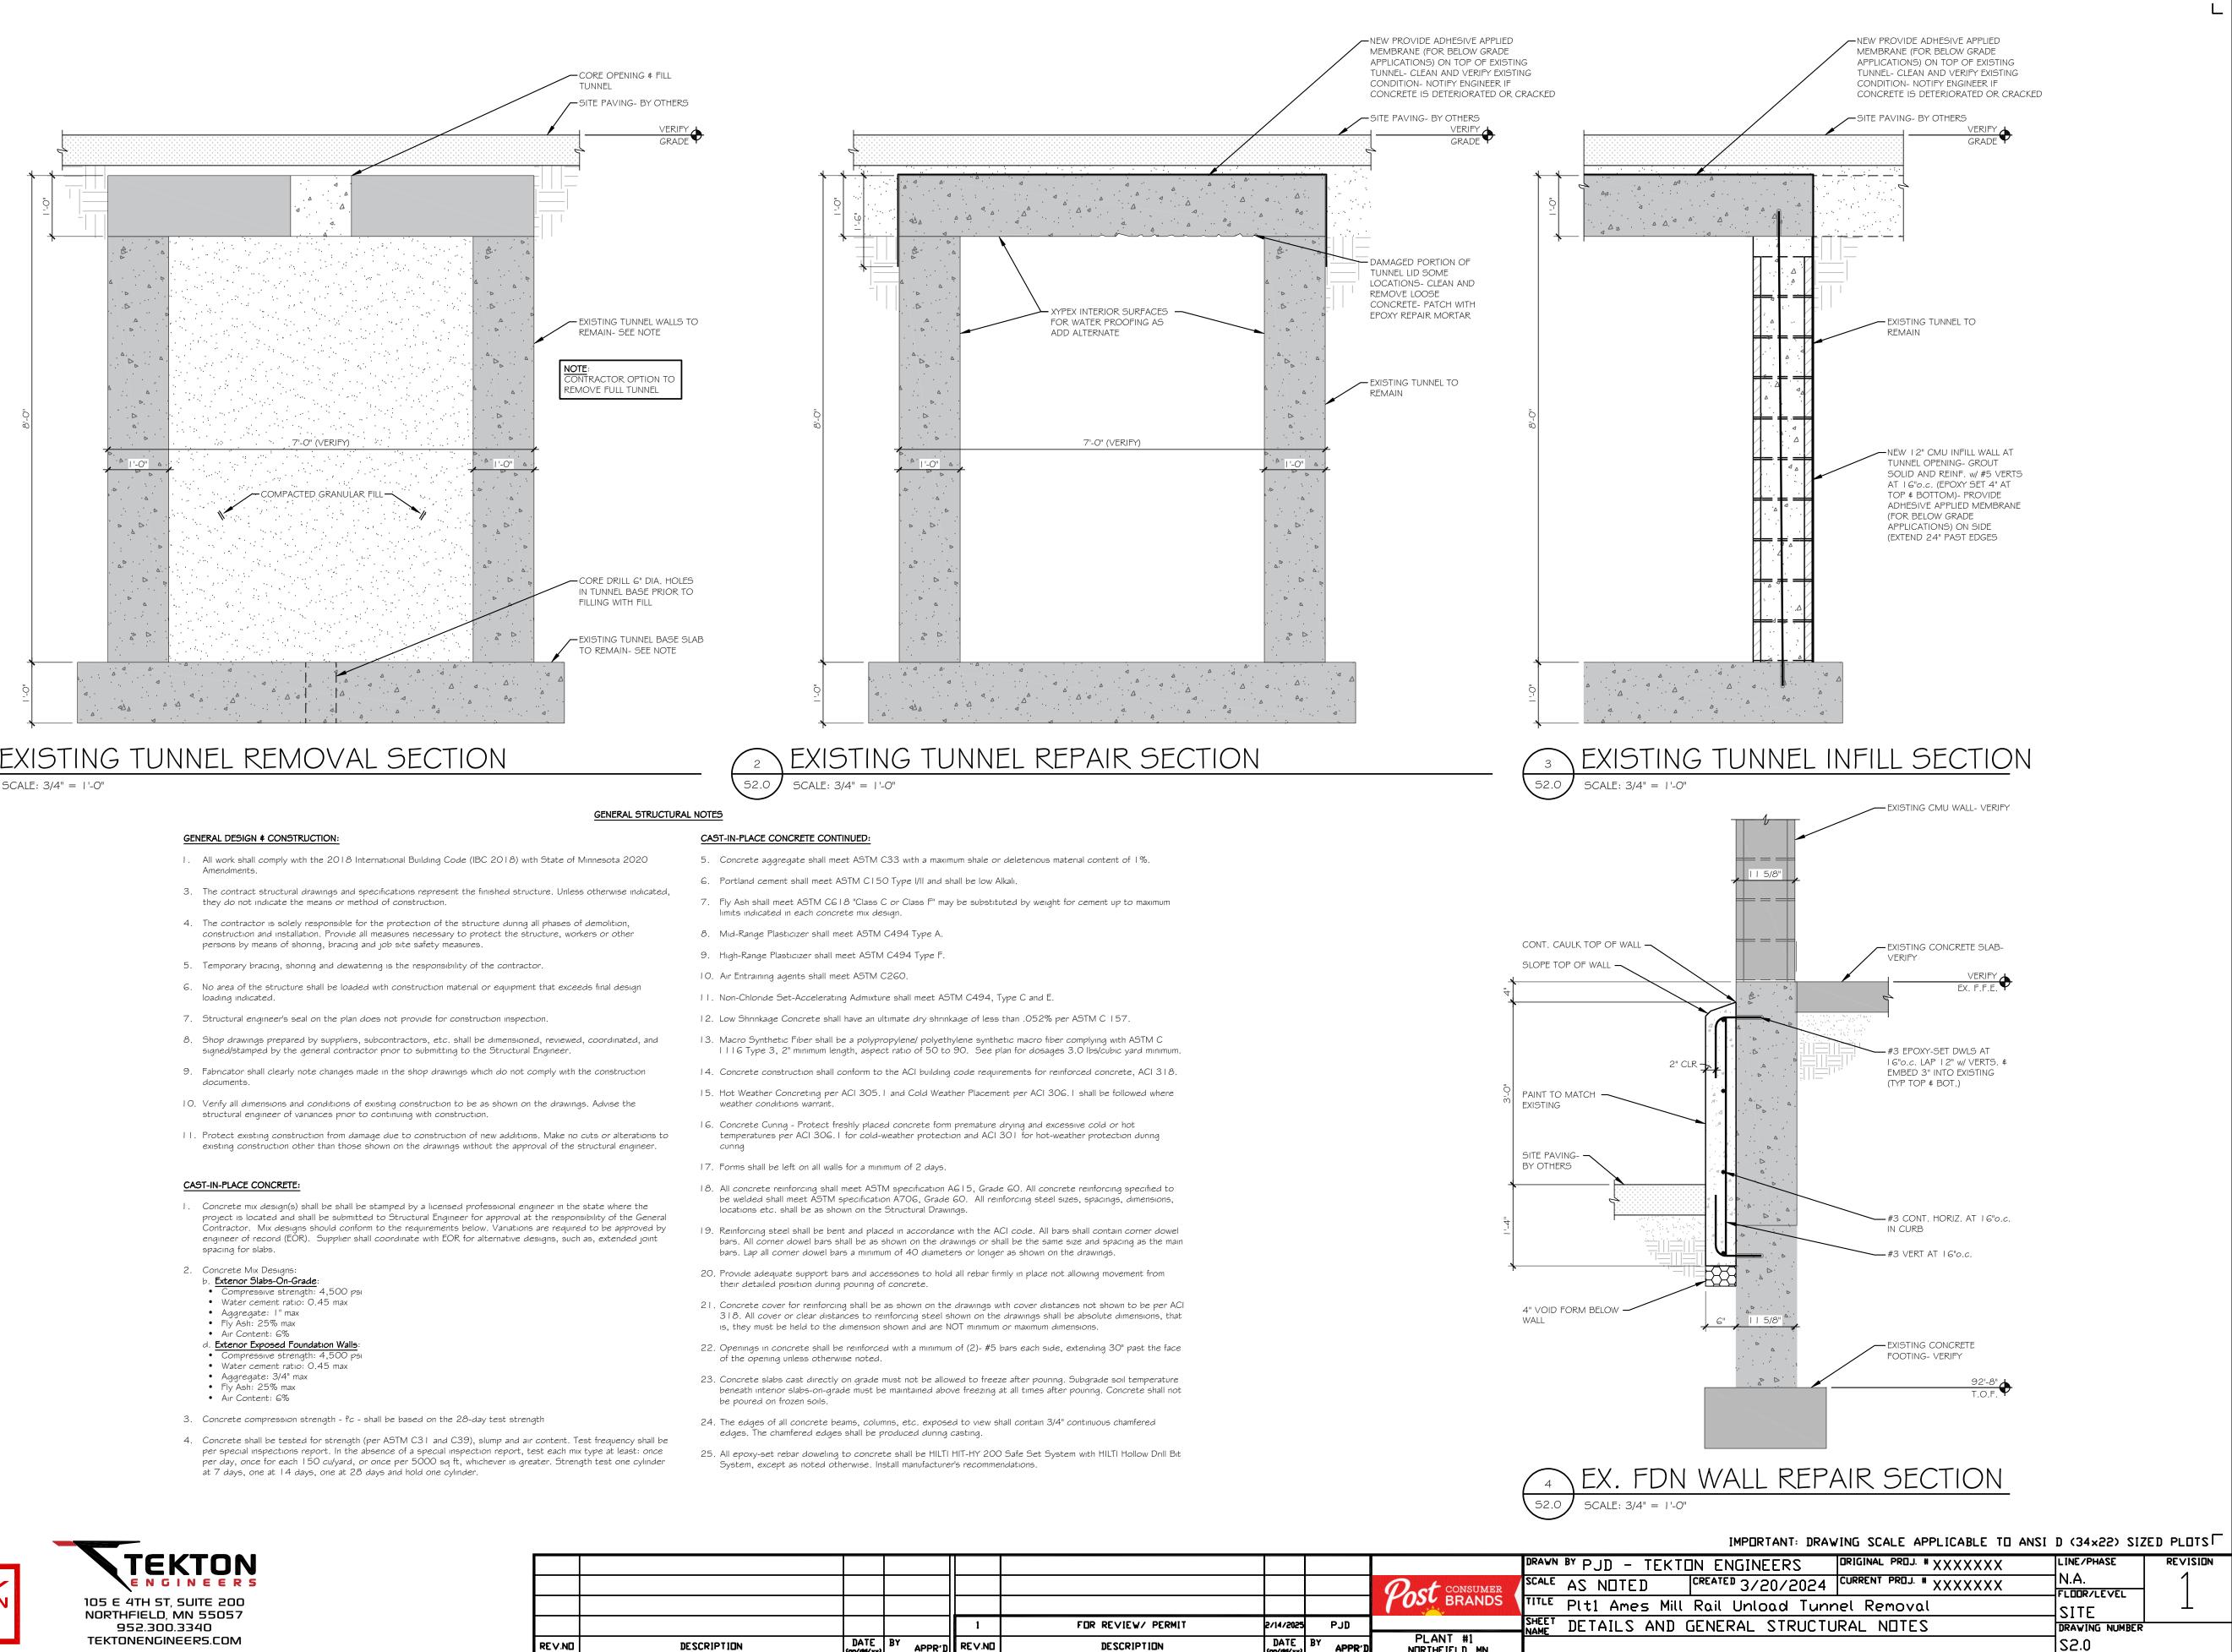

EXISTING TUNNEL REMOVAL SECTION SCALE: 3/4" = |'-0" S2.0

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PRELIMINARY NOT FOR CONSTRUCTION 2.14.2025

ſ											DRAW
ſ										CONSUMER	SCALE
ſ										BRANDS	TITLE
					1	FOR REVIEW/ PERMIT	2/14/2025		PJD		SHEE1
	RE V.ND	DESCRIPTION	DATE (m/dd/yy)	BY APPR'D	RE∨.ND	DESCRIPTION	DATE (nn/dd/yy)	BY	APPR' ]	1 PLANI#1 I	